fax 510.542.2201

REN. 12-31-25

PETALUMA REGIONALLIBRARY RENOVATION PROJECT NO. 10-19

100 FAIRGROUNDS DRIVE PETALUMA, CA 94952 BLDC-2023-0085 PERMIT SET - 11/20/2023

SONOMA COUNTY

REFER TO DEFERRED SUBMITTALS FOR ADDITIONAL REQUIREMENTS. CIVIL, FIRE PROTECTION, AND

HE WORK TO BE PERFORMED UNDER THIS CONTRACT INCLUDES THE FURNISHING OF ALL LABOR

EXTERIOR IMPROVEMENTS BY CÎTY ÔF PETALUMA, PUBLIC WORKS DEPT, ÉS UNDER PERMIT ... A BLDC -2024-0013 FOR PATH OF TRAVEL TO MAIN PUBLIC ENTRY, PUBLIC AND STAFF PARKING LOTS,


LIBRARY SECONDARY EXIT AND STAFF ENTRANCE PATHS WILL BE COMPLETED UNDER THE CITY OF PETALUMA PUBLIC WORKS DEPT. CONTRACTOR TO COORDINATE EXTERIOR ACCESS AROUND

PROJECT SUMMARY

MODIFICATIONS TO EXISTING ROOFING TO RECEIVE IT.

THE PROJECT IS AN RENOVATION OF AN EXISTING PUBLIC LIBRARY



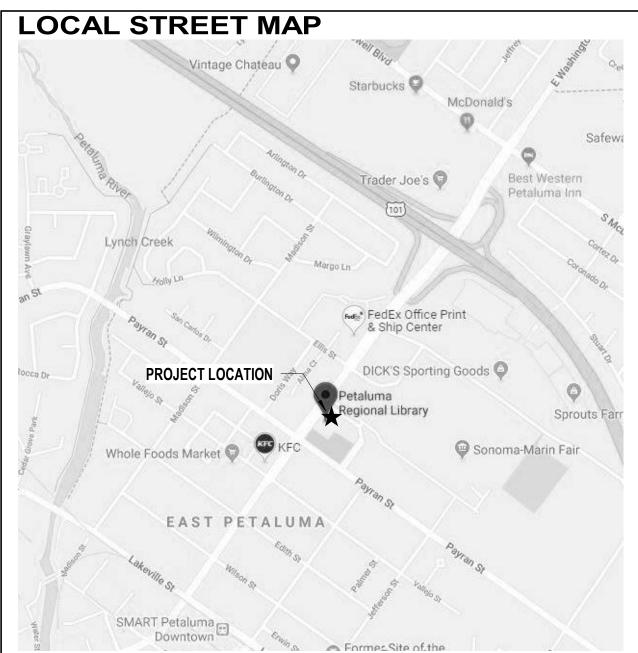

CALGreen Inspector


Santa Rosa, CA 95407

Tel: (707) 545 - 4440

SOLDATA Energy

Consulting, Inc.

P.O. Box 8579

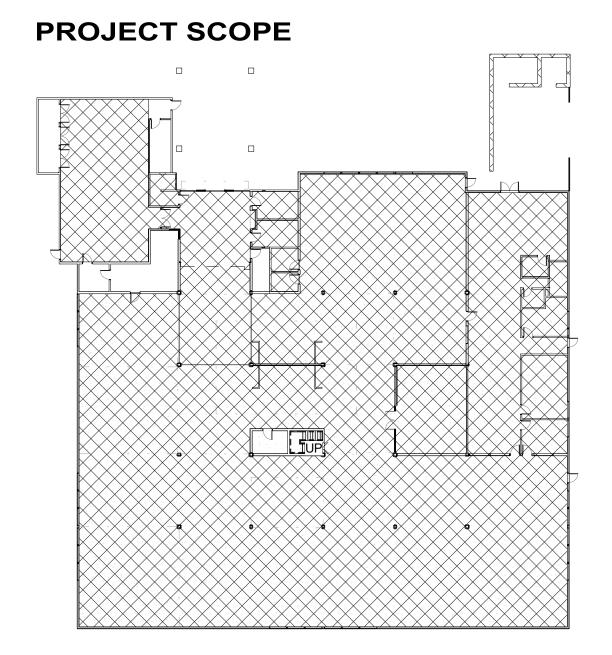

Electrical & IT

mack5 1900 Powell Street Suite 470 Emeryville CA 94609 Tel: (510) 595-3020

Cost Estimator

Guttman & Blaevoet

2351 Powell Street San Francisco, CA 94133 Tel: (415) 655-4000

Mechanical

Guttman & Blaevoet 2351 Powell Street San Francisco, CA 94133 Tel: (415) 655-4000

Structural **ZFA Structural Engineers**,

1212 Fourth Street Suite Z Santa Rosa, CA 95404 Tel: (707)526-0992

Architect

BUILDING AS REQUIRED.

Noll & Tam Architects 729 Heinz Ave Berkeley, CA 94710 Tel: 510.542.2200 Fax: 510.542.2201

Client

 \cdots

Sonoma County Library 6135 State Farm Drive Rohnert Park, CA 94928 Tel: 000.000.0000 Fax: 000.000.0000

SONOMA COUNTY PETALUMA REGIONAL LIBRARY RENOVATION PROJECT NO.

100 FAIRGROUNDS DRIVE PETALUMA, CA 94952

PERMIT SET

2 4/25/2024 RESUBMITTAL 2


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COVER SHEET

G0.00

APPROVALS

SHEET NUMBER

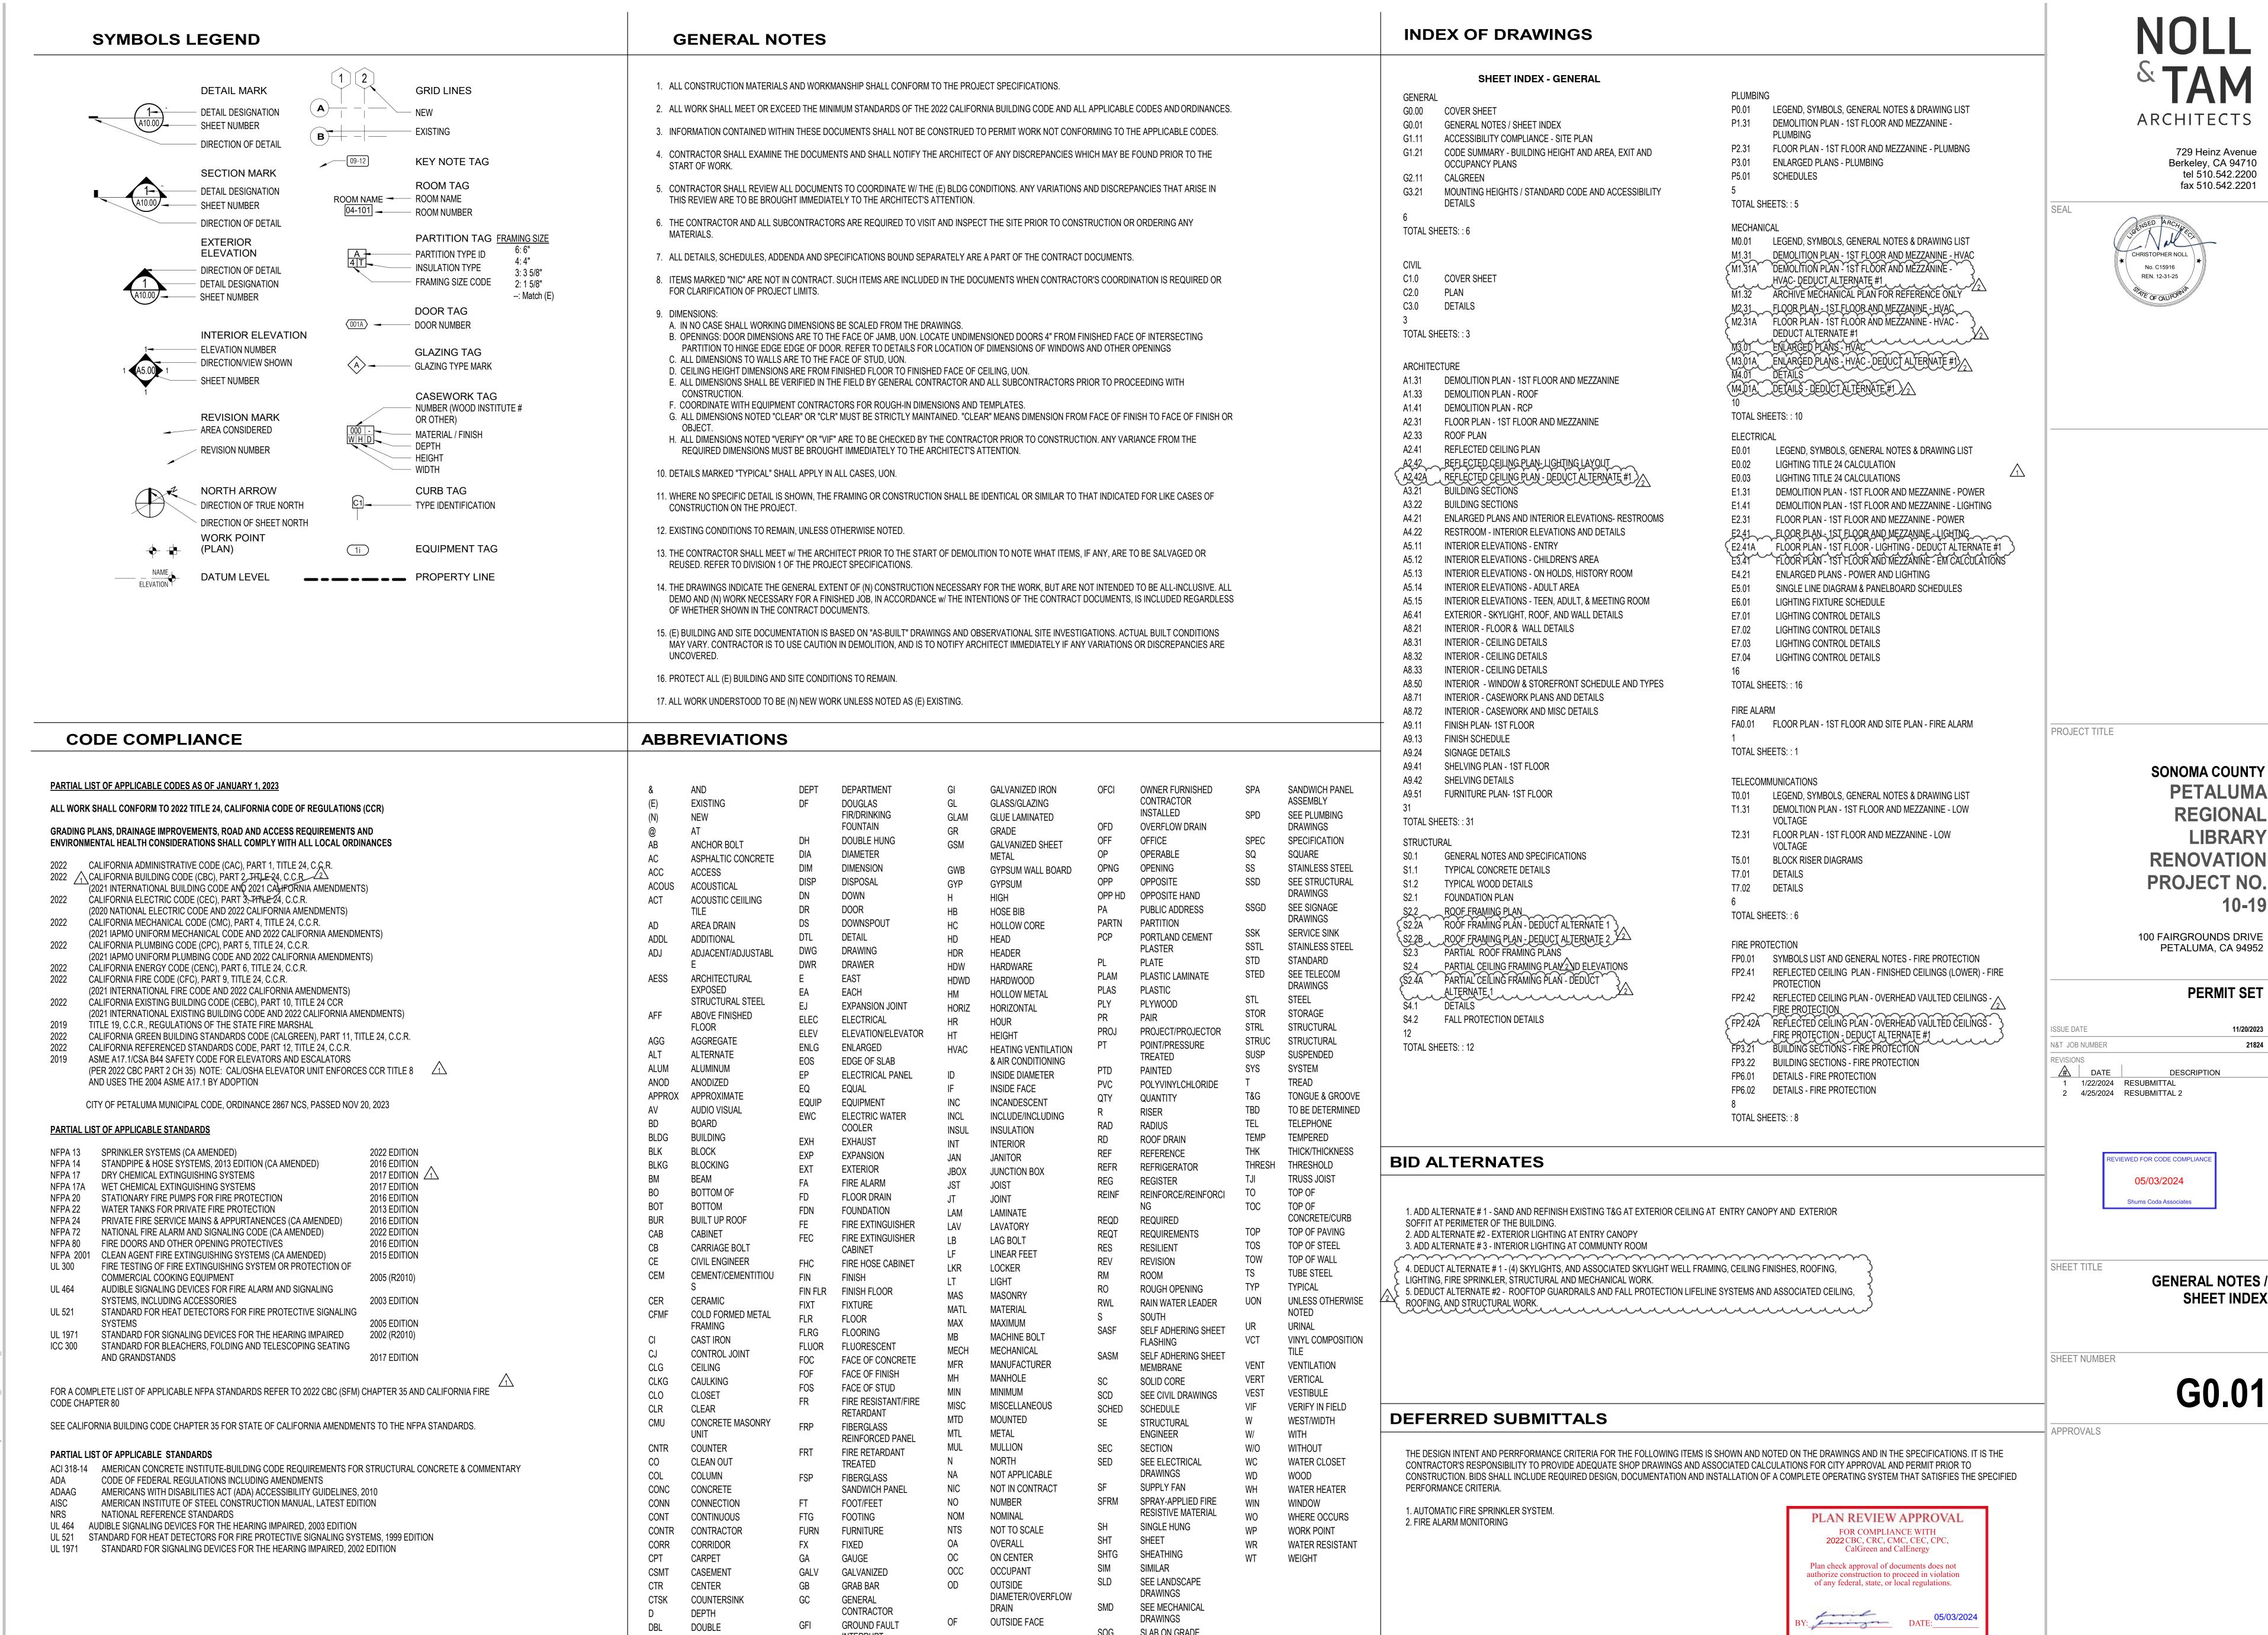

SLAB ON GRADE


SPACE


SHUMS CODA ASSOCIATES

INTERRUPT

DEMO

DEMOLITION

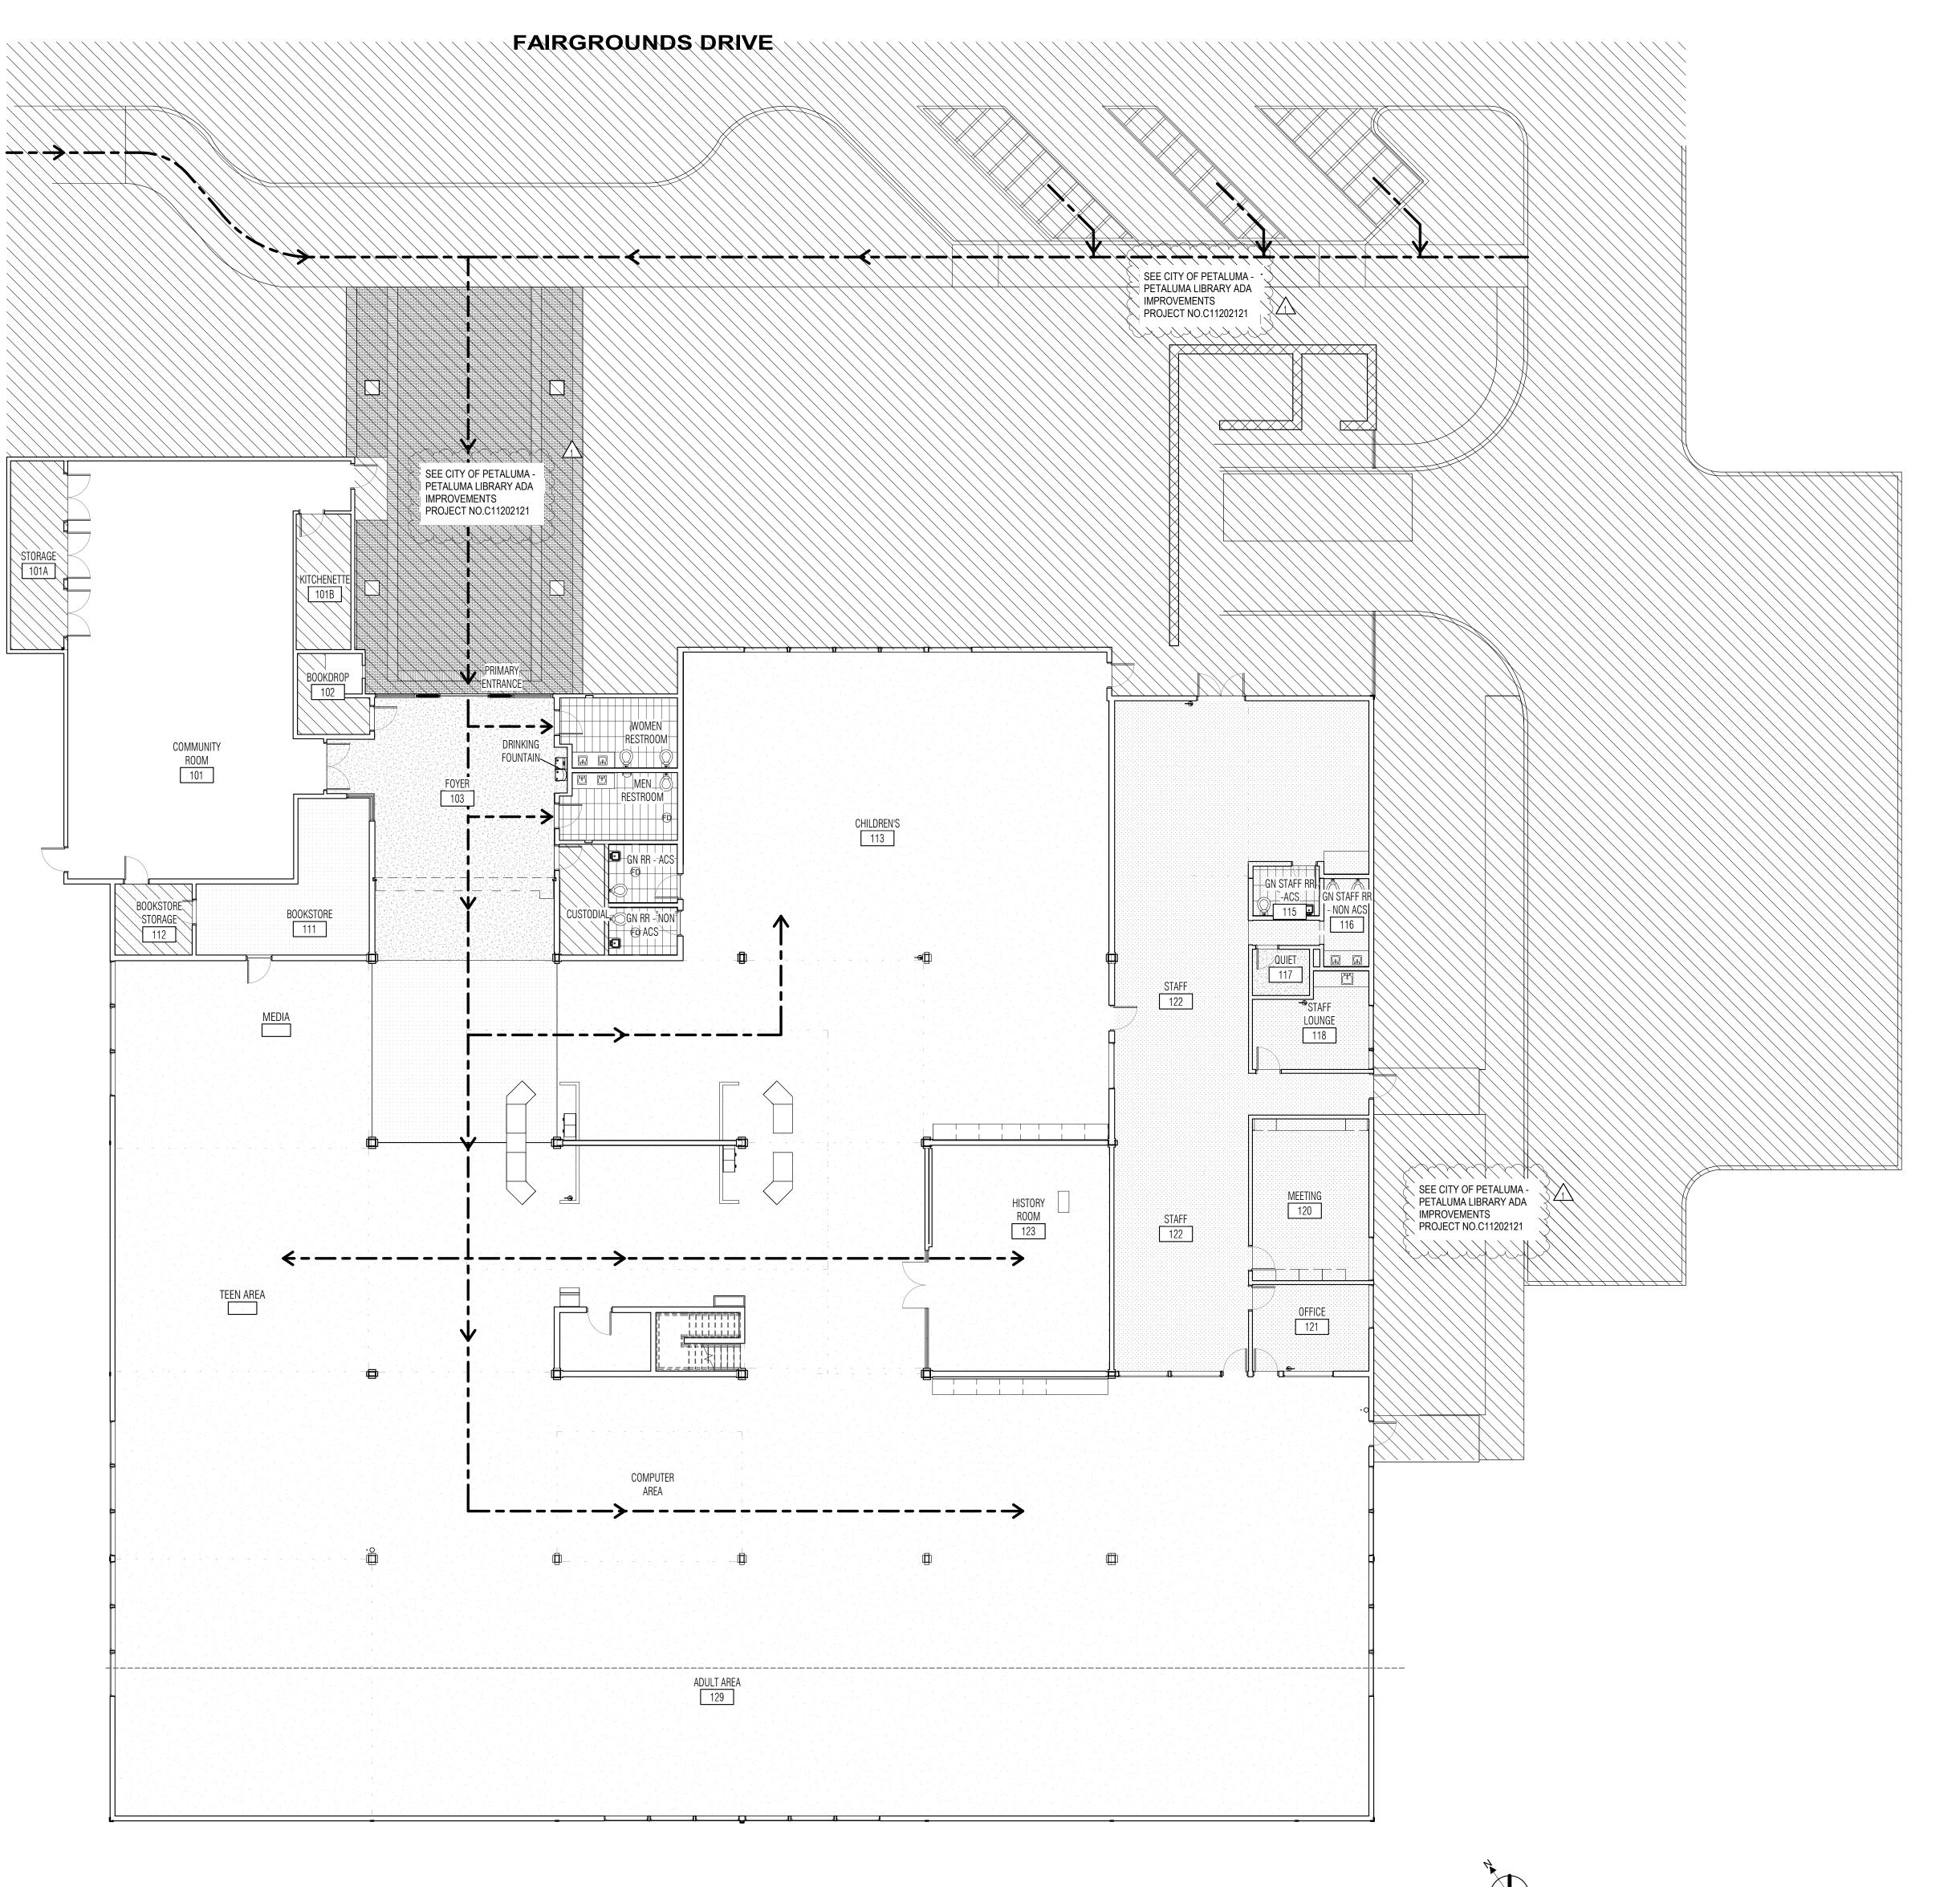

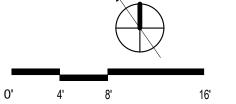





AREA WHERE WORK IS LIMITED TO



NO WORK IN AREA - EXTERIOR IMPROVEMENTS FOR PATH OF TRAVEL AND PARKING LOT TO BE COMPLETED BY THE CITY OF PETALUMA PUBLIC WORKS UNDER A SEPARATE PERMIT

ACCESSIBLE PATH OF TRAVEL

1. UPGRADES TO EXTERIOR/PUBLIC AREAS ARE THE RESPONSIBILITY OF THE CITY OF PETALUMA AS THE OWNER OF THE PROPERTY. THE CITY OF PETALUMA HAS PROJECTS PLANNED FOR THE LIBRARY SITE TO ADDRESS PATH OF TRAVEL FROM PARKING LOT TO FACILITY INTERIOR.

A. FRONT ENTRY BRICK WALK: REMOVAL OF EXISTING BRICK WALK AND REPLACEMENT WITH CONCRETE. A LEVEL LANDING TO EXTERIOR SLIDING DOORS AND SLOPE ADJUSTMENTS TO MEET ACCESSIBILITY REQUIREMENTS. B. STAFF PARKING LOT: ADD ACCESSIBLE PARKING SPACE AND REPLACE STAFF WALKWAY TO COMPLY WITH SLOPE AND WIDTH. ADDITIONAL WALK FROM OTHER EMERGENCY EXIT IS ALSO INCLUDED. C. FRONT DRIVE: RESURFACING OF PAVEMENT AND ADDITION OF ACCESSIBLE RAMP AT CROSSWALK AND

2. THERE ARE NO PUBLIC PHONES IN THE LIBRARY.

CORNERS OF EAST WASHINGTON ST.


3. TOILET ROOMS THAT SERVE AREA OF ALTERATION ARE SHOWN ON A4.21 INCLUDING NEW HI-LO DRINKING FOUNTAIN.

LEGEND



CARPET REPLACEMENT



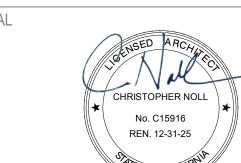

ARCHITECTS

729 Heinz Avenue

Berkeley, CA 94710 tel 510.542.2200

fax 510.542.2201

PROJECT TITLE

SONOMA COUNTY **PETALUMA REGIONAL LIBRARY RENOVATION** PROJECT NO.

100 FAIRGROUNDS DRIVE PETALUMA, CA 94952

DESCRIPTION

PERMIT SET

ISSUE DATE N&T JOB NUMBER

REVIEWED FOR CODE COMPLIANCE

05/03/2024

Shums Coda Associates


ACCESSIBILITY COMPLIANCE - SITE

SHEET NUMBER

SHEET TITLE

REVISIONS DATE

G1.11

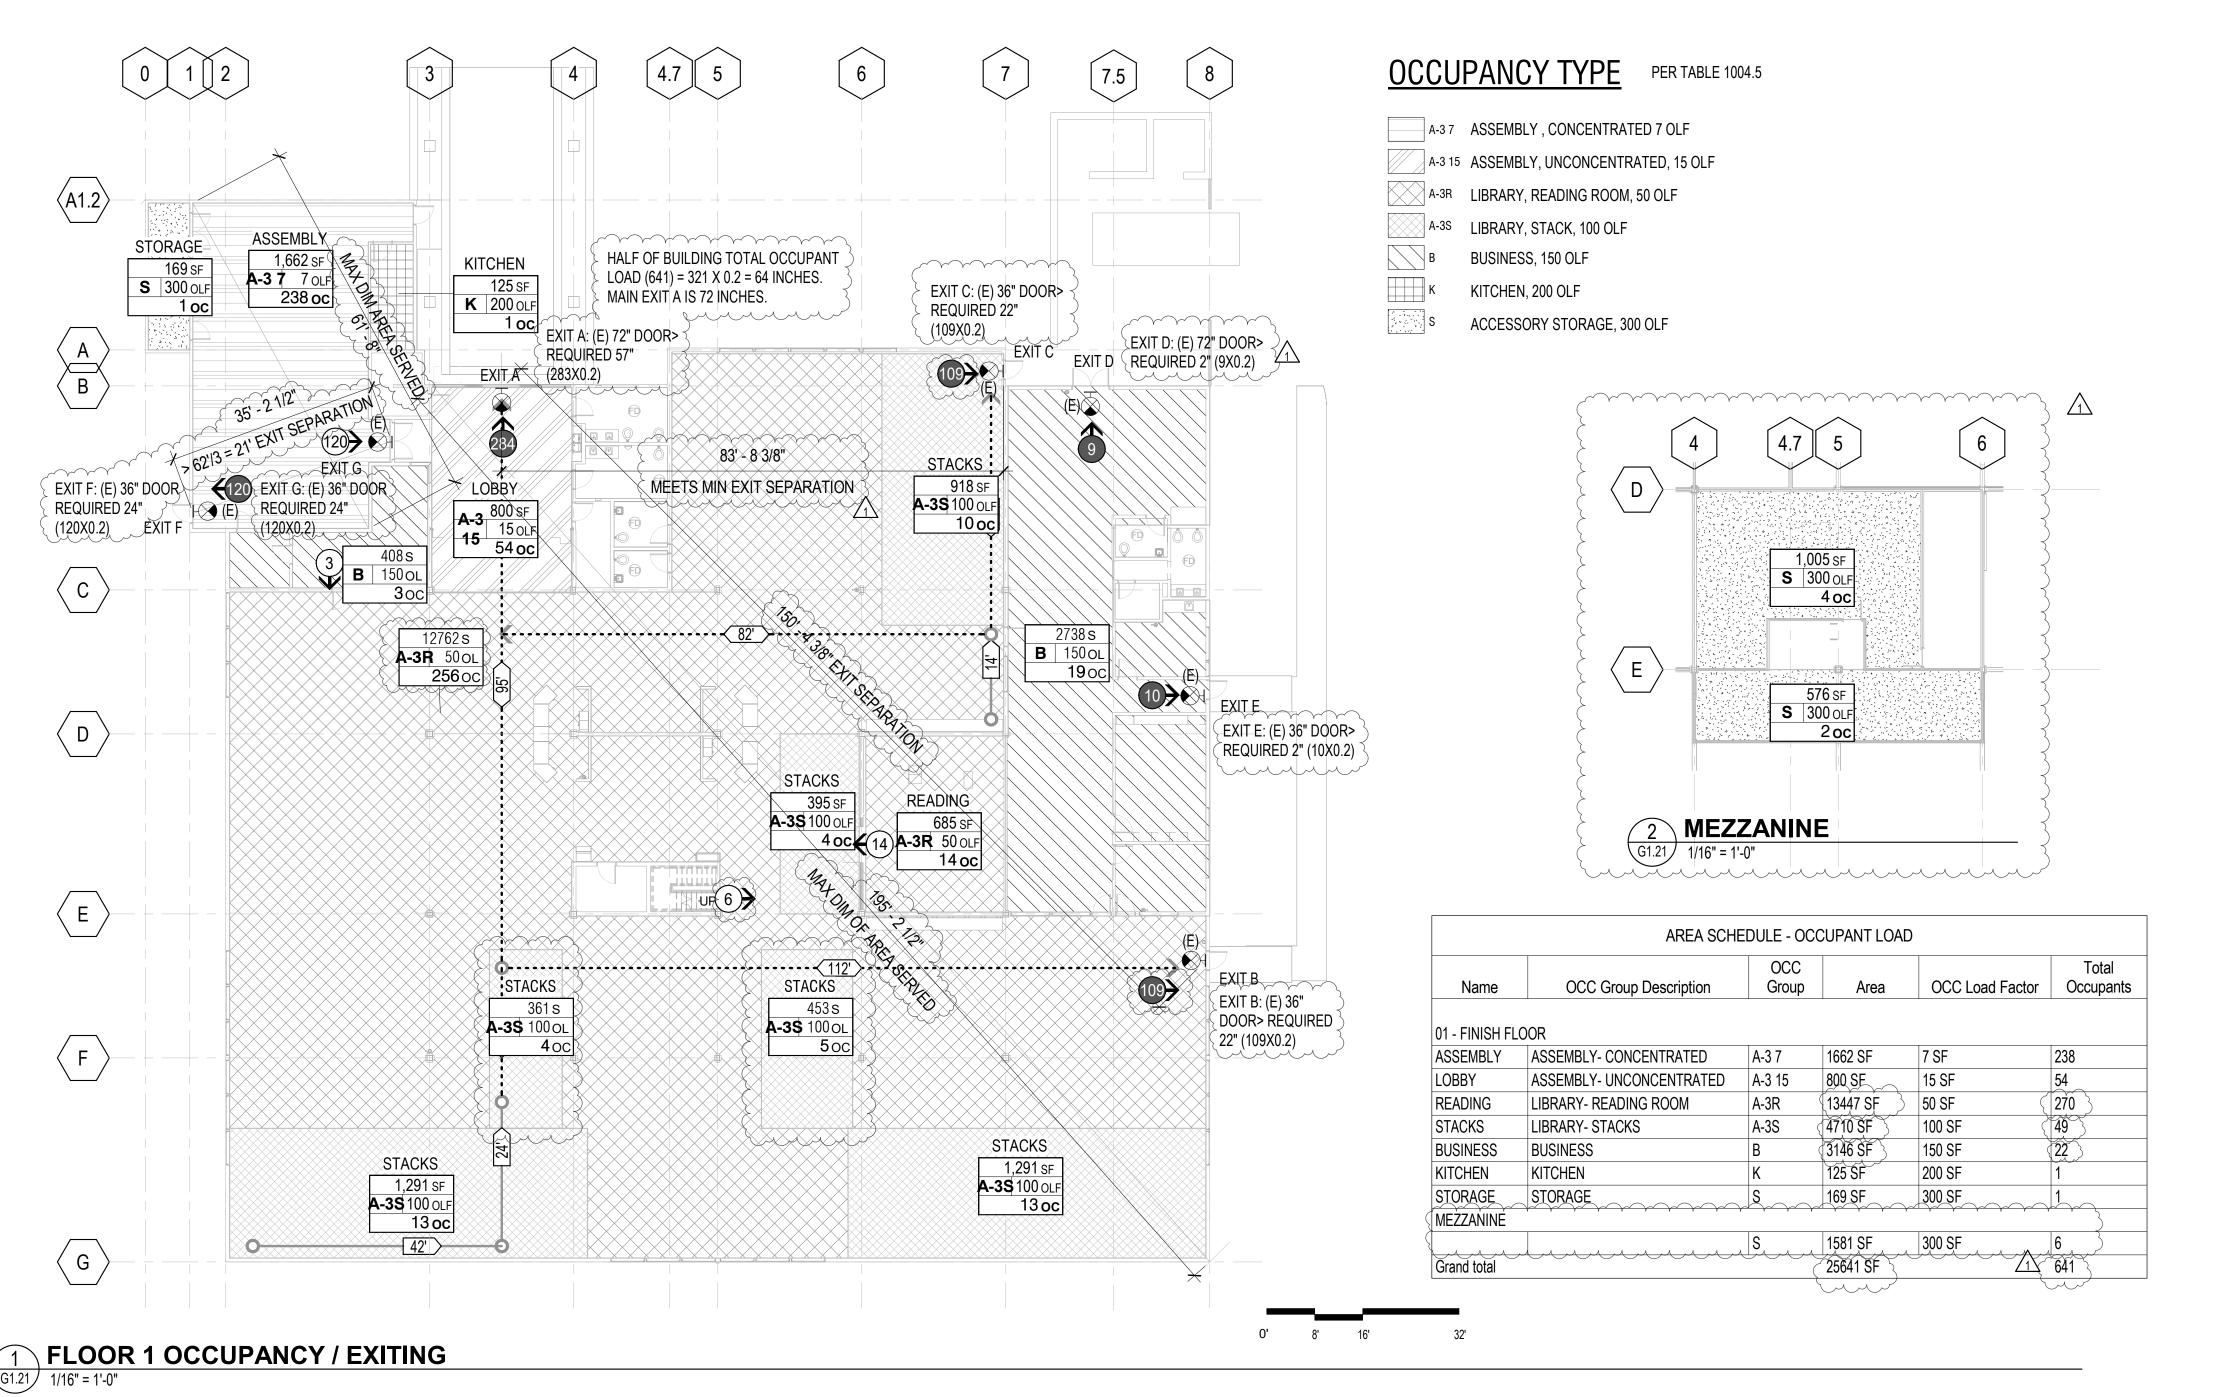

CODE SUMMARY

ADDRESS: 100 FAIRGROUNDS DR, PETALUMA CA 94952 OWNER: CITY OF PETALUMA. DEPT OF FACILITIES AND SERVICES

OCCUPANCY: GROUP A3 CONSTRUCTION: TYPE V-B 1 EXISTING BUILDING AREA: 24,822 SF + 1,125 SF = 25,947SF (AREA SUMMARY FROM THE 2003 MEETING ROOM EXPANSION PROJECT; CITY PROJECT_NO_9028)_______ EXISTING BUILDING AREA 25,947SF - MEZZANINE (1,959 SF) = 22,863 SF

(E) BUILDING STORIES: 1 GROUND FLOOR + MEZZANINE (E) BUILDING HEIGHT: 29'-0" MAX TO PARAPET AT ROOF

PER TABLE 505.4

PER TABLE 506.2

MAXIMUM AREA PER STORY:

MAXIMUM \$TORIES: FOR OCCUPANCY A-3, NS, TYPE V-B IS-1, STORY, MAXIMUM STORIES: FOR OCCUPANCY A-3, NS, TYPE V-B IS 1 MAXIMUM STORIES: FOR OCCUPANCY A-3, S (W/O AREA INCREASE), TYPE V-B IS 2 PÉR SÉC 505, MEZZANINE SHÁLL NOT CONTRIBUTE TO BUILDING AREA OR NUMBER OF STORIES. MEZZANINE CLEAR HEIGHT IS > 7 FT. (E) BUILDING STORY: 1 STORY

PER TABLE 504.3 MAXIMUM HEIGHT: FOR OCCUPANCY A, NS, TYPE V-B IS 40' :. 🤇 MĂXIMUM HEIĞHT: FÖR OCCÜPANCY A, Š (WİTH AREA INCREASE), TYPE V-B IS 40': 🖯 MAXIMUM HEIGHT: FOR OCCUPANCY A, S (WO AREA INCREASE), TYPE V-B IS 60' (E) BUILDING HEIGHT: 29'-0" MAX TO PARAPET AT ROOF:. OK <40'/60'

FOR OCCUPANCY A-3, NS, TYPE V-B IS 6,000 FOR OCCUPANCY A-3, S1, TYPE V-B IS 24,000 $\frac{1}{2}$ SPRINKLERS: NO IN THE 1974 MAIN LIBRARY AREA SPRINKLERS: YES-IN-NEW-SRACES-UNDER-THE, 2003-MEET, ING. ROOM, EXPANSION PROJECT SPRINKLERS EXTENDED TO REST OF BUILDING IN LIBRARY RENOVATION.

PER 508.3.1 NONSEPARATED OCCUPANCIES USE OF NONSEPARATED OCCUPANCIES WHEREBY MOST RESTRICTIVE PROVISIONS OF CHAP 9 APPLY TO NONSEPARATED OCCUPANCY. A-3 BUILDING RECEIVES AUTOMATIC SPRINKLERS THROUGHOUT.

PER 508.3.2 ALLOWABLE BUILDING AREA, HEIGHT, NUMBER STORIES - SHALL BE BASED ON MOST RESTRICTIVE ALLOWANCES FOR OCCUPANCY GROUPS.

BUILDING HEIGHT: B OCCUP: V-B: 60 FT SPRINKLERED BUILDING HEIGHT: A OCCUP: V-B: 40/60 FT SPRINKERED. MOST RESTRICTIVE IS A

BUILDING STORY: A OCCUP: V-B:1/2 STORIES SPRINKLERED, MOST RESTRICTIVE IS A BUILDING AREA: B OCCUP: V-B: S1: 36,000

BULDING AREA: A OCCUP: V-B; S1: 24,000, MOST RESTRICTIVE IS A PER 508.3.3 SEPARATION - NO SEPARATION REQUIRED BETWEEN NON-SEPARATED

NO CHANGE IN SQUARE FOOTAGE, STORY HEIGHT, STORIES, OF THE EXISTING BUILDING DURING THIS RENOVATION/REFRESH PROJECT.

PARKING REQUIREMENTS ARE UNDER REVIEW OF CITY OF PETALUMA PLANNING DEPARTMENT. NO NEW ADDITIONAL PARKING IS PROPOSED AS PART OF THIS RENOVATION/REFRESH PROJECT.

EXIT CALCULATIONS

BUILDING STORY: B OCCUP: V-B: 3 STORIES

MAIN READING ROOM AND STACK - 375 OCCUPANTS, (2) EXITS REQUIRED, (3) **EXISTING PROVIDED** EGRESS CAPACITY FACTOR 0.2 INCH/OCC.,

EXIT A - EXISTING 72 INCH DOOR > EXIT 280 X 0.2 = 56 INCH EXIT B - EXISTING 36 INCH CLR EXIT 108 X 0.2 = 22 INCH $\frac{1}{2}$ EXIT C - EXISTING 36 INCH CLR ≥ EXIT 125 X 0.2 = 24 INCH

STAFF AREA - 19 OCCUPANTS, (1) EXIT REQUIRED, (2) EXITS EXISTING PROVIDED EGRESS CAPACITY FACTOR 0.2 INC/OCC, EACH EXIT 10 X 0.2 = 2 INCH

EXIT D - EXISTING 72 INCH CLR > EXIT 9 X 0.2 = 2 INCH EXIT E - EXISTING 36 INCH CLR> EXIT 10 X 0.2 = 2 INCH

COMMUNITY ROOM - 240 OCCUPANTS, (2) EXITS REQUIRED. EXIT F - EXISTING 36 INCH CLR > EXIT 120 X 0.2 = 24 INCH EXIT G - EXISTING 72 INCH CLR>EXIT 120 X 0.2 = 24 INCH

EXITS PLACED A DISTANCE APART EQUAL TO NOT LESS THAN 1/2 LENGTH OF MAXIMUM DIAGONAL DISTANCE. WHERE BUILDING EQUIPPED WITH AUTOMATIC SPRINKLER, SEPARATION SHALL NOT LESS THAN 1/3 OF LENGTH OF MAX OVERALL DIAGONAL DIMENSION OF AREA SERVED. \triangle

ACCESS TRAVEL DISTANCE -MAX TRAVEL DISTANCE (CBC 1017.2) A OCCUPANCY, B OCCUPANCY = 200 (W/O SPRINKLER), 250 (WITH SPRINKLER)

COMMON PATH OF EGRESS TRAVEL (CBC 1006.2.1) A OCCUPANCY = OL>30 =75'; OL<30 = 75'; 75' (W/ SPRINKLER) B OCCUPANCY = OL>30 =75'; OL<30 = 100; 100' (W/SPRINKLER)

CBC 1030.2 INDICATES BUILDING, ROOM OR SPACE WITH OCCUPANT LOAD GREATER THAN 300, MAIN EXIT TO ACCOMMODATE NOT LESS THAN ½ OCCUPANT

PUBLIC AREAS OF THE LIBRARY HAS OVERALL OCCUPANT LOAD GREATER THAN \$\frac{300}{READING: 270 +: STACKS: 49 +LOBBY:54+ COMMUNITY: 240 = 613. HALF OF 613 \triangleright OCCUPANTS = 306.5 X 0.2 = 61.3INCHES) EXIT A IS 72 INCHES AND WILL SERVE HALF OF THE OCCUPANTS. STAFF AREAS – BUSINESS AREAS ARE NOT ASSEMBLY SPACES SERVED BY THE EXIT A. IF IT IS INCLUDED WITH TOTAL BUILDING OCCUPANT LOAD OF 635. HALF OF OCCUPANT LOAD IS 317.5 X 0.2 = 63.5 INCHES $^{\succ}$ REQUIED EGRESS WIDTH< 72 INCHES OF MAIN EXIT A. www.www.www


SYMBOL LEGEND

ASSEMBLY-UNCONCENTRATED OCCUPANCY TYPE DESCRIPTION 4,000 sf TOTAL ROOM AREA IN SQUARE FEET A-3 200 OLF OCCUPANT LOAD FACTOR PER CBC TABLE 1004.1.2 20 oc TOTAL ROOM OCCUPANCY OCCUPANCY TYPE PER CBC TABLE 1004.1.2

13' COMMON PATH OF EGRESS TRAVEL PER CBC SECTION 1014.3 •••••• EXIT ACCESS TRAVEL DISTANCE PER CBC SECTION 1016.1

ARCHITECTS

729 Heinz Avenue Berkeley, CA 94710 tel 510.542.2200 fax 510.542.2201

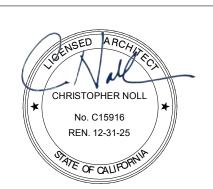

PROJECT TITLE

SONOMA COUNTY PETALUMA REGIONAL LIBRARY RENOVATION PROJECT NO.

100 FAIRGROUNDS DRIVE PETALUMA, CA 94952

PERMIT SET

ISSUE DATE 11/20/2023 N&T JOB NUMBER REVISIONS DESCRIPTION 1 1/22/2024 RESUBMITTAL

> REVIEWED FOR CODE COMPLIANCE 05/03/2024


> > Shums Coda Associates

SHEET TITLE

CODE SUMMARY -BUILDING HEIGHT AND AREA, EXIT AND OCCUPANCY PLANS

SHEET NUMBER

G1.21

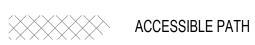

A5.602 CALGreen VERIFICATION GUIDELINES MANDATORY MEASURES CHECKLIST

Application: This checklist shall be used for nonresidential projects that meet one of the following: new construction, building additions of 1,000 square feet or greater, or building alterations with a permit valuation of \$200,000 or more pursuant to Section 301.3 AND do not trigger a Tier 1 or Tier 2 requirement:

Y = Yes (section has been selected and/or included) N/A = Not Applicable (code section does not apply to the project—mainly used for additions and alterations) O = Other (provide explanation)

[N] = New construction pursuant to Section 301.3
[A] = Additions and/or Alterations pursuant to Section 301.3

CHAPTER 5 DIVISIONS		SECTION TITLE	CODE SECTION	Υ	N/A	o	PLAN SHEET, SPEC OR ATTACH REFERENCE
DIVISION 5.1 Planning and Design	Mandatory	Storm water pollution prevention for projects that disturb less than 1 acre of land	5.106.1 through 5.106.2		Х		
	Mandatory	Short-term bicycle parking (with exception)	5.106.4.1.1		Х		
	Mandatory	Long-term bicycle parking	5.106.4.1.2 through 5.106.4.1.5		Х		
	Mandatory	Electric vehicle (EV) charging [N] w/ exceptions	5.106.5.3		Х		
	Mandatory	EV capable spaces [N]	5.106.5.3.1		Х		
	Mandatory	Electric vehicle charging stations (EVCS)	5.106.5.3.2		Х		
	Mandatory	Use of automatic load management systems (ALMS)	5.106.5.3.3		Х		
	Mandatory	Accessible EVCS	5.106.5.3.4		Х		
	Mandatory	Note for EVCS signs			Х		-
	Mandatory	Table 5.106.5.3.1 w/ footnotes	5.106.3.1, 5.106.3.2 and 5.106.3.3		X		
	Mandatory	Electric vehicle (EV) charging: medium-duty and heavy-duty [N]	5.106.5.4		Х		
	Mandatory	Electric vehicle charging readiness requirements for ware- houses, grocery stores and retail stores with planned off- street loading spaces [N]	5.106.5.4.1		Х		
	Mandatory	Table 5.106.5.4.1	5.106.5.4 and 5.106.5.4.1		Х		
	Mandatory	Light pollution reduction [N] (with exceptions, notes and table)	5.106.8 through 5.106.8.2		Х		
	Mandatory	Grading and paving (exception for additions and alterations not altering the drainage path)	5.106.10		Х		
DIVISION 5.2 Energy Efficiency	Mandatory	Meet the minimum energy efficiency standard	5.201.1	х			Title 24 Repor
DIVISION 5.3 Water	Mandatory	Separate meters (new buildings or additions > 50,000 sf that consume more than 100 gal/day)	5.303.1.1		Х		
Efficiency and Conservation (continued)	Mandatory	Separate meters (for tenants in new buildings or additions that consume more than 1,000 gal/day)	5.303.1.2		Х		1
(COMMINGU)				_			

SECTION TITLE

Mandatory Multiple showerheads serving one shower shall have a combined flow rate of 1.8 gpm at 80 psi 5.303.3.3.2

Mandatory Water closets shall not exceed 1.28 gallons per flush (gpf) 5.303.3.1

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(continued) | Mandatory | Wall-mounted urinals shall not exceed 0.125 gpf

Conservation

Single showerhead shall have maximum flow rate of 1.8 gpm (gallons per minute) at 80 psi

5.303.3.3.1

Water | Mandatory | Floor-mounted urinals shall not exceed 0.5 gpf

Mandatory Nonresidential lavatory faucets

Mandatory | Metering faucets for wash fountains

Mandatory Areas of additions or alterations

Mandatory | Standards for plumbing fixtures and fittings

Mandatory | Moisture control: exterior door protection

Mandatory | Recycling by occupants (with exception)

Mandatory | Recycling by occupants: sample ordinance

Mandatory | Commissioning new buildings (≥ 10,000 sf) [N]

Mandatory | Moisture control: flashing

Mandatory Universal waste [A]

Mandatory Basis of Design (BOD) [N]

gent local ordinance

Mandatory Outdoor potable water use in landscape areas (with notes) 5.304.1

Construction waste management—comply with either: 5.408.1.1.

Mandatory | Construction waste management: documentation | 5.408.1.4 | X

Mandatory | Sections 5.408.1.1, 5.408.1.2, 5.408.1.3 or more strin- | 5.408.1.2,

Mandatory Excavated soil and land clearing debris (100% reuse or recycle) 5.408.3

Mandatory | Recycling by occupants: additions (with exception) | 5.410.1.1

Mandatory Owner's or owner representative's Project Requirements (OPR) [N]

5.410.2.1

(continued)

Mandatory | Kitchen faucets

Mandatory | Wash fountains

Mandatory | Metering faucets

Mandatory | Pre-rinse spray valve

Mandatory Food waste disposers

DIVISION 5.4 | Mandatory | Weather protection

Conservation | Mandatory | Moisture control: sprinklers

PROJECT TITLE

SONOMA COUNTY PETALUMA

100 FAIRGROUNDS DRIVE PETALUMA, CA 94952

PERMIT SET

ISSUE DATE 11/27/2023 N&T JOB NUMBER 21824 REVISIONS DESCRIPTION

> REVIEWED FOR CODE COMPLIANCE 05/03/2024

> > Shums Coda Associates

SHEET TITLE

CALGREEN

SHEET NUMBER

G2.11

APPROVALS

CHAPTER 5 DIVISIONS		SECTION TITLE	CODE SECTION	Y	N/A	o	PLAN SHEET, SPEC OR ATTACH REFERENCE	
(continued) DIVISION 5.4	Mandatory	Commissioning plan [N]	5.410.2.3		Х			
Material	Mandatory	Functional performance testing [N]	5.410.2.4		Х			
Conservation and Resource	Mandatory	Documentation and training [N]	5.410.2.5		Х			
Efficiency	Mandatory	Systems manual [N]	5.410.2.5.1		Х			
	Mandatory	Systems operation training [N]	5.410.2.5.2		Х			
	Mandatory	Commissioning report [N]	5.410.2.6		Х			
	Mandatory	Testing and adjusting for new buildings < 10,000 sf or new systems that serve additions or alterations [A]	5.410.4	Х			Future submittal; testing and reporting by	
	Mandatory	System testing plan for renewable energy, landscape irrigation and water reuse [A]	5.410.4.2	Х			installing contractors for NEW SYSTEMS: 1.	
	Mandatory	Procedures for testing and adjusting	5.410.4.3	Х			HVAC, 2. Indoor Water Heating, 3. Indoor & Outdoor	
	Mandatory	Procedures for HVAC balancing	5.410.4.3.1	X			Lighting, 4. Renewable	
	Mandatory	Reporting for testing and adjusting	5.410.4.4	Х			Systems, 5. Landscaping	
	Mandatory	Operation and maintenance (O&M) manual	5.410.4.5	Х			Provide copy of O&M	to inspec
	Mandatory	Inspection and reports	5.410.4.5.1	Х				
DIVISION 5.5 Environmental	Mandatory	Fireplaces	5.503.1		Х			
Quality	Mandatory	Woodstoves	5.503.1.1		Х			
(continued)	Mandatory	Temporary ventilation	5.504.1	Х			It temporary venti needed during cons 8 filters must be	truction, 1
	Mandatory	Covering of ducts openings and protection of mechanical equipment during construction	5.504.3	Х			HVAC Installer to dinstallationcan lime of register in	cover ducts be removed
	Mandatory	Adhesives, sealants and caulks	5.504.4.1	X			See product specs	
	Mandatory	Paints and coatings	5.504.4.3	Х			See product specs	
	Mandatory	Aerosol paints and coatings	5.504.4.3.1	Х			See product specs	
	Mandatory	Aerosol paints and coatings: verification	5.504.4.3.2	Х			See product specs	
	Mandatory	Carpet systems	5.504.4.4	Х			See product specs	
	Mandatory	Carpet cushion	5.504.4.4.1	Х			See product specs	
	Mandatory	Carpet adhesives per Table 5.504.4.1	5.504.4.4.2	Х	See prod	See product specs		
	Mandatory	Composite wood products	5.504.4.5 X		See product specs			
	MandatoryComposite wood products: documentation5.504.4.5.3MandatoryResilient flooring systems5.504.4.6	Х			See product specs			
			Х			•		
	Mandatory	Resilient flooring: verification of compliance	5.504.4.6.1		Х			-
	Mandatory	Thermal insulation	5.504.4.7	Х			See product specs	
	Mandatory	Verification of compliance	5.504.4.7.1	Х			See product specs	-
	Mandatory	Acoustical ceilings and wall panels	5.504.4.8	Х			See product specs	-
	Mandatory	Verification of compliance	5.504.4.8.1	Х			See product specs	:

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APPENDIX A5—NONRESIDENTIAL VOLUNTARY MEASURES

CHAPTER 5 DIVISIONS		SECTION TITLE	CODE SECTION	Y	N/A	0	PLAN SHEET, SPEC OR ATTACH REFERENCE	
(continued) DIVISION 5.5	Mandatory	Filters (with exceptions)	5.504.5.3	Х			MERV 13 filters to be confirmed	
nvironmental	Mandatory	Filters: labeling	5.504.5.3.1	Х			inspection	
Quality	Mandatory	Environmental tobacco smoke (ETS) control	5.504.7		Х			
	Mandatory	Indoor moisture control	5.505.1		Х			
	Mandatory	Outside air delivery	5.506.1		Х			
	Mandatory	Carbon dioxide (CO ₂) monitoring	5.506.2		Х			1
	Mandatory	Acoustical control (with exception)	5.507.4		Х			
	Mandatory	Exterior noise transmission, prescriptive method (with exceptions)	5.507.4.1		Х			
	Mandatory	Noise exposure where noise contours are not readily available	5.507.4.1.1		Х			
	Mandatory	Performance method	5.507.4.2		Х			
	Mandatory	Site features	5.507.4.2.1		X			
	Mandatory	Documentation of compliance	5.507.4.2.2		Х			
	Mandatory	Interior sound transmission (with note)	5.507.4.3		X			
	Mandatory	Ozone depletion and greenhouse gas reductions	5.508.1		Х			
	Mandatory	Chlorofluorocarbons (CFCs)	5.508.1.1		Х			
	Mandatory	Halons	5.508.1.2		X			
	Mandatory	Supermarket refrigerant leak reduction for retail food stores 8,000 square feet or more Sections 5.508.2 through 5.508.2.6.3	5.508.2 through 5.508.2.6.3		Х			
	1-	END OF MANDATORY PROVISIONS						

Documentation Author's / Responsible Designer's Declaration	tion Statement
Mandatory: I attest that this mandatory provisions ch	ecklist is accurate and complete.
Signature:	
Company:	Date:
Noll & Tam Architects	11/29/2023
Address:	License:
729 Heinz Ave	C15916
City/State/Zip:	Phone:
Berkelev, CA 94710	510 542-2211

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CHAPTER 5 DIVISIONS

Material

and Resource

Efficiency (continued)

DIVISION 5.3

Efficiency and

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Berkeley, CA 94/10 510 542-2211

Petaluma Library Renovation 100 Fairgrounds Dr, Petaluma CA

APPENDIX A5—NONRESIDENTIAL VOLUNTARY MEASURES

CODE SECTION

5.303.3.2.2

5.303.3.4.1

5.303.3.4.2 5.303.3.4.3

5.303.3.4.4

5.303.3.4.5

5.303.3.4.6

X

X

X

X Code

5.303.4.1

5.303.5

5.303.6

5.407.1

5.407.2.1

5.407.2.2.1

5.407.2.2.2

5.408.2

5.410.1

5.410.1.2

5.410.2.2

5.410.2

5.303.3.2.1 X

PLAN SHEET,

REFERENCE

0.125 gallons per flush for

Project to recycle and/or salvage minimum of 65% of non-hazardous construction waste; must submit either

waster must submit either
waste management plan or use
waste management company.
GC to document that
Universal waste (such as
batteries, e-waste, lamps,
cathode ray tubes/glass,
aerosol cans) were
of properly

X during CALGreen


APPENDIX A5-29


Y N/A O SPEC OR ATTACH

tel 510.542.2200 fax 510.542.2201

729 Heinz Avenue

Berkeley, CA 94710

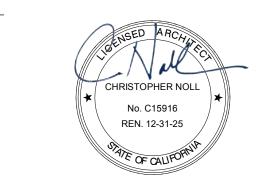


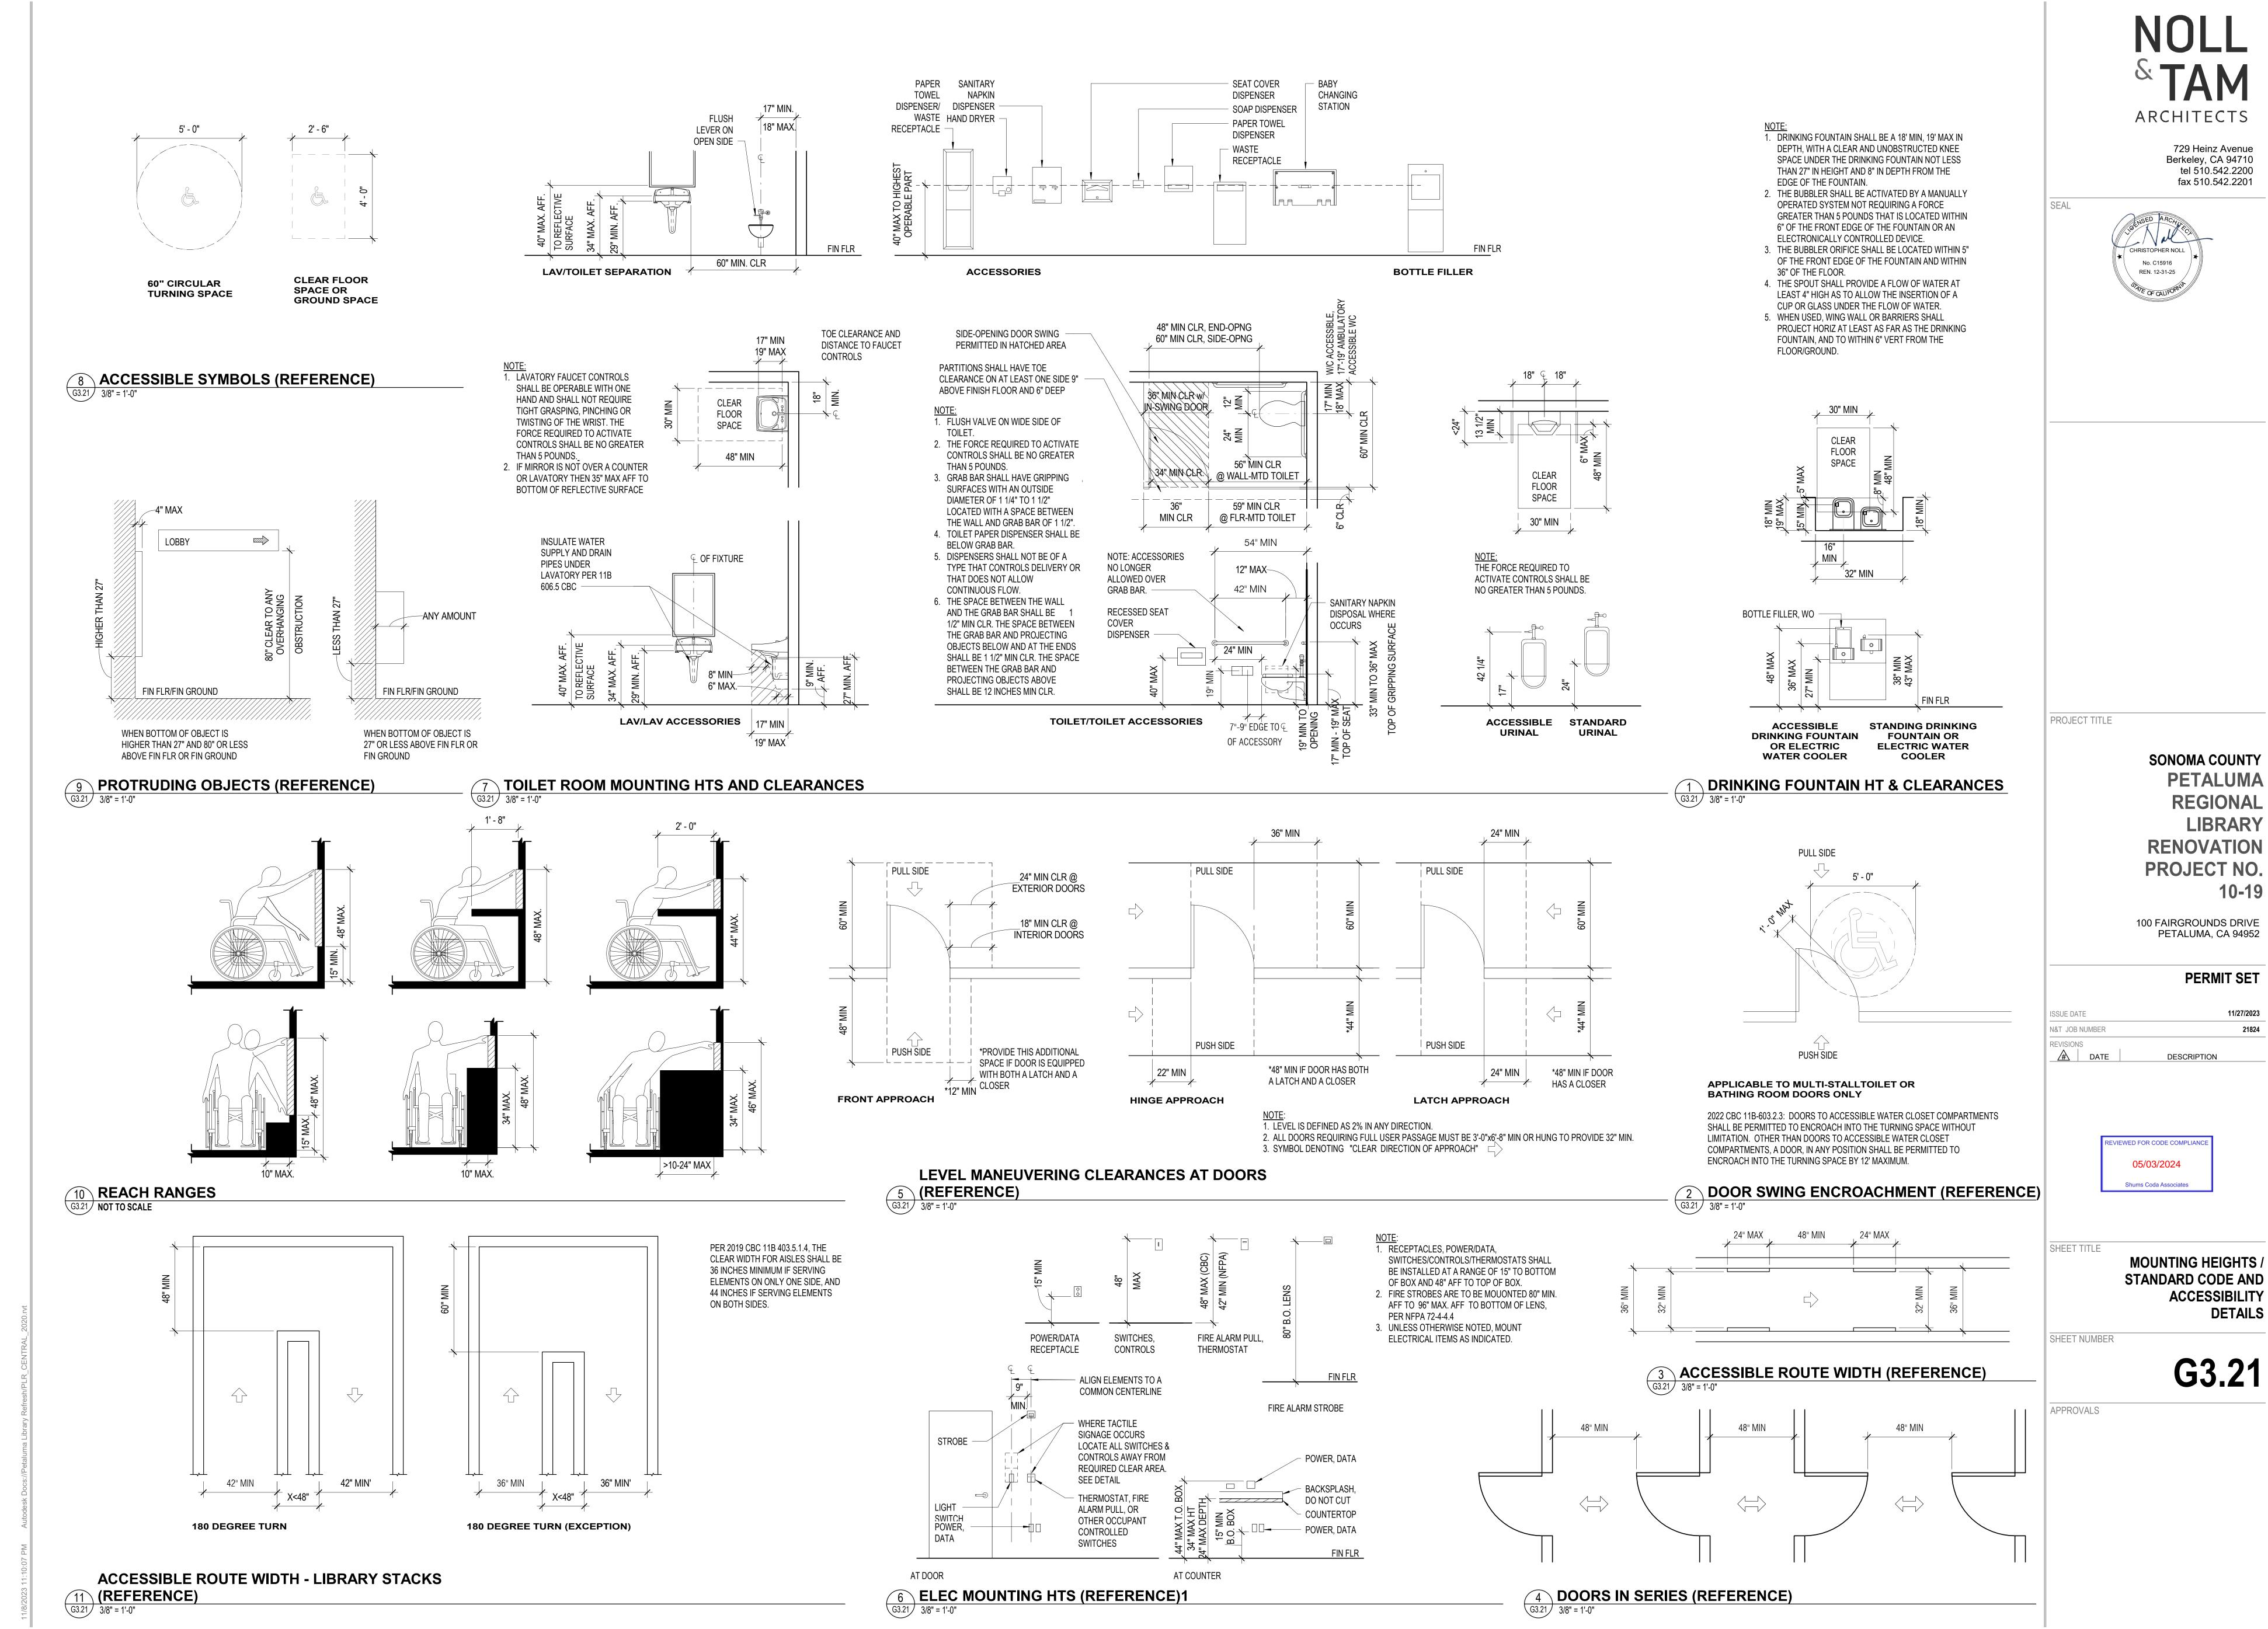

PETALUMA REGIONAL LIBRARY REFRESH

FIRE SUPPLY UPGRADE

PETALUMA, CALIFORNIA

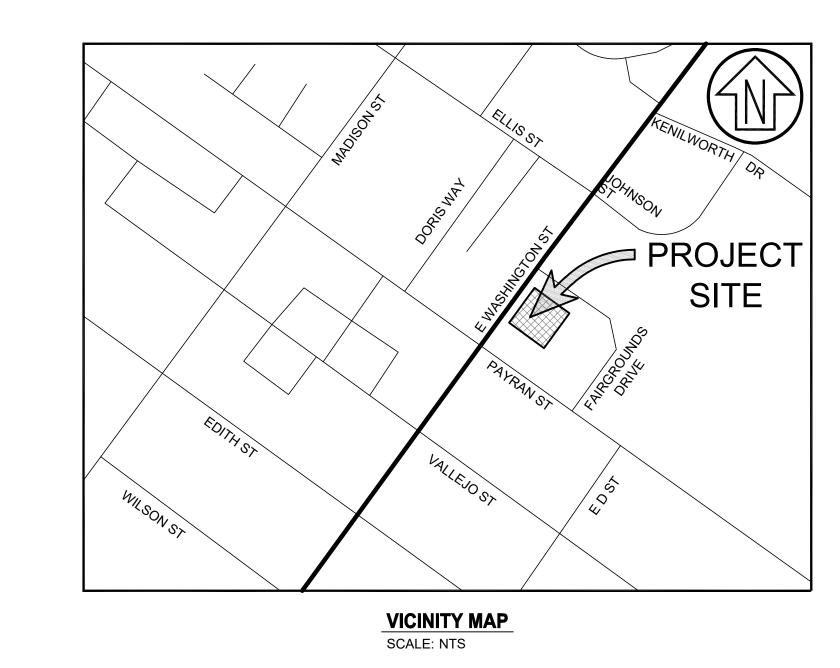

GENERAL NOTES

- WORK SHOWN HEREON SHALL BE DONE IN ACCORDANCE WITH THE CITY OF PETALUMA STANDARD CONSTRUCTION PLANS AND SPECIFICATIONS, LATEST EDITION, THE STANDARD SPECIFICATIONS FOR THE STATE OF CALIFORNIA DEPARTMENT OF TRANSPORTATION, AND UTILITY COMPANY'S STANDARD PLANS AND SPECIFICATIONS AS APPLICABLE. LATEST EDITION.
- PERSONS AND PROPERTY, DURING THE COURSE OF CONSTRUCTION OF THIS PROJECT. THIS REQUIREMENT SHALL APPLY CONTINUOUSLY, AND SHALL NOT BE LIMITED TO NORMAL WORKING HOURS. THE CONTRACTOR FURTHER AGREES TO HOLD DESIGN PROFESSIONAL HARMLESS FROM ANY AND ALL LIABILITY, REAL OR ALLEGED, IN CONNECTION WITH THE PERFORMANCE OF WORK ON THIS PROJECT, EXCEPTING LIABILITY ARISING FROM THE SOLE NEGLIGENCE OF THE DESIGN PROFESSIONAL
- 3. CONTRACTOR SHALL HOLD HARMLESS THE **OWNER** AND ITS AUTHORIZED REPRESENTATIVES FROM ALL LIABILITIES AND DAMAGES RESULTING FROM HIS CONSTRUCTION OPERATIONS.
- 4. PRIOR TO COMMENCING CONSTRUCTION OPERATIONS, THE CONTRACTOR SHALL VERIFY ALL INTERFACES BETWEEN EXISTING CONDITIONS AND NEW CONSTRUCTION FOR GRADING, DRAINAGE, UNDERGROUND, AND OVERHEAD FACILITIES, INCLUDING LOCATION AND ELEVATION OF EXISTING UNDERGROUND OR AT GRADE FACILITIES AT CROSSINGS WITH PROPOSED UNDERGROUND FACILITIES. IF CONDITIONS DIFFER FROM THOSE SHOWN ON THE PLANS, THE CONTRACTOR SHALL NOTIFY THE ENGINEER AND SHALL NOT BEGIN CONSTRUCTION OPERATIONS UNTIL THE CHANGED CONDITIONS HAVE BEEN EVALUATED.
- 5. THE CONTRACTOR SHALL BE RESPONSIBLE FOR THE REVIEW AND COORDINATION OF ALL CONTRACT DOCUMENTS PRIOR TO THE START OF CONSTRUCTION. ANY DISCREPANCIES THAT OCCUR SHALL BE BROUGHT TO THE ATTENTION OF THE ARCHITECT PRIOR TO THE START OF CONSTRUCTION SO THAT A CLARIFICATION CAN BE ISSUED. ANY WORK PERFORMED IN CONFLICT WITH THE CONTRACT DOCUMENTS SHALL BE CORRECTED BY THE CONTRACTOR AT THEIR OWN EXPENSE.
- 6. THE ENGINEER PREPARING THESE PLANS WILL NOT BE RESPONSIBLE FOR, OR LIABLE FOR, UNAUTHORIZED CHANGES TO OR USES OF THESE PLANS. ALL CHANGES TO THE PLANS MUST BE IN WRITING AND MUST BE APPROVED BY THE PREPARER OF THESE PLANS.
- 7. NOTES AND DETAILS ON DRAWINGS SHALL TAKE PRECEDENCE OVER GENERAL NOTES AND TYPICAL DETAILS. WHERE NO DETAILS ARE GIVEN, CONSTRUCTION SHALL BE AS SHOWN FOR SIMILAR WORK.
- 8. ALL EASEMENTS OR OTHER ENCUMBRANCES SHOWN OR REFERENCED IN THESE PLANS OR DISCLOSED IN A TITLE REPORT ARE SUBJECT TO INHERENT OR EXPLICIT RESTRICTIONS. THE OWNER IS RESPONSIBLE FOR DETERMINING THE IMPACT OF THESE RESTRICTIONS ON HIS OR HER INTENT FOR THE PROPERTY.
- 9. THE CONTRACTOR SHALL REPAIR OR REPLACE ALL EXISTING UNDERGROUND, AT-GRADE OR OVERHEAD IMPROVEMENTS DAMAGED DURING CONSTRUCTION TO THE SATISFACTION OF THE OWNER OR CITY, AS APPLICABLE, INCLUDING PERMANENT TRENCH RESURFACING.
- 10. THE CONTRACTOR SHALL OBTAIN ALL NECESSARY PERMITS INCLUDING ENCROACHMENT PERMIT FROM THE CITY PRIOR TO ANY WORK IN THE PUBLIC RIGHT-OF-WAY.
- 11. TRAFFIC CONTROL SHALL BE PERFORMED IN ACCORDANCE WITH THE REQUIREMENTS OF THE LATEST "MANUAL OF TRAFFIC CONTROLS" PUBLISHED BY THE CALIFORNIA DEPARTMENT OF TRANSPORTATION. THE CONTRACTOR SHALL SUBMIT A TRAFFIC CONTROL PLAN TO THE CITY FOR APPROVAL PRIOR TO THE COMMENCEMENT OF CONSTRUCTION OPERATIONS.
- 12. CONTRACTOR TO BE AWARE OF AND PROTECT ALL OVERHEAD LINES AT ALL TIMES, SO AS NOT TO DISTURB THEM.
- 13. WATER SHALL BE PROVIDED ONSITE BY THE CONTRACTOR AND USED TO CONTROL DUST DURING CONSTRUCTION OPERATIONS.
- 14. OUTDOOR NOISE-GENERATING CONSTRUCTION ACTIVITIES (INCLUDING BUT NOT LIMITED TO RAPID IMPACT COMPACTION (RIC) GRADING, TRENCHING, CONCRETE PLACEMENT, SAWING AND HAMMERING) SHALL BE LIMITED TO THE HOURS BETWEEN 7AM. AND 5PM, MONDAY THROUGH FRIDAY. FOR QUESTIONS REGARDING CONSTRUCTION HOURS AND/OR RELATED NOISE, PLEASE CONTACT THE CITY OF
- 15. CONTRACTOR SHALL COMPLY FULLY WITH THE REQUIREMENTS OF ASSEMBLY BILL 2040, DAVIS, ASBESTOS.
- 16. IF, AT ANY TIME DURING GRADING OPERATIONS, ANY UNFAVORABLE GEOLOGICAL CONDITIONS ARE ENCOUNTERED, GRADING IN THAT AREA WILL STOP UNTIL APPROVED CORRECTIVE MEASURES ARE OBTAINED.
- 17. ALL DEBRIS, EXCESS, AND FOREIGN MATERIAL SHALL BE REMOVED FROM THE SITE AND DISPOSED OF AT APPROVED DISPOSAL SITES AT THE CONTRACTOR'S EXPENSE. THE CONTRACTOR SHALL OBTAIN NECESSARY PERMITS FOR THE TRANSPORTATION OF MATERIAL TO AND FROM THE SITE.
- 18. ALL FILL SOILS OR SOILS DISTURBED OR OVER-EXCAVATED DURING CONSTRUCTION SHALL BE COMPACTED PER THE REQUIREMENTS OF THE CITY OF PETALUMA BUT NOT LESS THAN 90% MAXIMUM DENSITY AS DETERMINED BY A.S.T.M. SOIL COMPACTION TEST D-1557.
- 19. ALL RAMPS AND OTHER ACCESSIBILITY ACCOMMODATIONS ARE INTENDED TO COMPLY WITH THE CURRENT STANDARDS UNDER THE AMERICANS WITH DISABILITIES ACT. THE CONTRACTOR SHALL NOTIFY THE CIVIL ENGINEER IF ANY PROPOSED IMPROVEMENTS ARE NOT CONSISTENT WITH THE STANDARDS.
- 20. ALL STREETS AND SIDEWALKS SHALL BE SWEPT AND KEPT CLEAN AT THE END OF EACH DAY AND SHALL COMPLY WITH ALL APPLICABLE CITY OF PETALUMA POLLUTION PREVENTION REQUIREMENTS FOR THE DURATION OF THE PROJECT WORK.
- 21. CONTRACTOR SHALL OBTAIN ALL REQUIRED PERMITS, INCLUDING NPDES, FROM THE APPROPRIATE JURISDICTIONAL AGENCIES FOR DISCHARGE OF GROUNDWATER THAT MAY BE NECESSARY TO ACCOMPLISH WORK SHOWN ON THESE PLANS.
- 22. THE CONTRACTOR SHALL CONTACT UNDERGROUND SERVICE ALERT (800-227-2600) A MINIMUM OF 48 HOURS PRIOR TO EXCAVATION.
- 23. THE CONTRACTOR SHALL OBTAIN AN O.S.H.A. PERMIT FROM THE CALIFORNIA DIVISION OF INDUSTRIAL SAFETY PRIOR TO THE CONSTRUCTION OF TRENCHES OR EXCAVATIONS WHICH ARE 5' OR DEEPER. ALL TRENCHES 5' IN DEPTH OR GREATER SHALL BE SHORED AND BRACED ACCORDING TO STATE LAW.
- 24. UTILITIES AS SHOWN CONFORM TO AVAILABLE RECORD DATA. THE EXISTENCE, LOCATION AND CHARACTERISTICS OF UNDERGROUND UTILITY INFORMATION SHOWN ON THESE PLANS HAVE BEEN OBTAINED FROM A REVIEW OF AVAILABLE RECORD DATA. NO REPRESENTATION IS MADE AS TO THE ACCURACY OR COMPLETENESS OF SAID UTILITY INFORMATION. IT IS THE CONTRACTOR'S RESPONSIBILITY TO VERIFY LOCATION AND DEPTHS BY POTHOLING OF ALL UTILITIES WITH APPROPRIATE AGENCIES, AND TO TAKE PRECAUTIONARY MEASURES TO PROTECT THE UTILITY LINES SHOWN AND ANY OTHER LINES NOT OF RECORD OR NOT SHOWN ON THESE PLANS. ANY CONFLICTS SHALL BE REPORTED IMMEDIATELY TO THE AGENCY AND TO THE CIVIL ENGINEER.
- 25. IRRIGATION AND OTHER SITE UTILITY IMPROVEMENTS WHICH ARE DAMAGED TO COMPLETE CONSTRUCTION, OR OTHERWISE DISTURBED OR DAMAGED DURING THE COURSE OF CONSTRUCTION, ARE TO BE REPAIRED TO THE OWNER'S SATISFACTION.

- 28. MANHOLE FRAMES AND COVERS AND ALL OTHER UTILITY FRAMES AND COVERS LOCATED WITHIN PAVED AREAS SHALL BE BROUGHT TO FINISH GRADE AFTER PAVING. RIM GRADES, WHERE SHOWN, ARE APPROXIMATE. CONTRACTOR TO ADJUST RIM GRADE TO CONFORM
- 29. STORM DRAINAGE SYSTEMS SHOWN ON THESE PLANS HAVE BEEN DESIGNED FOR THE FINAL SITE CONDITION AT COMPLETION OF THE PROJECT. THE CONTRACTOR IS RESPONSIBLE FOR MAINTAINING ADEQUATE DRAINAGE OF THE SITE, DURING INTERIM CONDITIONS OF
- 30. ALL CURB DIMENSIONS AND RADII ARE TO FACE OF CURB.


CALCULATIONS.

- 31. CONTRACTOR SHALL NOTIFY CITY ENGINEER 48 HOURS PRIOR TO ANY NEED FOR FORMWORK REVIEW AND APPROVAL
- 32. THE LOCATION OF SYMBOLS SHOWN ON THE DRAWINGS MAY NOT REPRESENT THE PRECISE LOCATION OF THE PROPOSED IMPROVEMENT. IF THE SYMBOL IS NOT ACCOMPANIED BY DIMENSIONS TO LOCATE THE PRECISE LOCATION OF THE PROPOSED IMPROVEMENT, REFER TO STANDARD DETAILS SHOWN WITHIN THE DRAWINGS OR APPROPRIATE AGENCY STANDARD DETAILS.
- 33. DIMENSIONS TO PIPELINES ARE TO CENTERLINE UNLESS OTHERWISE NOTED.
- 34. PRIVATE FIRELINE INSTALLATION AND TESTING SHALL CONFORM TO NFPA 24. THE TEST SHALL BE AT 200 PSI FOR A MINIMUM OF 2 HOURS. A PETALUMA FIRE DEPARTMENT INSPECTOR SHALL WITNESS. THE FLUSH. ALL THRUST BLOCKS AND JOINTS SHALL BE EXPOSED.
- 35. ALL WATER LINES SHALL BE INSTALLED WITH 36" MINIMUM COVER FROM TOP OF PIPE TO FINISHED GRADE, UNLESS OTHERWISE NOTED.
- 36. ALL PRIVATE FIRELINE PIPING SHALL BE MEET OR EXCEED THE REQUIREMENTS OF AWWA C900. CLASS 200, DR 14. THE PRESSURE RATING OF THE FITTINGS SHALL MEET OR EXCEED THE PRESSURE RATING OF THE PIPE.
- 37. REFER TO TRENCH WIDTH DETAIL AND THRUST BLOCK DETAIL ON SHEET C3.0 FOR TRENCH AND THRUST BLOCK REQUIREMENTS. 38. THRUST BLOCKS SHALL BE INSTALLED AT WATERLINE HORIZONTAL AND VERTICAL BENDS, TEES, CAPPED ENDS AND REDUCERS
- ACCORDING TO THE DETAILS PROVIDED ON THESE PLANS.

39. PRIVATE FIRELINE PIPING SIZES SHALL BE VERIFIED BY OTHERS FOR CONFORMANCE WITH SPRINKLER DESIGNER'S HYDRAULIC

- 40. PIPE AND FITTINGS PROTECTION: ALL FERROUS MATERIALS SHALL BE PROTECTED VIA MASTIC AS FOLLOWS: AFTER INSTALLATION, ALL BOLT RINGS AND EXPOSED METAL, RODS, NUTS, BOLTS, WASHERS, CLAMPS AND OTHER RESTRAINING DEVICES, EXCEPT THRUST BLOCKS, SHALL BE CLEANED AND THOROUGHLY COATED WITH A BITUMASTIC COATING SYSTEM. TAPE WRAP ENDS SHALL BE SECURED WITH HIGH BOND TAPE TO PREVENT UNRAVELING OF THE TAPE WRAP. THE BITUMASTIC COATING SYSTEM SHALL BE POLYKEN 1027 FLAMMABLE PIPELINE PRIMER (BRUSH APPLIED) AND POLYKEN 930 JOINT WRAP TAPE (35 MIL, 4" WIDTH) OR EQUAL. TAPE WRAP ENDS SHALL BE SECURED WITH POLYKEN 900 GENERAL UTILITY TAPE (12 MIL, 2" WIDTH) OR EQUAL. ALL TAPE SHALL BE APPLIED WITH A 50% OVERLAP WITH A DOUBLE THICKNESS. BURIED FERROUS PIPE FITTINGS SHALL BE COATED AND WRAPPED WITH THE BITUMASTIC COATING SYSTEM REFERENCED ABOVE. IN ADDITION TAPE WRAP ENDS SHALL BE SECURED WITH HIGH BOND TAPE AS REFERENCED ABOVE. BURIED DUCTILE IRON PIPE SHALL BE HAVE A BITUMINOUS COATING ON THE OUTSIDE OR SHALL BE COATING WITH THE BITUMASTIC COATING SYSTEM DESCRIBED ABOVE.
- 41. THE INSTALLER SHALL PROVIDE PIPE AND FITTING MATERIALS SUBMITTAL TO PETALUMA FIRE DEPARTMENT FOR APPROVAL BEFORE
- 42. ALL NUTS, BOLTS, CLAMPS AND RODS SHALL BE STAINLESS STEEL, TYPE 316.
- 43. DURING SITE GRADING OR EXCAVATION, IF EVIDENCE OF SOIL CONTAMINATION IS DISCOVERED BEYOND WHAT HAS PREVIOUSLY BEEN IDENTIFIED, CONTACT THE PETALUMA FIRE DEPARTMENT IMMEDIATELY. IF THE DISCOVERY OF HAZARDOUS WASTE WARRANTS AN EMERGENCY RESPONSE, CALL 911.
- 44. THE CONTRACTOR SHALL PROVIDE ALL CUT SHEETS AND DETAILS FOR THE FIRE SERVICE MAINS, VALVES, FDC, PIV, AND THRUST BLOCKS TO BE INSTALLED WHEN SUBMITTING FOR THE INSTALLATION PERMIT WITH THE FIRE DEPARTMENT.
- 45. UTILITY INFORMATION SHOWN IS DIAGRAMMATIC AND BASED UPON INFORMATION SHOWN ON RECORD DRAWINGS OF SHEETS C4 AND C11 OF THE EAST WASHINGTON STREET 18" WATER MAIN REPLACEMENT PLANS BY THE CITY OF PETALUMA DATED JULY 2014.
- 46. THE UNDERGROUND FIRE MAIN REQUIRES A SEPARATE FIRE DEPARTMENT PERMIT.
- 47. THE INSTALLING UNDERGROUND CONTRACTOR MUST HAVE THEIR LICENSE ON THE UNDERGROUND DRAWING. THE INSTALLING UNDERGROUND CONTRACTOR MUST ALSO WET-STAMP THE UNDERGROUND DRAWING.

LEGEND

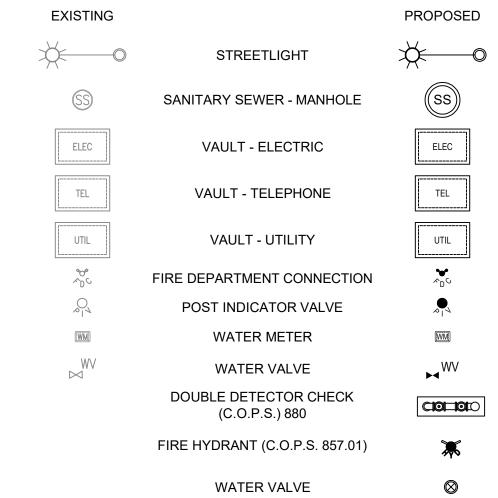

LEGEND

EXISTING		PROPOSED
C	CONDUIT LINE	
———— E ———	ELECTRICAL LINE	E
——— F ———	FIRE WATER	F
G	GAS LINE	G
JT	JOINT TRENCH	JT
SS	SANITARY SEWER	ss
ST	STEAM	ST
T	TELEPHONE LINE	——— Т
UG	UNDERGROUND UTILITY	UG
W	WATER	W
_////\\\/////	ABANDONED WATER MAIN	•

ABBREVIATIONS


- C.O.P.S. CITY OF PETALUMA STANDARD
- DDC DOUBLE DETECTOR CHECK FDC FIRE DEPARTMENT CONNECTION
- FIRE HYDRANT
- LINEAR FEET
- WATER LINE

SHEET INDEX

C1.0 COVER SHEET

C2.0 PLAN C3.0 DETAILS



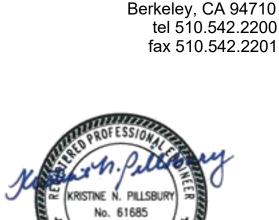

729 Heinz Avenue

CSW ST2

04 REDWOOD BLVD, SUITE 310 tel: 415.883.985 Surveying & Mapping Land Planning Construction Managemen

PROJECT TITLE

SONOMA COUNTY

100 FAIRGROUNDS DRIVE PETALUMA, CA 94952

DESCRIPTION

PERMIT SET

ISSUE DATE N&T JOB NUMBER


REVIEWED FOR CODE COMPLIANCE

Shums Coda Associates

SHEET TITLE

COVER SHEET

SHEET NUMBER

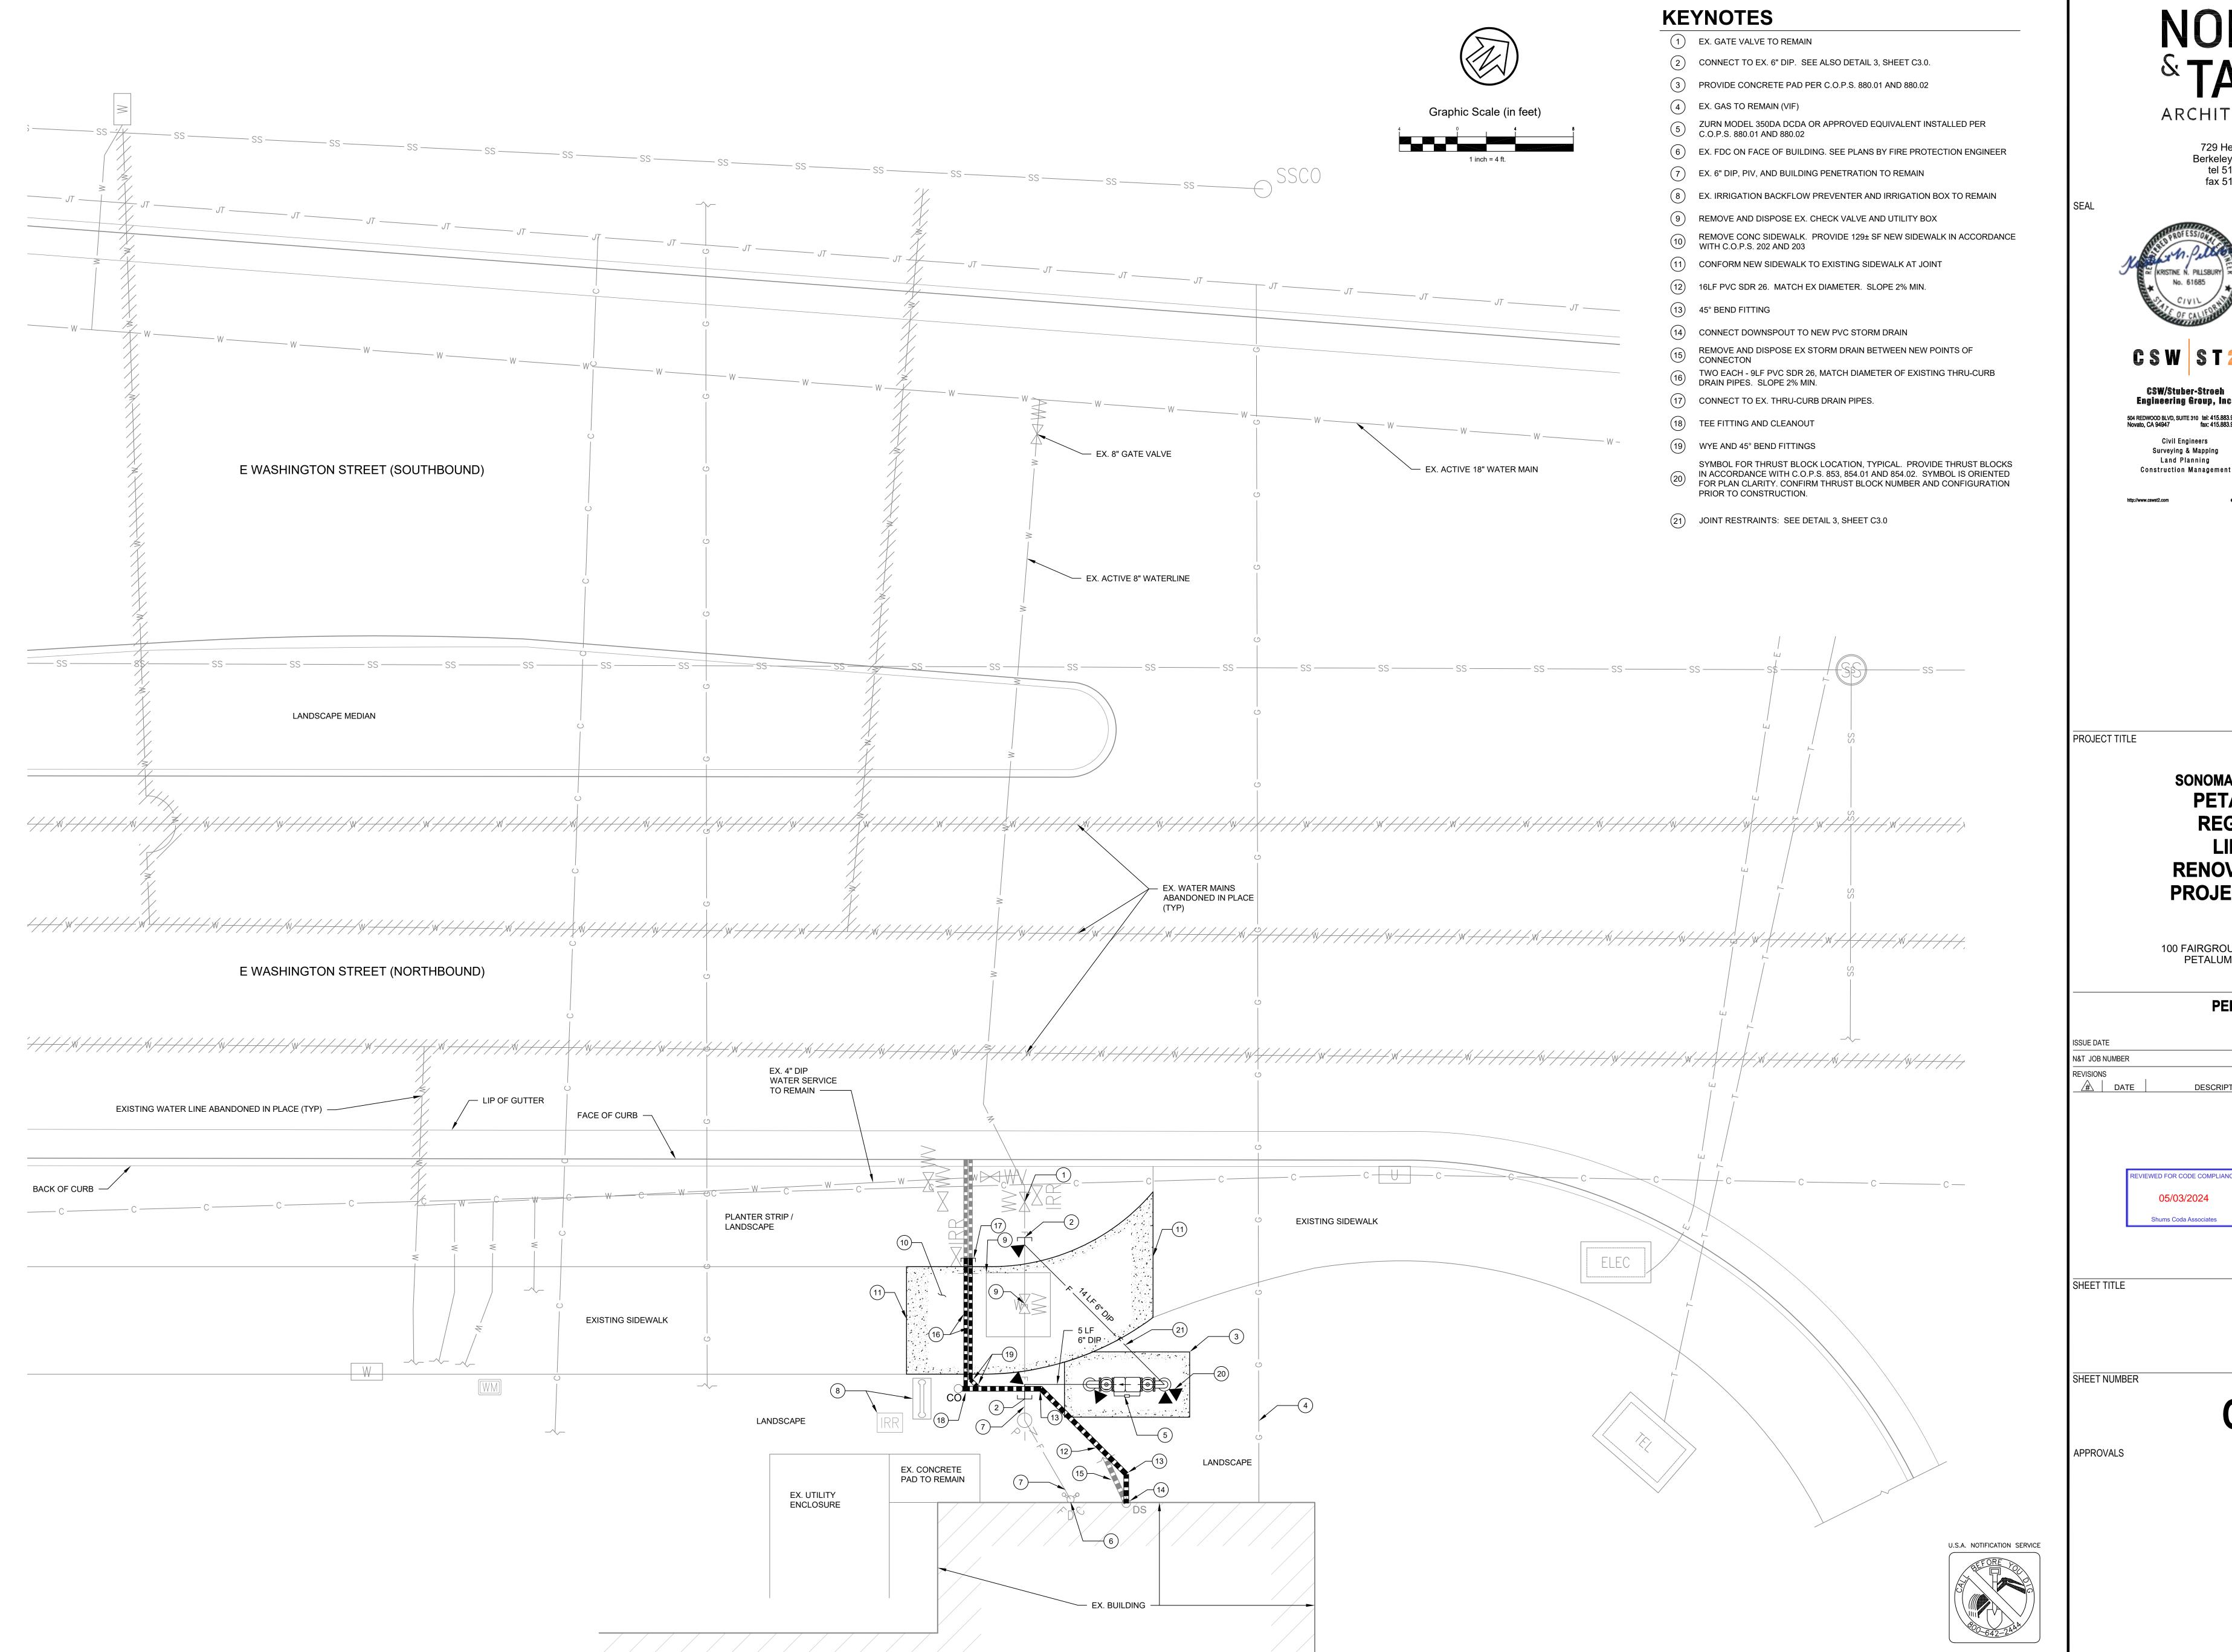

ARCHITECTS

729 Heinz Avenue Berkeley, CA 94710 tel 510.542.2200 fax 510.542.2201



CSW ST2

CSW/Stuber-Stroeh Engineering Group, Inc. 504 REDWOOD BLVD, SUITE 310 tel: 415.883.9850 Novato, CA 94947 fax: 415.883.9835

Civil Engineers Surveying & Mapping Land Planning

SONOMA COUNTY PETALUMA REGIONAL LIBRARY RENOVATION PROJECT NO.

100 FAIRGROUNDS DRIVE PETALUMA, CA 94952

PERMIT SET

DESCRIPTION

REVIEWED FOR CODE COMPLIANC

62.0

 UTILITY TRENCH CONSTRUCTION SHALL CONFORM TO THE RECOMMENDATIONS OF THE GEOTECHNICAL REPORT, IF ANY. 2. EXCAVATE FOR BELLS OR HUBS SO FULL LOAD IS CARRIED BY PIPE BARRELS. 3. BEDDING AND COVER: SELECT SAND WITH A MINIMUM SAND EQUIVALENT OF 30, 100% PASSING THE $\frac{1}{4}$ " SIEVE, A FINISHED GRADE OR PAVEMENT PER C.O.P.S. MINIMUM OF 90% PASSING THE No. 4 SIEVE AND NOT MORE THAN 10% PASSING THE No. 200 SIEVE. 4. BEDDING SHALL BE PLACED IN A MANNER SUCH AS SLICING, SHOVEL-SPADING, OR SHOVEL BACKFILL COMPACTED RODDING TO ENSURE COMPLETE TO 90% R.C. EXCEPT UPPER 12" FILLING OF THE "HAUNCH AREAS" BELOW PAVEMENT SUBGRADE BELOW THE PIPE. <u>JETTING IS NOT</u> WHERE COMPACTED TO 95% R.C., 1" CONDUIT FOR MATERIALS AND COMPACTION PER TAMPER SWITCH 5. SUBGRADE TO BE FREE OF GEOTECHNICAL REPORT. WIRING PROTRUDING OBJECTS. - 6" WIDE METALLIC BURIAL TAPE 6. BACKFILL MAY BE NATIVE SOIL THAT 4" MIN → MARKED WITH UTILITY TYPE (I.E. MEETS THE CRITERIA FOR FILL AS WATER, SANITARY SEWER, DESCRIBED IN THE C.O.P.S. STORM DRAIN, GAS, ELECT., 7. WHERE LESS THAN 18" BETWEEN ETC.) PLACED 12" TO 18" ABOVE BOTTOM OF PAVING SECTION (I.E. PIPE. TAPE TO BE DETECTABLE BOTTOM OF A.B.) AND TOP OF COVER, WITH UTILITY DETECTION BACKFILL TO BE CONTROLLED DENSITY EQUIPMENT AT GROUND SURFACE FILL (CDF) 8. TRENCH SUBGRADE SHALL BE PREPARED IN ACCORDANCE WITH (SEE NOTE 3) C.O.P.S. 219.1 AND 219.2. 9. ALL ON-SITE CITY UTILITY TRENCHES - PIPE SIZE AND TYPE SHALL COMPLY WITH CITY STANDARDS PER PLANS AND SPECS. • AND AS DIRECTED BY THE CITY OF PETALUMA IN THE FIELD. BEDDING 10. TRENCH SHALL BE CUT INTO (SEE NOTE 3) UNDISTURBED NATIVE SOIL. (8" MIN.) PRIVATE PIPE TRENCH DETAIL

12" REINFORCING BAR —— 12" REINFORCING BAR — 12" CENTERS BOTH WAYS 12" CENTERS BOTH WAYS (AS REQUIRED) (AS REQUIRED) MIN. 30° MAX. 45° BEARING — CONC. -BLOCK SURFACE (TYP.) **ELBOW**

1. THRUST BLOCKS TO BE CONSTRUCTED PER N.F.P.A. 24 AND CITY OF PETALUMA STANDARD (C.O.P.S.) 853, 854.01 AND 854.02. 2. ALL THRUST/ANCHOR BLOCKS SHALL BEAR AGAINST UNDISTURBED SOIL. 3. CONCRETE SHALL ATTAIN A MINIMUM COMPRESSIVE STRENGTH OF 3000 PSI.

4. ALL ANCHOR RODS AND ANCHOR BOLTS SHALL BE MINIMUM 5/8" DIA. & ANCHOR STRAPS SHALL BE 3" X 1/4". 5. THRUST BLOCK DESIGN IS BASED ON A WATER PRESSURE OF 100 P.S.I. AND A MINIMUM ALLOWABLE SOIL BEARING VALUE OF 1,000 P.S.F. THE CONTRACTOR SHALL BE RESPONSIBLE FOR VERIFYING SOIL BEARING VALUES AND THE POSITION AND SIZE OF BEARING AREAS BASED UPON


N.F.P.A. 24. 6. THE HEIGHT OF THE BLOCK MUST BE LESS THAN HALF OF THE TOTAL DEPTH TO THE BOTTOM OF THE BLOCK. 7. THE RATIO OF WIDTH TO HEIGHT OF THRUST BLOCK SHALL NOT EXCEED 1.5

THRUST BLOCK BEARING AREAS - S.F.							
MAIN	TEE *		BENI	END			
SIZE		90°	45°	22.5° 2 3 6			
6"	4	6	3	2			
8"	7	10	5	3			
12"	16	22	12	6			
* INCLUDES TEES, PLUGS, CAPS, HYDRANTS & VALVES							

BEARING

SURFACE

2 THRUST AND ANCHOR BLOCK DETAIL
SCALE: NTS

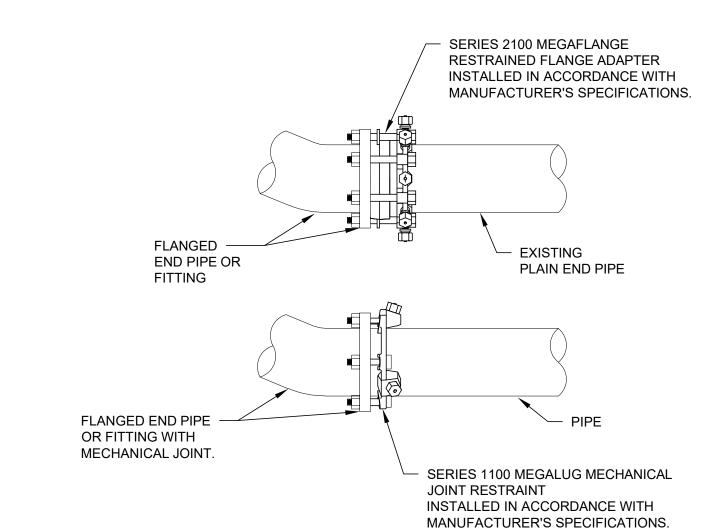

1. PER THE CITY OF PETALUMA WATER SYSTEM DESIGN GUIDELINES, RESTRAINED JOINTS SHALL BE SUBJECT TO THE PRIOR APPROVAL OF THE PUBLIC WORKS & UTILITIES DEPARTMENT. RESTRAINED JOINTS SHALL NOT BE USED IN LIEU OF THRUST BLOCKING OR TIEBACKS EXCEPT AS ALLOWED BY CITY STANDARD. FOR BID PURPOSES, CONTRACTOR SHALL ASSUME THAT, IN ADDITION TO THRUST BLOCKING AND TIEBACKS PER CITY STANDARDS, MEGALUG RESTRAINTS ARE TO BE PROVIDED AT EACH JOINT AND MEGAFLANGES ARE TO BE PROVIDED WHERE NEW FACILITIES CONNECT TO EXISTING FACILITIES.

- 2. MEGAFLANGE ADAPTERS SHALL BE PROVIDED AT ALL CONNECTIONS BETWEEN EXISTING PLAIN END PIPE AND FLANGED END PIPE AND FLANGED END FITTINGS.
- 3. MEGALUG MECHANICAL JOINT RESTRAINTS SHALL BE PROVIDED TO RESTRAIN PIPE AT ALL ABOVE- AND BELOW-GROUND MECHANICAL JOINTS.

MEGALUG FITTING
SCALE: NTS

U.S.A. NOTIFICATION SERVICE

ARCHITECTS 729 Heinz Avenue Berkeley, CA 94710

tel 510.542.2200 fax 510.542.2201



CSW ST2

CSW/Stuber-Stroeh Engineering Group, Inc. 504 REDWOOD BLVD, SUITE 310 tel: 415.883.9850

Civil Engineers Surveying & Mapping Land Planning Construction Management

PROJECT TITLE

SONOMA COUNTY **PETALUMA REGIONAL LIBRARY RENOVATION** PROJECT NO.

100 FAIRGROUNDS DRIVE PETALUMA, CA 94952

DESCRIPTION

PERMIT SET

ISSUE DATE N&T JOB NUMBER

> REVIEWED FOR CODE COMPLIANCE 05/03/2024 Shums Coda Associates


SHEET TITLE

DATE

DETAILS

SHEET NUMBER

C3 U **63.0**

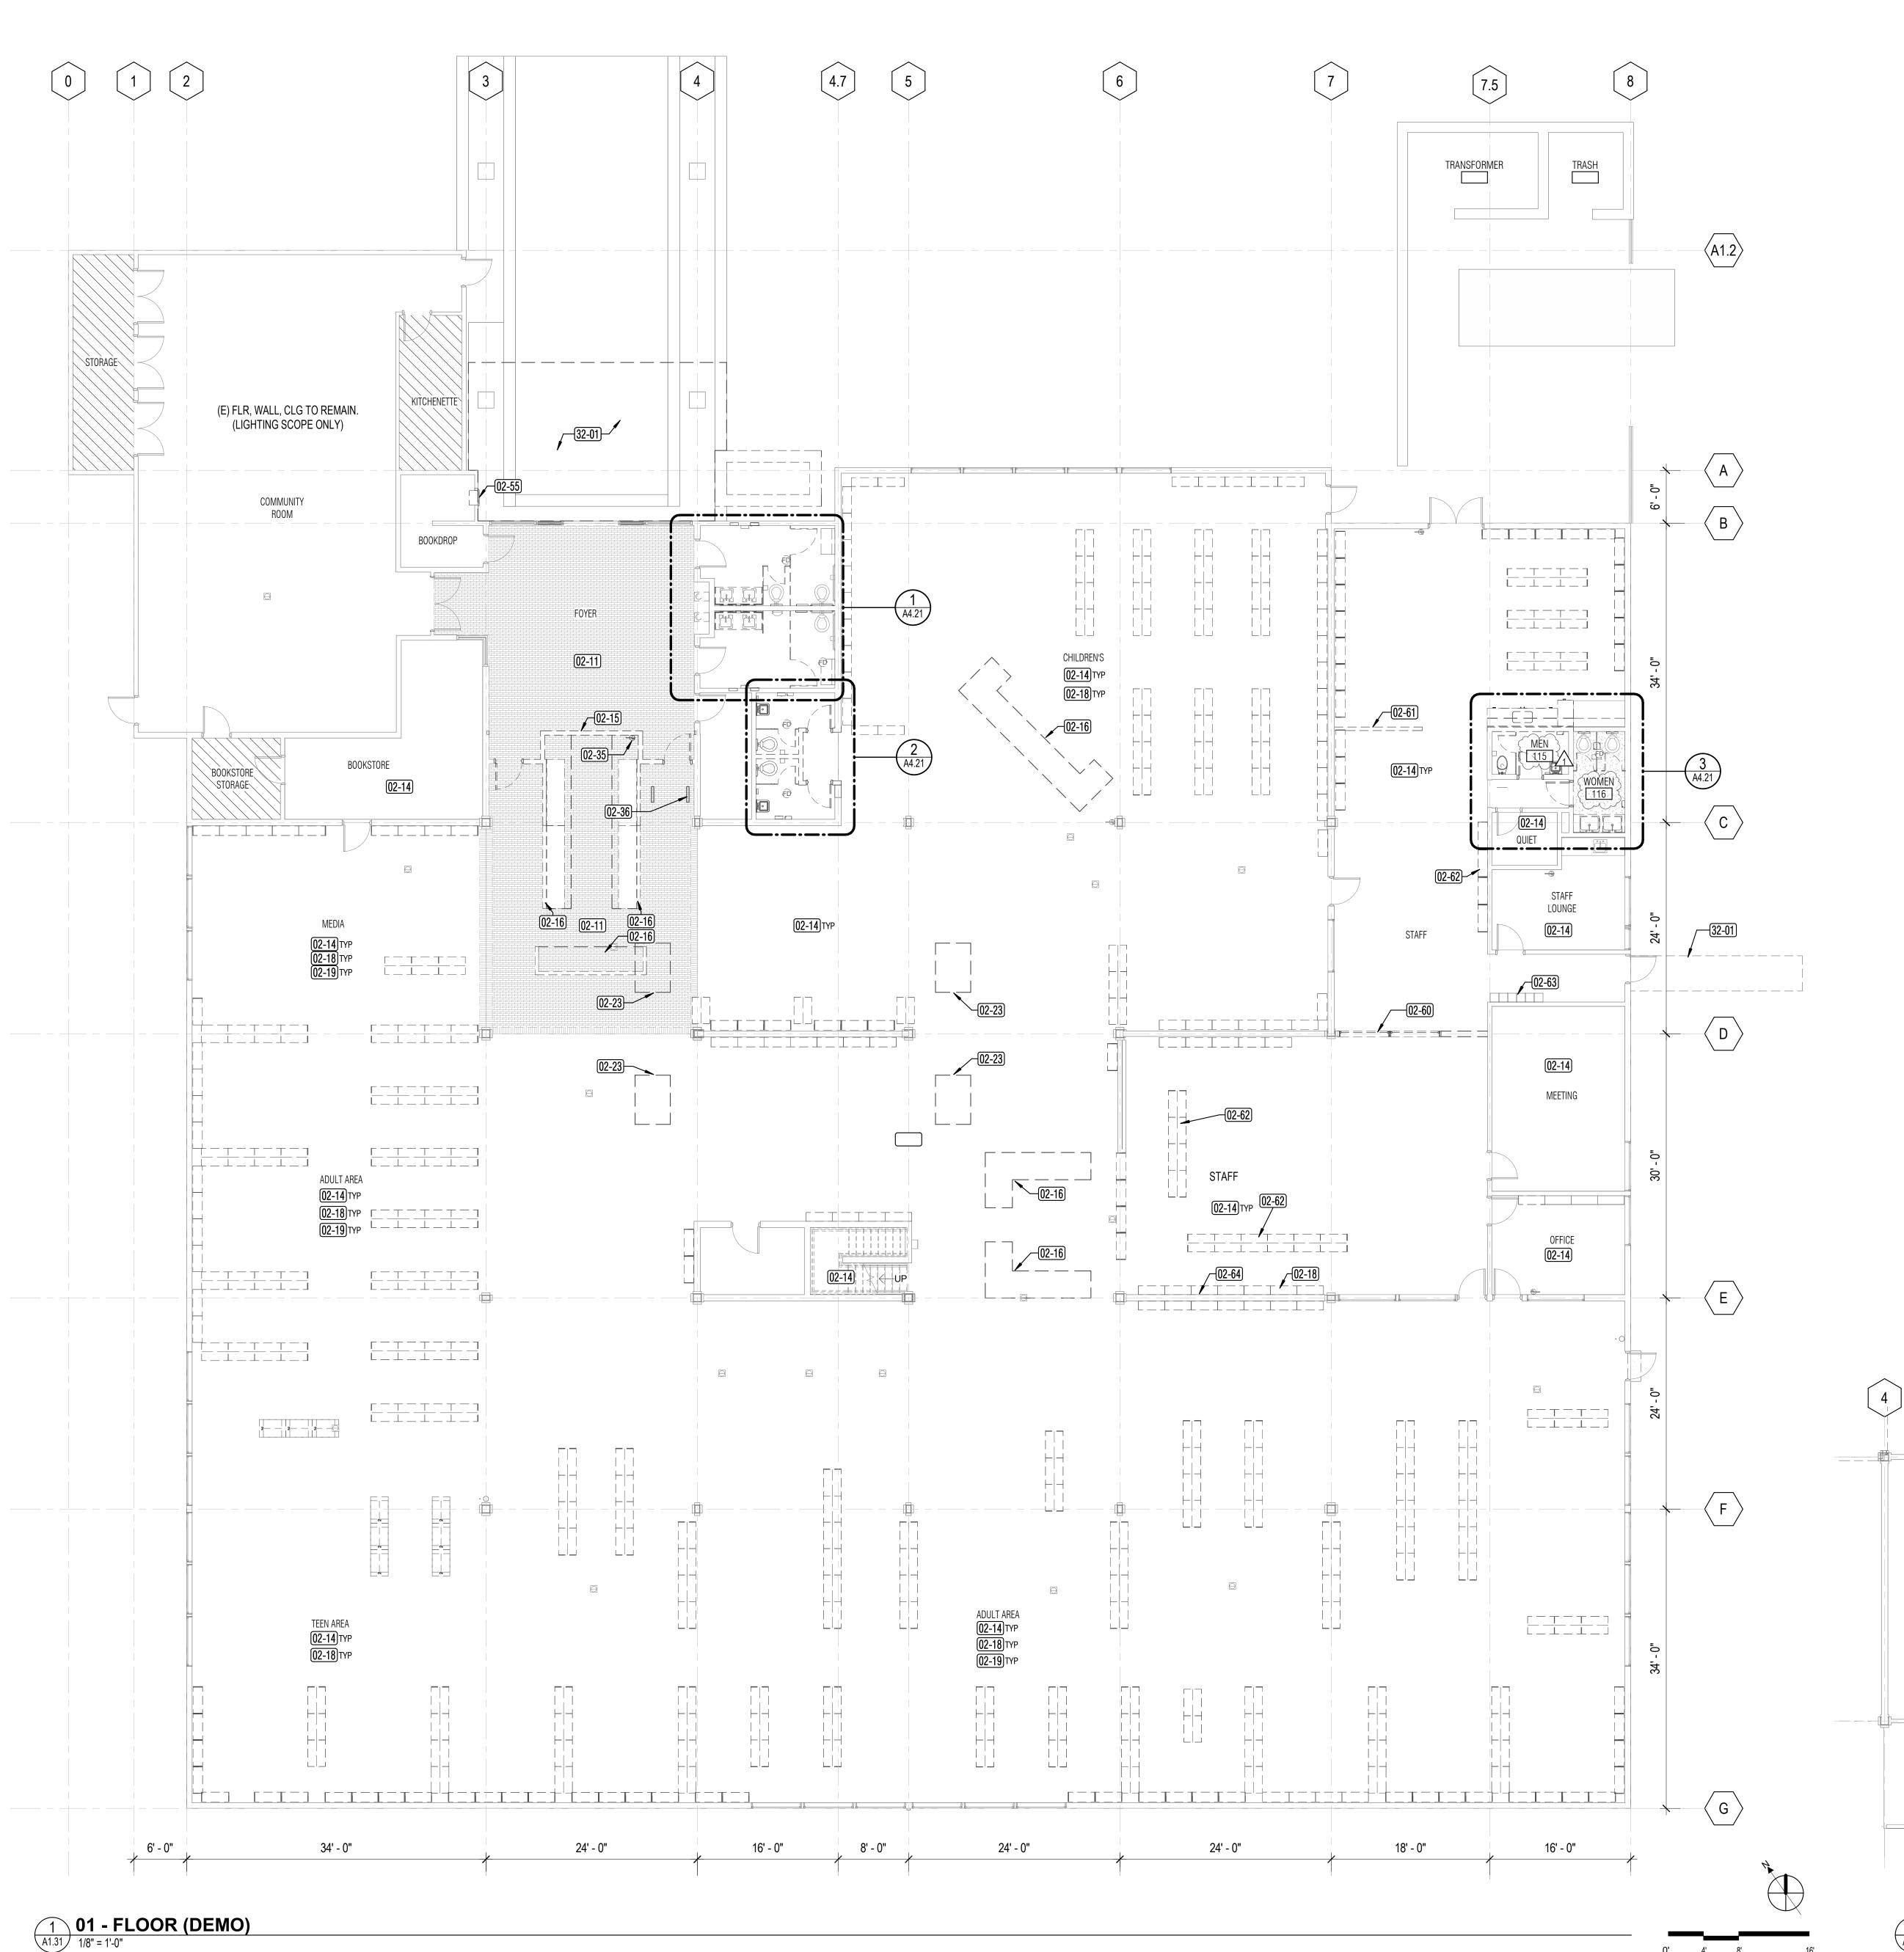

1. DIMENSIONS PROVIDED ON THE DRAWINGS ARE FOR REFERENCE ONLY. CONTRACTOR SHALL PROVIDE FIELD VERIFICATION AS REQUIRED IN AREA

2. SEE PLANS BY STRUCTURAL, MECHANICAL, ELECTRICAL AND LV FOR MORE INFORMATION

3. SHELVING CONTRACTOR- COORDINATE REMOVAL AND RE-INSTALLATION OF SHELVING IN FOL /STAFF AREA WITH SONOMA COUNTY LIBRARY 4. REFER TO FIRE SPRINKLER AND STRUCTURAL DWGS FOR SCOPE OF WORK. INSTALLATION OF FIRE SPRINKLER AT EXTERIOR (E) WALLS WITH KNEE BRACE REQUIRES REMOVAL AND SALVAGE OF EXISTING WALL WOOD SIDING AND REMOVAL OF GYP BD FOR 4X4 BLOCKING BETWEEN (E) STUDS. CONTRACTOR TO COORDINATE THE EXTENT OF REMOVAL OF (E) WOOD SIDING PRIOR TO WORK.

DEMO LEGEND

NO WORK IN AREA

_ _ _ _

(E) BRICK PAVERS

REMOVE

KEYNOTE LEGEND Keynote Text REMOVE EXISTING BRICK PAVERS INCLUDING MORTAR SETTING BED DOWN TO EXISTING DEPRESSED CONCRETE SLAB REMOVE EXISTING FLOOR CARPET FINISH INCLUDING CARPET BASI - EXISTING RAISED WOOD BASE TO REMAIN REMOVE EXISTING MAIN ENTRANCE AND EXIT DOOR, INCLUDING SIDE LIGHT AND PARTITION WALL, INCLUDING POWERED DOOR ACTUATOR. SSD FOR REMOVAL OF EXISTING POSTS, AND SHORING

REMOVED EXISTING CIRCULATION DESK, SERVICE DESK AND CHILDREN'S DESK

OF OVERHEAD WALL. SEE S2.4 AND PREPARE FOR SECURITY ROLL 3

REMOVE EXISTING FREE-STANDING & WALL MOUNTED BOOKSHELVING UNITS THROUGHOUT LIBRARY (BY SHELVING CONTRACTOR)

(BY SHELVING CONTRACTOR) - SALVAGE WHITE END PANELS FOR RE-INSTALLATION ON NEW SHELVING IN ADULT COLLECTION AREA. ALL OTHER EXISTING COLOR END PANELS (GREEN AND TEAL) CAN BE RETURNED TO OWNER.

TRENCH EXISTING CONCRETE SLAB FOR ELECTRICAL AND DATA. SED FOR EXTENT OF TRENCHING REQUIRED. SEE DET 1/S1.1 FOR REPAIR OF CONCRETE SLAB

REMOVE AND SALVAGE EXISTING FIRE EXTINGUISHER FOR RELOCATION. SEE FLOOR PLAN FOR NEW LOCATION.

REMOVE EXISTING BOOK SECURTY GATE INCLUDING ASSOCIATED POWER AND CABLING EXISTING PETALUMA HISTORY ROOM EQUIPEMENT TO BE RELOCATED TO FIRST FLOOR. TO BE COORDINATED WITH LIBRARY

REMOVE EXISTING BOOK DROP AND PREP WALL FOR NEW OPENING

ELEC/IDF/STORAGE

AT LOWER HEIGHT REMOVE EXISTING WINDOWS AND NON-STRUCTURAL PARTITION REMOVE EXISTING LOW HEIGHT PARTITION

(BY SHELVING CONTRACTOR) SALVAGE AND RE-INSTALL EXISTING SHELVING TO WALL IN FRIENDS AREA. ANCHOR FREE STANDING UNITS TO FLOOR


REMOVE AND SALVAGE EXISTING STAFF LOCKERS AND CLOTHES RACK FOR RE-INSTALLATION REMOVE EXISTING WOOD BASE ALONG LENGTH OF WALL

EXTERIOR LANDING AND RAMP IMPROVEMENTS BY CITY OF

PETALUMA

ARCHITECTS 729 Heinz Avenue

Berkeley, CA 94710 tel 510.542.2200 fax 510.542.2201

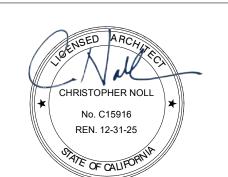

PROJECT TITLE

SONOMA COUNTY PETALUMA REGIONAL LIBRARY RENOVATION PROJECT NO.

100 FAIRGROUNDS DRIVE PETALUMA, CA 94952

PERMIT SET

ISSUE DATE N&T JOB NUMBER REVISIONS DESCRIPTION

1 1/22/2024 RESUBMITTAL

REVIEWED FOR CODE COMPLIANCE 05/03/2024 Shums Coda Associates

DEMOLITION PLAN - 1ST FLOOR AND MEZZANINE

SHEET NUMBER

A1.31

APPROVALS

E

2 MEZZANINE (DEMO)
A1.31 1/8" = 1'-0"


(E) ROOF ACCESS & (LADDER)

PETALUMA HISTORY COLLECTION

PETALUMA HISTORY RM (02-39) TYP

NO ARCHITECTURAL SCOPE. EXISTING PUBLIC ACCESS MATERIALS TO BE RELOCATED DOWNSTAIRS. HISTORY

ARCHIVAL COLLECTION TO REMAIN UPSTAIRS

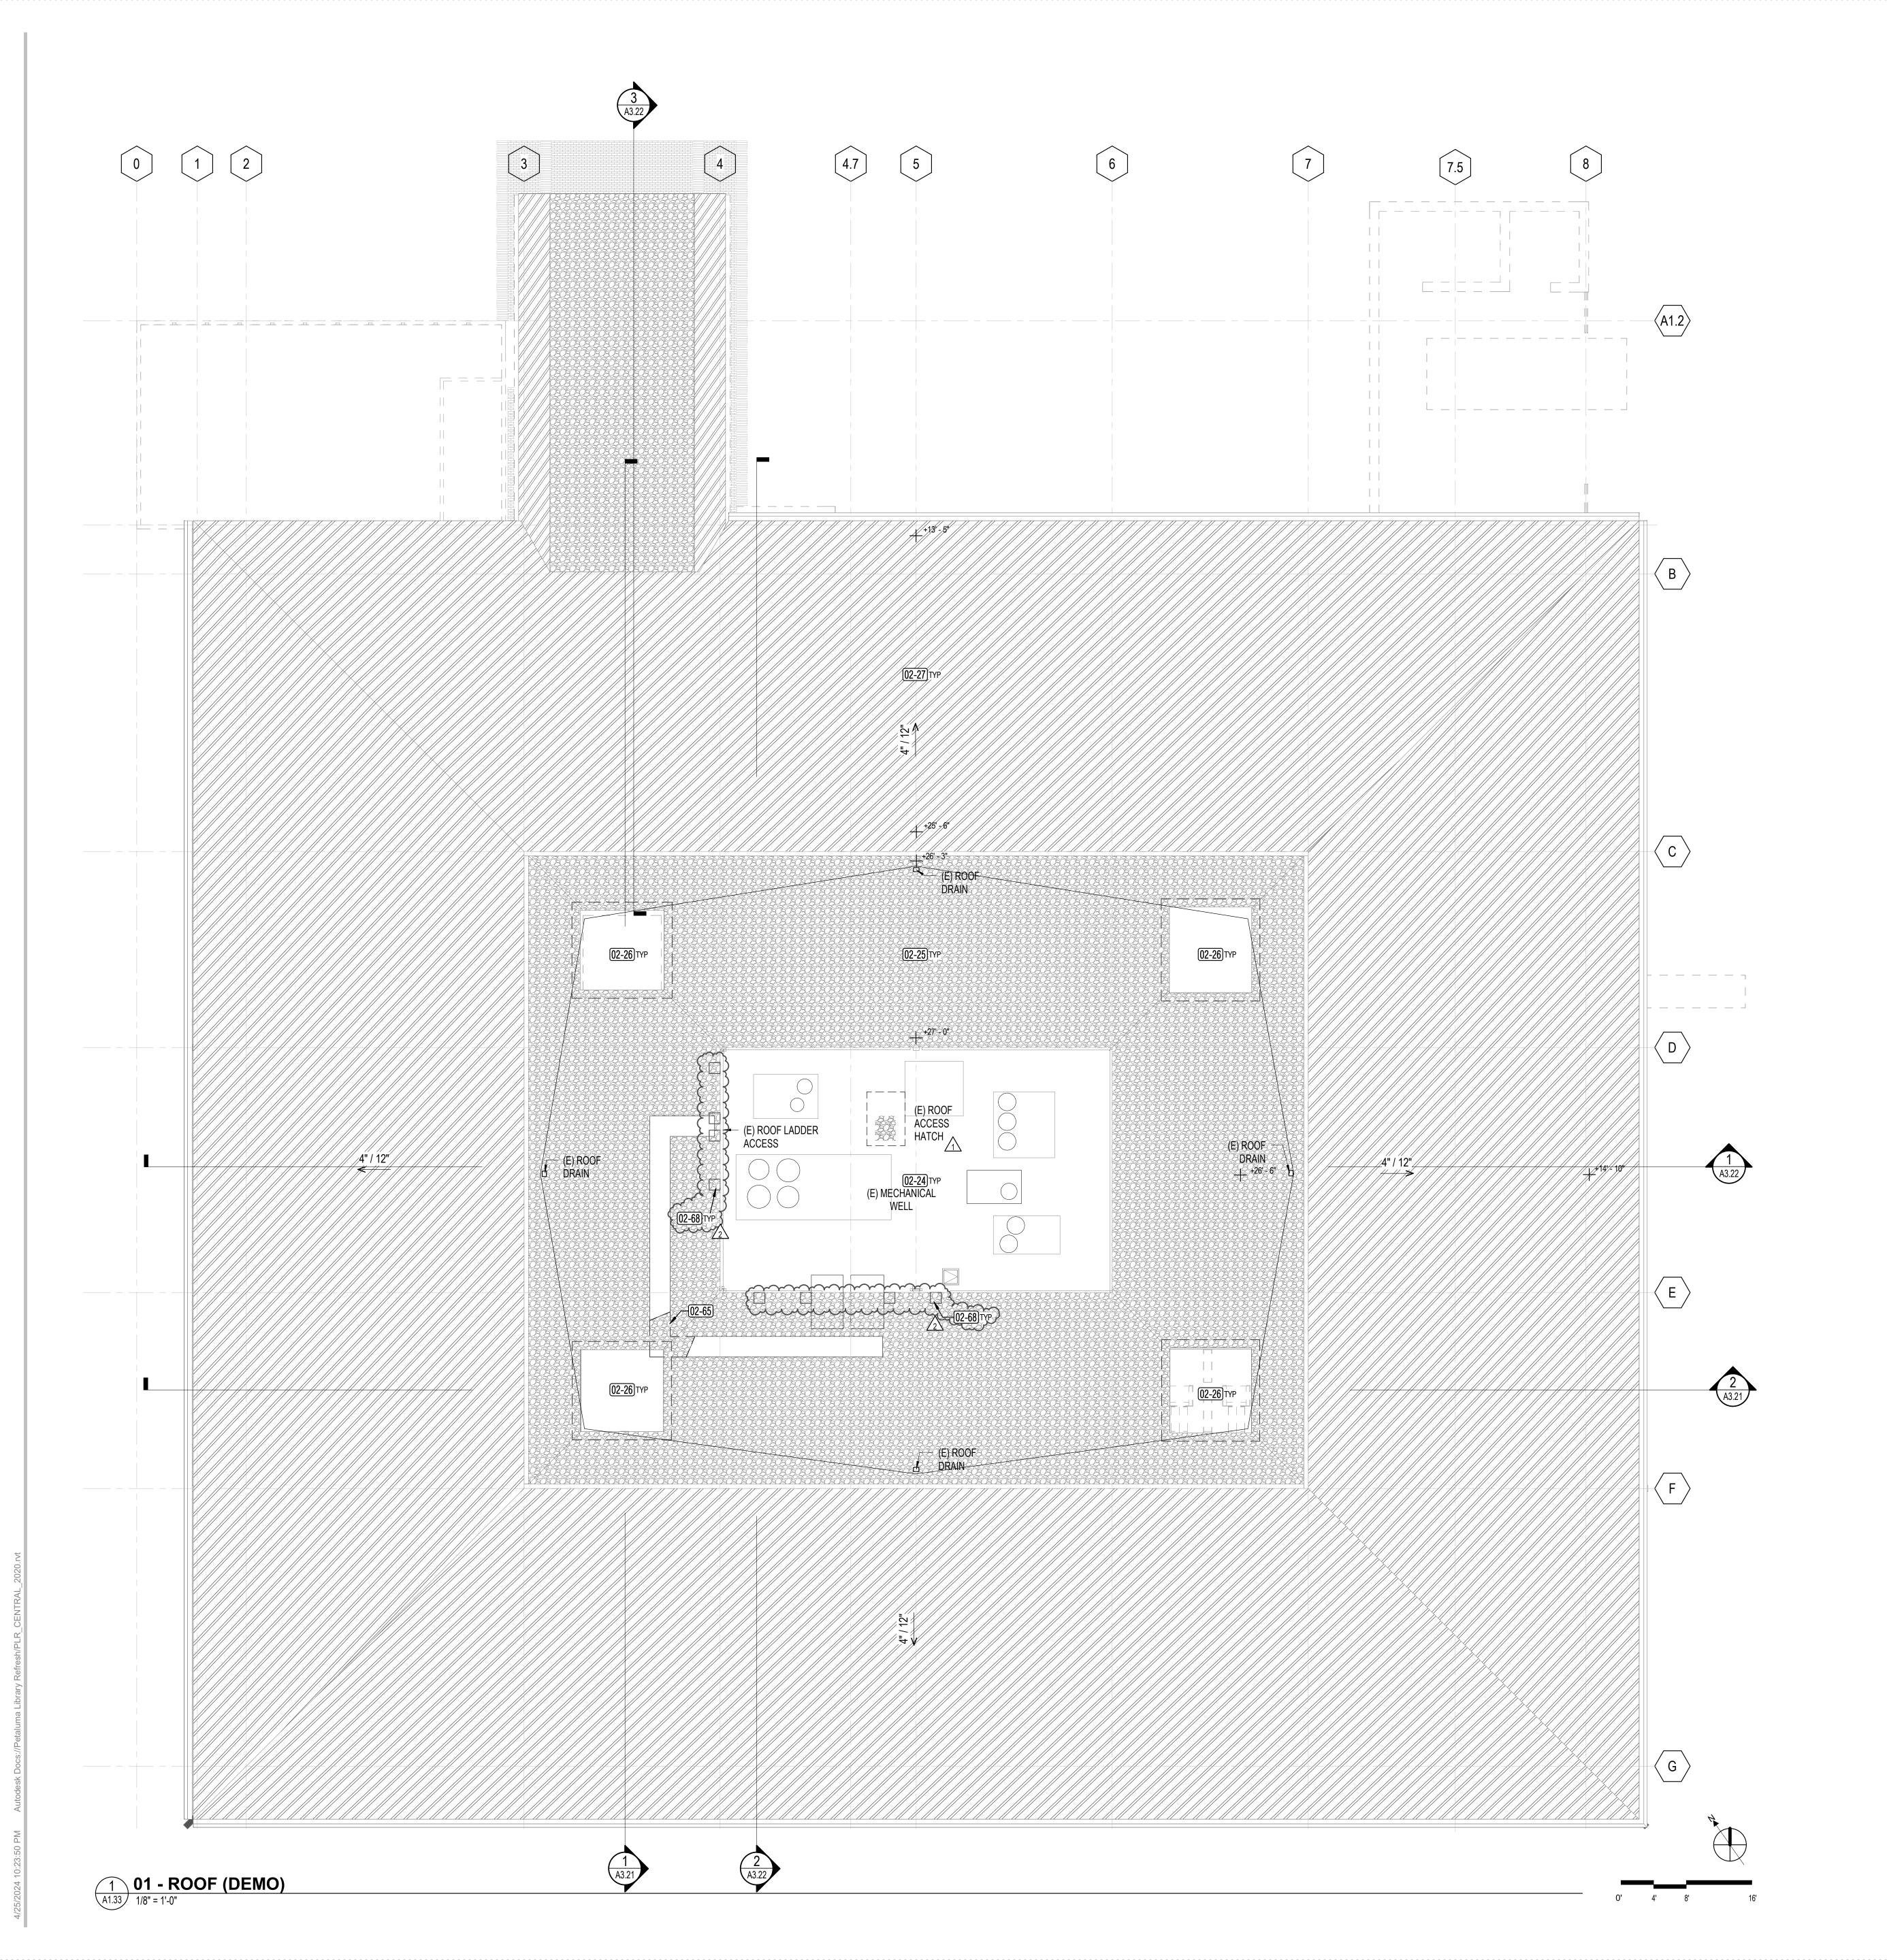

1. EXISTING TPO ROOF TO REMAIN. CONTRACTOR TO COORDINATE ROOFING MODIFICATIONS WITH EXISTING MANUFACTURER TO MAINTAIN EXISTING MANUFACTURER'S ROOF WARRANTY. VERIFY WITH OWNER OF THE BUILDING OR OWNER REPRESENTATIVE.

2. NO SCOPE OF WORK ASSOCIATED WITH EXISTING ROOF ACCESS LADDER HATCH OR ROOF LADDER U.O.N.
3. WHERE EXISTING BIRD NETTTING OCCURS, REMOVE/REPLACE AS

REQUIRED AS AFFECTED BY NEW SCOPE (DEDUCT ALTERNATE #1)

4. RELOCATE EXISTING ROOFTOP ROOFJACKS AND EXHAUST FAN AS REQUIRED FOR SKYLIGHT INSTALLATION (DEDUCT ALTERNATE #1)

5. PROVIDE ROOF CANT ARQUAD SKYLIGHT SLOPED 1/4"/FT TOWARDS EXISTING ROOF DRAINS (DEDUCT ALTERNATE #1)

UNITS AND DUCTWORK NOT SHOWN.

KEYNOTE LEGEND

Keynote Text

EXISTING MECHANICAL WELL TO REMAIN. EXISTING ROOFTOP

(DEDUCT ALTERNATE #1) REMOVE PORTION OF ROOFING AS REQUIRED FOR SKYLIGHT CURB AND FOR OVERLAP OF EXISTING

AND NEW ROOF MEMBRANE. SSD FOR EXTENT OF FRAMING

REQUIRED FOR NEW GUARDRAILS AND BASEPLATES. PREP FOR

02-27 EXISTING COPPER ROOF TO REMAIN
02-65 (DEDUCT ALTERNATE #1) REMOVE EXISTING ROOFTOP WALKPAD
AS REQUIRED FOR NEW SKYLIGHTS

02-68 (DEDUCT ALTERNATE #2) REMOVE EXISTING ROOFING AS

729 Heinz Avenue Berkeley, CA 94710 tel 510.542.2200


fax 510.542.2201



ARCHITECTS

DEMO ROOF LEGEND

EXISTING TPO ROOFING (BY CITY OF PETALUMA - UNDER RE-ROOFING PROJECT)

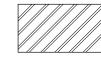

EXISTING COPPER ROOF, TO REMAIN

PROJECT TITLE

PETALUMA
REGIONAL
LIBRARY
RENOVATION
PROJECT NO.
10-19

100 FAIRGROUNDS DRIVE PETALUMA, CA 94952

PERMIT SET

ISSUE DATE

N&T JOB NUMBER

REVISIONS

DATE DESCRIPTION

1 1/22/2024 RESUBMITTAL
2 4/25/2024 RESUBMITTAL 2




SHEET TITLE

DEMOLITION PLAN -ROOF

SHEET NUMBER

A1.33

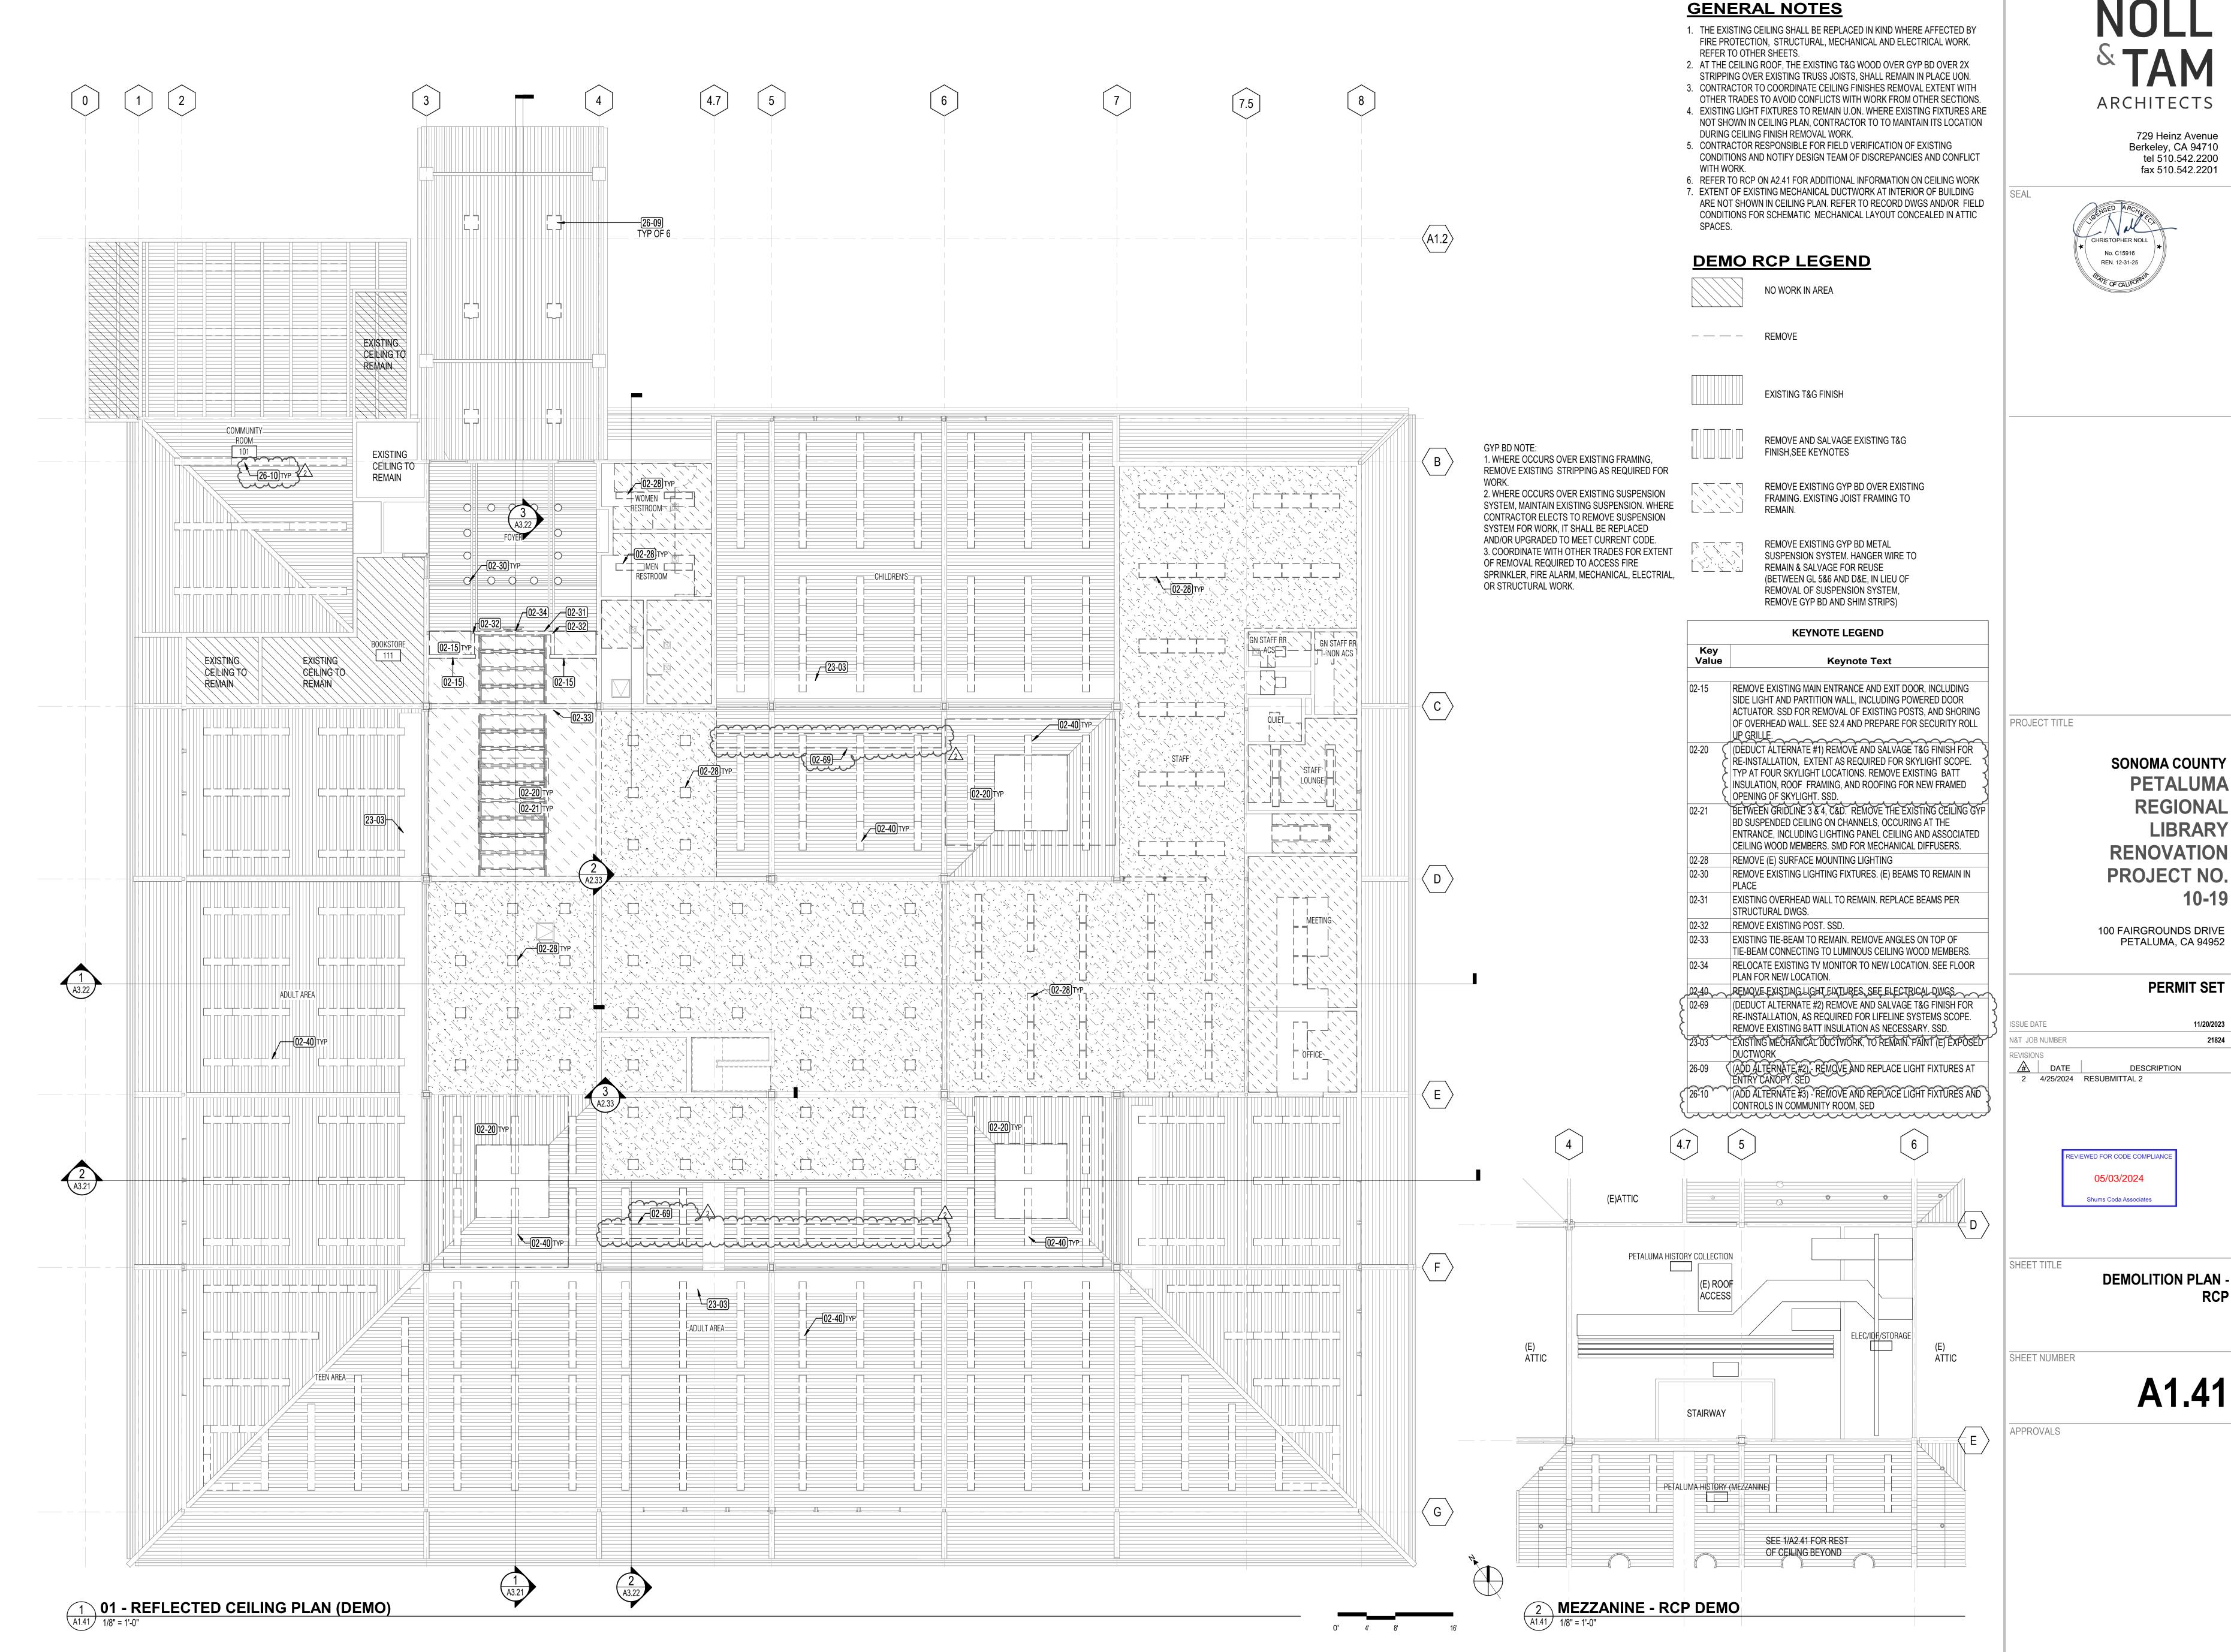


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PETALUMA REGIONAL LIBRARY RENOVATION PROJECT NO.

PETALUMA, CA 94952

PERMIT SET

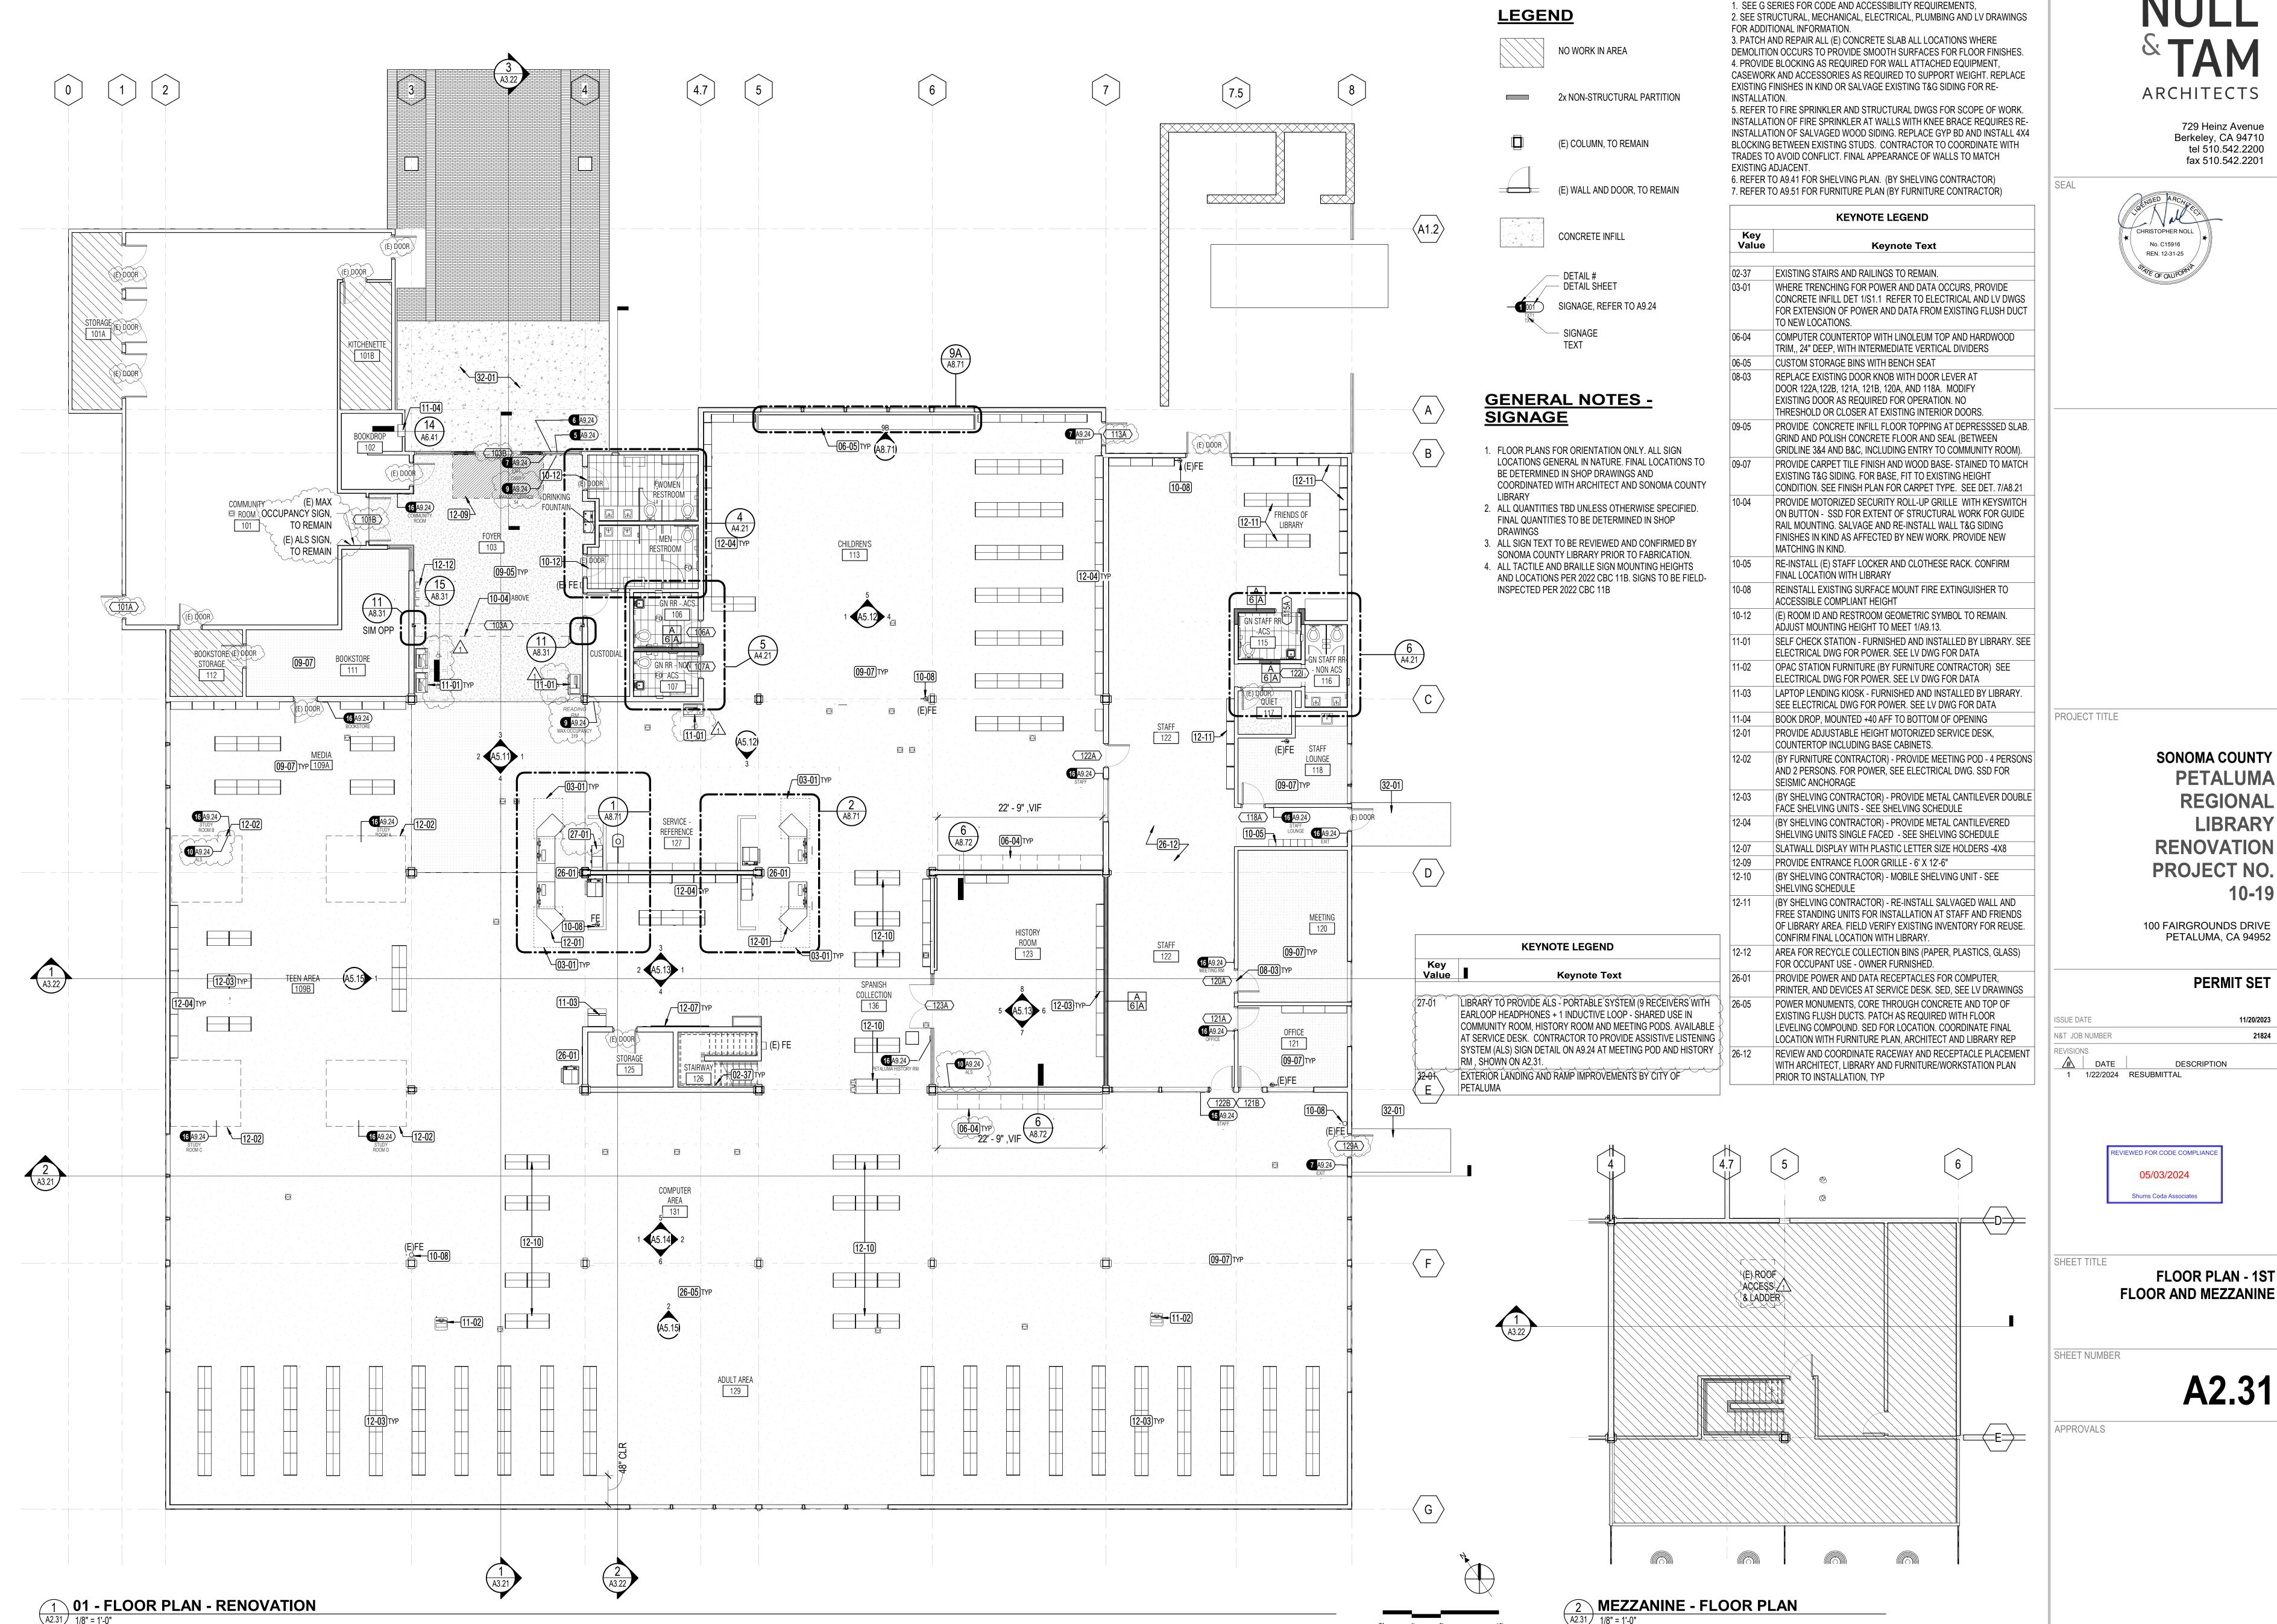


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PETALUMA REGIONAL LIBRARY RENOVATION PROJECT NO.

100 FAIRGROUNDS DRIVE PETALUMA, CA 94952

PERMIT SET

FLOOR PLAN - 1ST **FLOOR AND MEZZANINE**

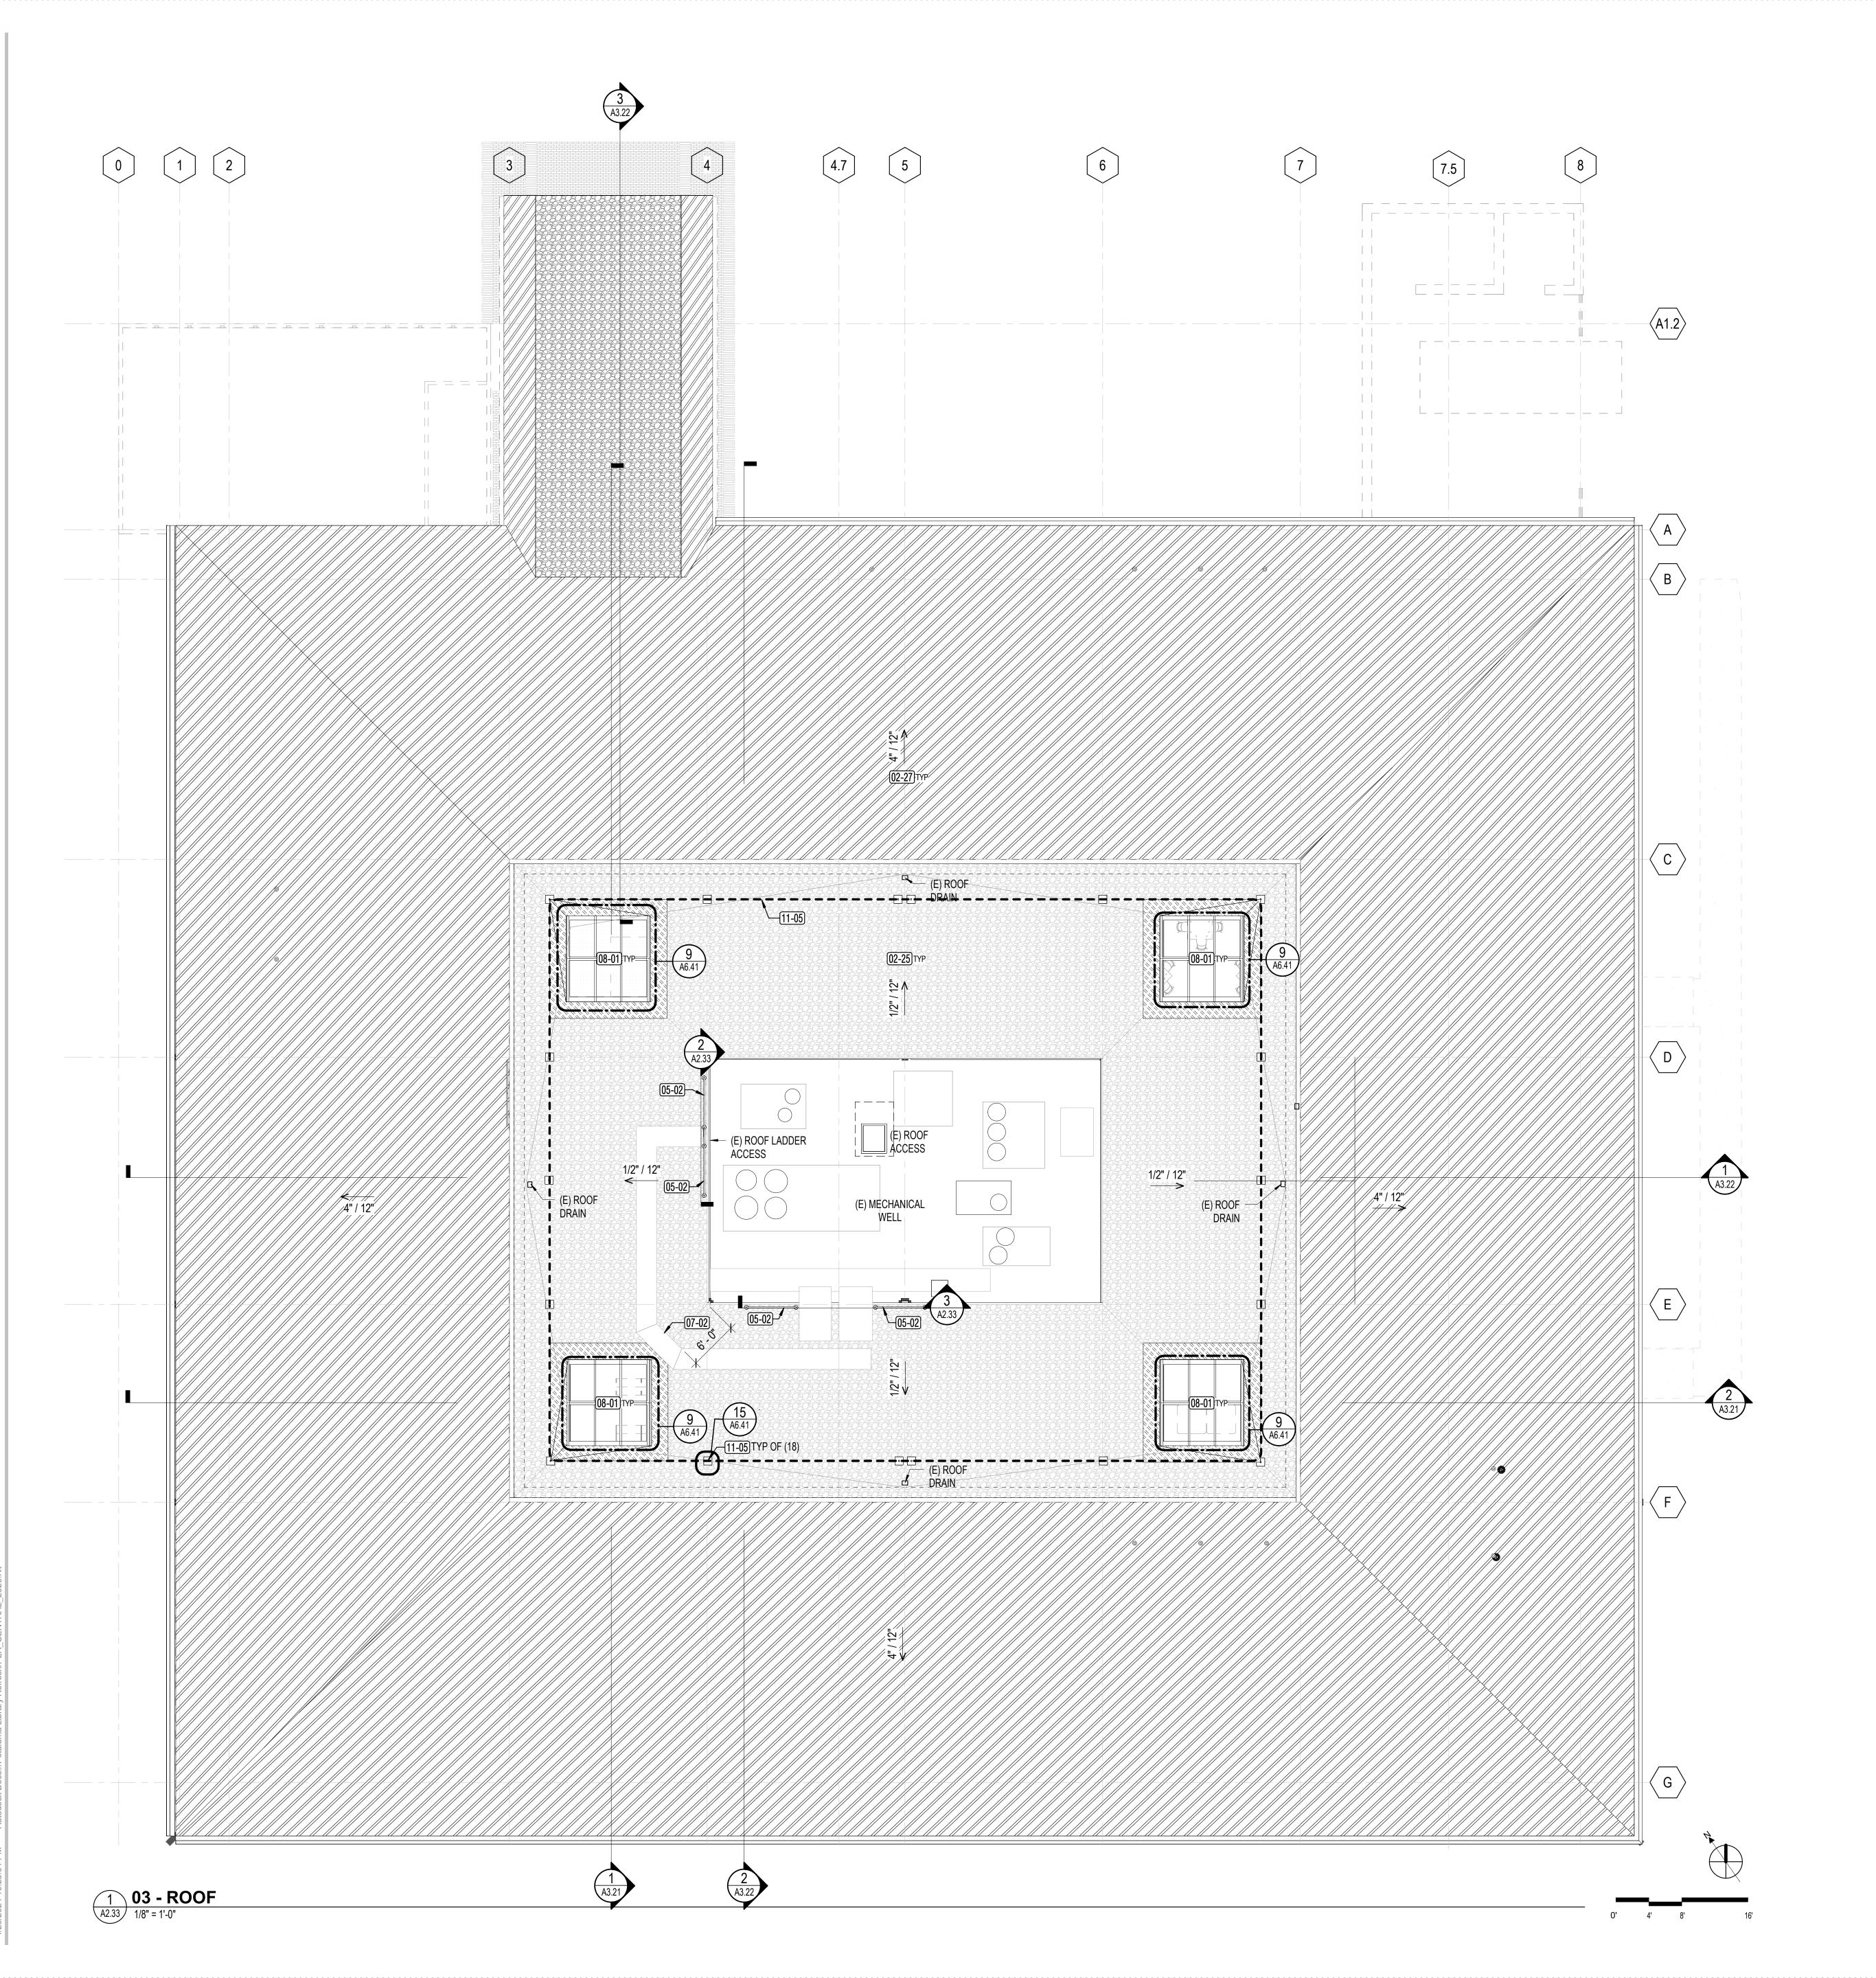

1. EXISTING TPO ROOF TO REMAIN. CONTRACTOR TO COORDINATE ROOFING MODIFICATIONS WITH EXISTING MANUFACTURER TO MAINTAIN EXISTING MANUFACTURER'S ROOF WARRANTY. VERIFY WITH OWNER OF THE BUILDING OR OWNER REPRESENTATIVE. 2. NO SCOPE OF WORK ASSOCIATED WITH EXISTING ROOF ACCESS

LADDER HATCH OR ROOF LADDER U.O.N. 3. WHERE EXISTING BIRD NETTTING OCCURS, REMOVE/REPLACE AS REQUIRED AS AFFECTED BY NEW SCOPE (DEDUCT ALTERNATE #1)

4. RELOCATE EXISTING ROOFTOP ROOFJACKS AND EXHAUST FAN AS REQUIRED FOR SKYLIGHT INSTALLATION (DEDUCT ALTERNATE #1)

5. PROVIDE ROOF CANT AROUND SKYLIGHT SLOPED 1/4"/FT TOWARDS EXISTING ROOF DRAINS (DEDUCT ALTERNATE #1)

KEYNOTE LEGEND

05-02 (DEDUCT ALTERNATE #2) PROVIDE GALV. STEEL GUARDRAIL, 6'-0" STRAIGHT', 1-1/4" PIPE (1.66"OD)

07-02 (DEDUCT ALTERNATE #1) REPLACE ROOFTOP WALKPAD (MATCH EXISTING) AROUND SKYLIGHT

DRAINAGE AND WATERPROOFING AROUND SKYLIGHT.

(DEDUCT ALTERNATE #1) PROVIDE 10'X10' SKYLIGHT ON RAISED CURB. PROVIDE MODIFICATION OF EXISTING MEMBRANE

ROOFING, FLASHING AND ROOF CRICKETS AS REQUIRED FOR

AUGMENTATION OF ROOF DIAPHRAGM, NAILING, AS REQUIRED WITH ASSOCATED DEMO AND NEW WORK.SEE STRUCTURAL

DWGS
(DEDUCT ALTERNATE #2) PROVIDE STANCHION MOUNTED
2 LIFELINE SYSTEM. SSD FOR CONNECTION OF STANCHION TO


EXISTING ROOFING, TO REMAIN.

EXISTING COPPER ROOF TO REMAIN

Keynote Text


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ROOF LEGEND

EXISTING TPO MEMBRANE ROOFING, TO REMAIN UON. VERIFY (E) CONDITIONS PRIOR TO PERFORMING WORK

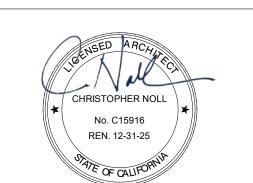

EXISTING COPPER ROOF, TO REMAIN

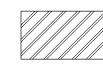

TPO MEMBRANE REPAIR, SEE DETAIL 6/A6.41 (DEDUCT ALTERNATE #1)


LIFELINE FALL RESTRAINT SYSTEM. POST ANCHOR SHOWN CONCEPTUALLY (DEDUCT ALTERNATE #2)

PROJECT TITLE

SONOMA COUNTY PETALUMA REGIONAL LIBRARY RENOVATION PROJECT NO.

100 FAIRGROUNDS DRIVE PETALUMA, CA 94952

PERMIT SET

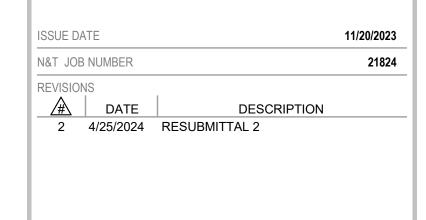

REVIEWED FOR CODE COMPLIANC 05/03/2024 Shums Coda Associates

TPO MEMBRANE REPAIR, AS REQUIRED AT BASEPLATE,TYP ROOF GUARDRAIL - SAFETY GATE AT LADDER

A2.33 1/4" = 1'-0"

ROOF PLAN

SHEET NUMBER

A2.33

APPROVALS

www.


5 GALVANIZED STEE RAILINGS, 1-1/4" PIPE (1.66" OD) TPO MEMBRANE REPAIR, AS REQUIRED AT BASEPLATE,TYP $\sim\sim\sim\sim\sim$ 3 **ROOF GUARDRAIL**A2.33 1/4" = 1'-0" · (DEDUCT ALTERNATE #2)≺

GALVANIZED STEEL
SAFETY GATE, SIZED
TO ATTACH TO (E)

- GALVANIZED STEEL

1-1/4" PIPE (1.66" OD)

RAILINGS,

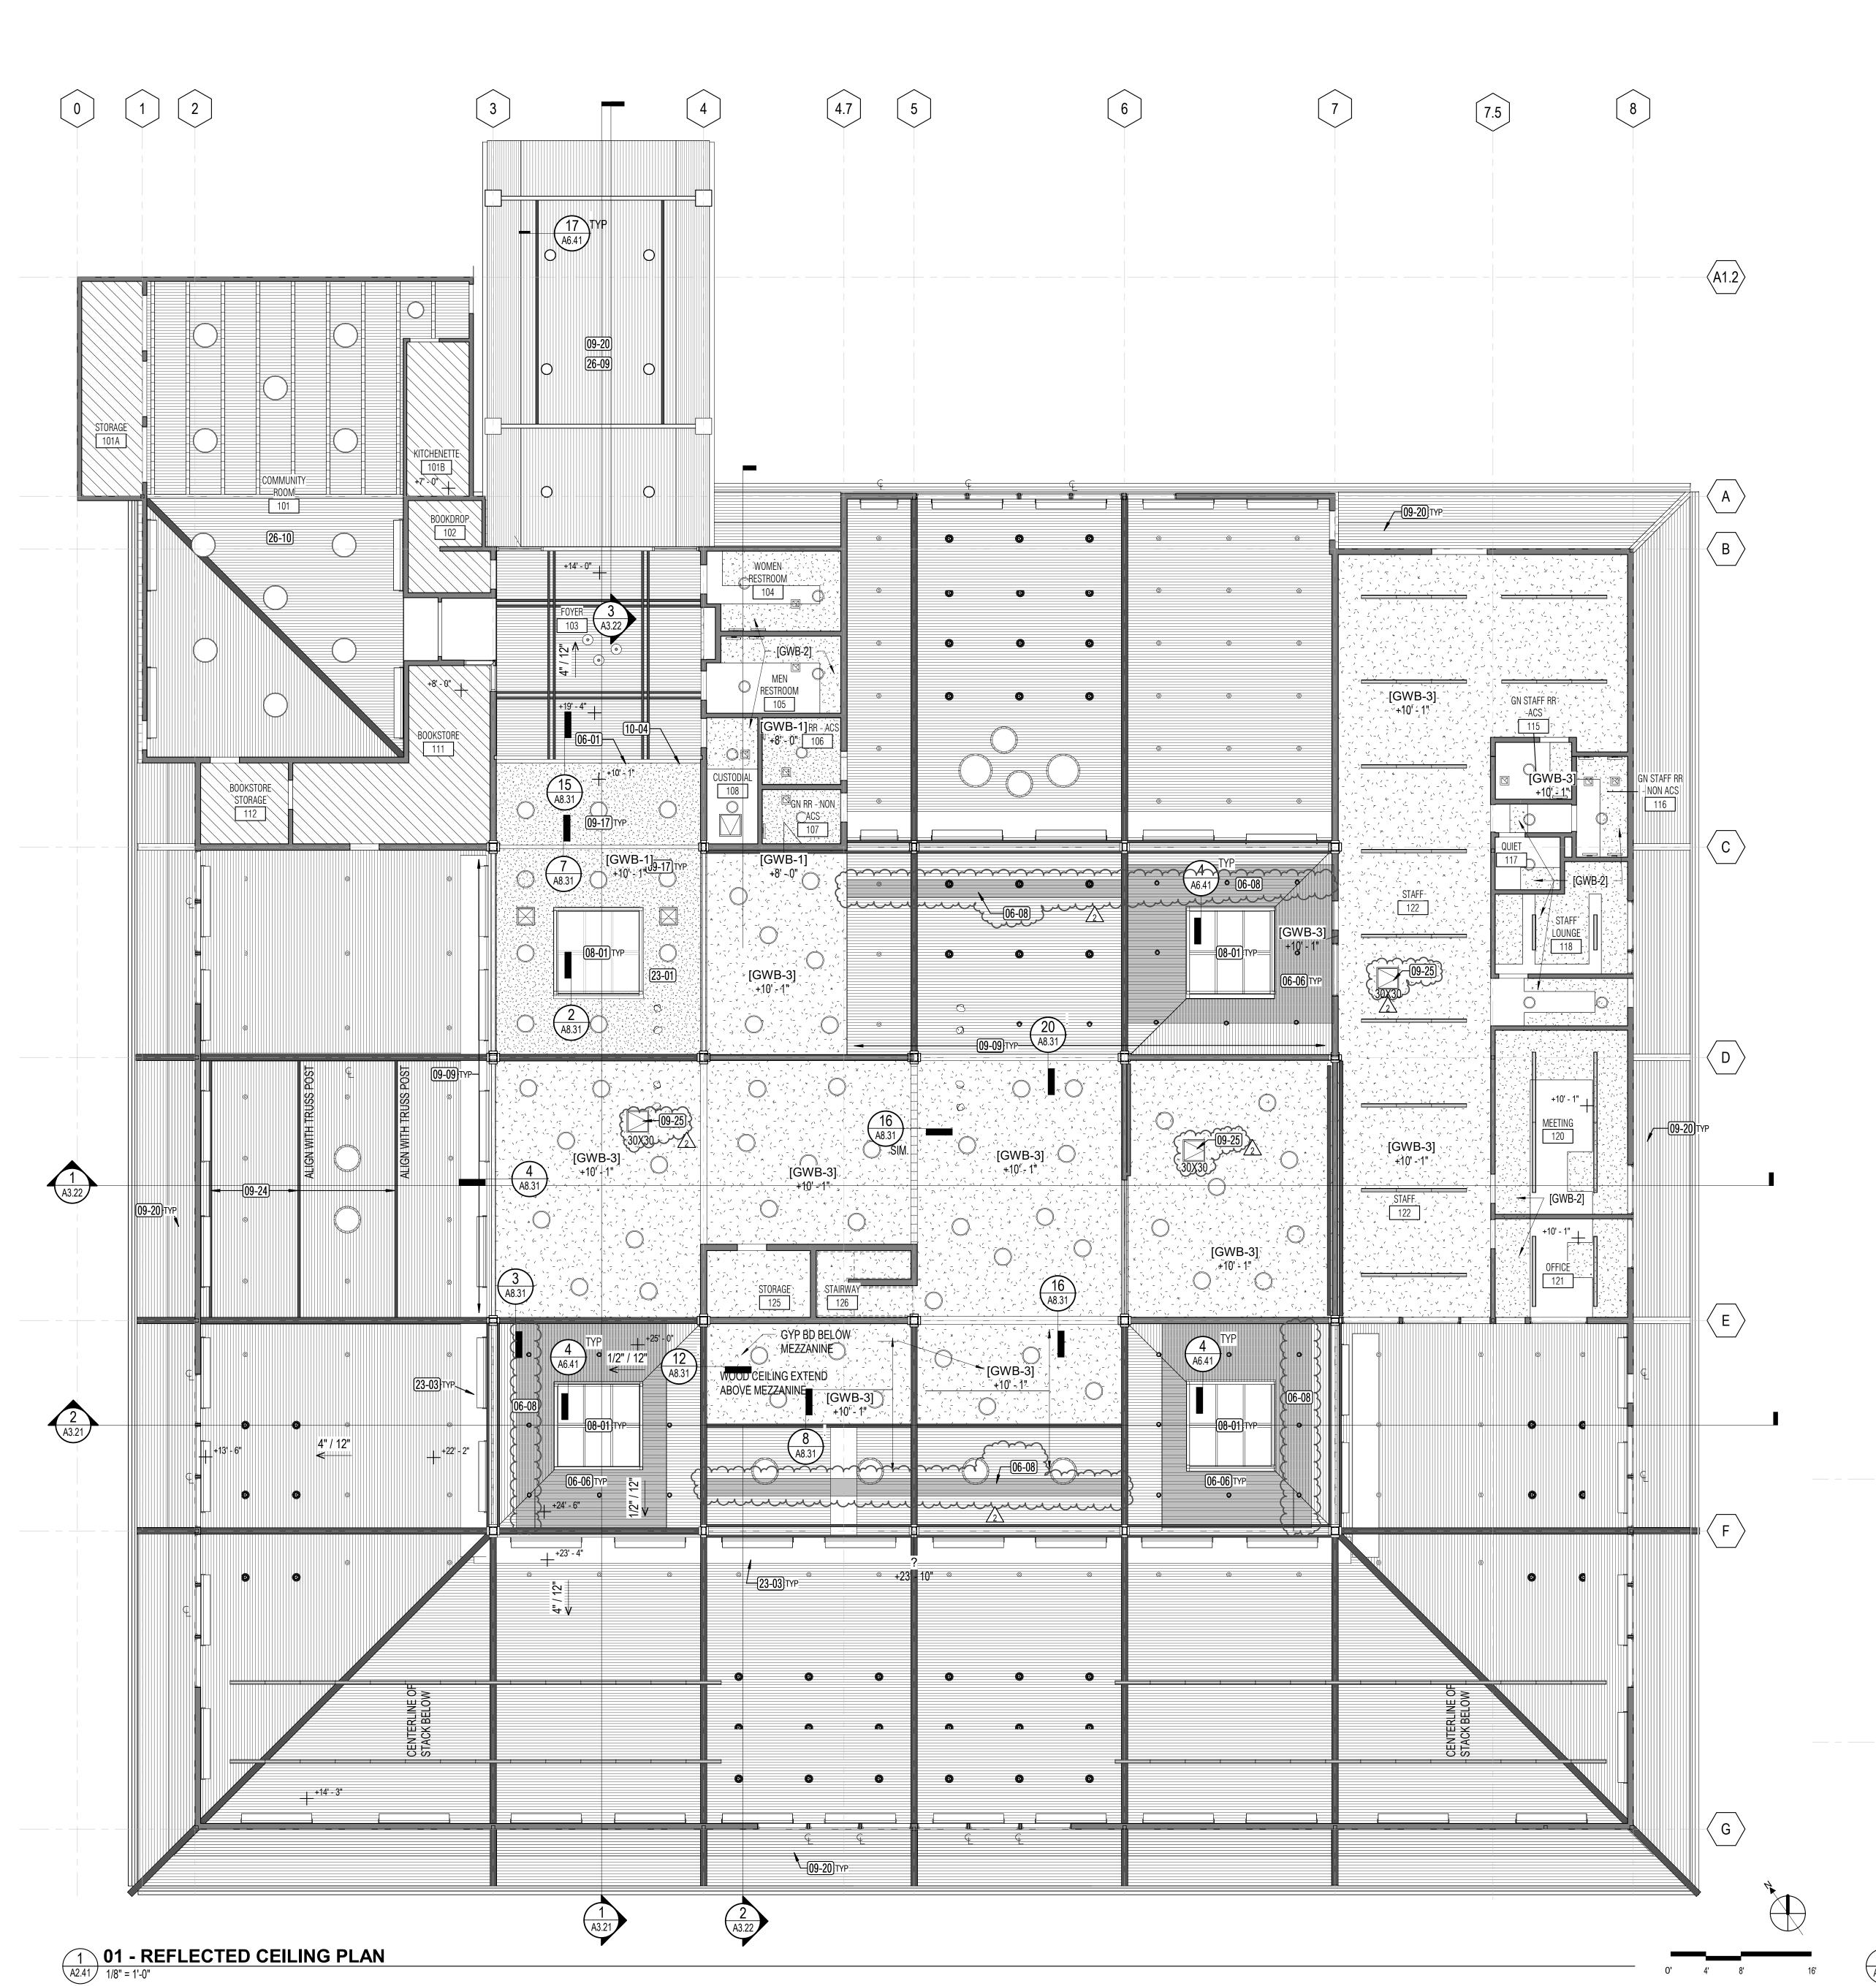

- 1. THE EXISTING CEILING SHALL BE REPLACED IN KIND WHERE AFFECTED BY FIRE PROTECTION, STRUCTURAL, MECHANICAL AND ELECTRICAL WORK. REFER TO OTHER SHEETS.
- 2. AT THE CEILING ROOF, THE EXISTING T&G WOOD OVER GYP BD OVER 2X STRIPPING OVER EXISTING TRUSS JOISTS, SHALL REMAIN IN PLACE UON. 3. CONTRACTOR TO COORDINATE CEILING FINISHES REPAIR AND REPLACEMENT IN KIND WITH OTHER TRADES TO AVOID CONFLICTS WITH WORK FROM OTHER SECTIONS.
- 4. SEE FIRE SPRINKLER DRAWINGS FOR SCOPE OF WORK. 5. WHERE EXISTING ROOF INSULATION ARE REMOVED FOR WORK, REPLACE
- WITH R-30 INSULATION. 6. EXTENT OF EXISTING MECHANICAL DUCTWORK AT INTERIOR OF BUILDING ARE NOT SHOWN. REFER TO RECORD DWGS FOR SCHEMATIC MECHANICAL LAYOUT CONCEALED IN ATTIC SPACES.
- 7. WHERE EXISTING SUSPENSION SYSTEM IS REPLACED WITH NEW, IT SHALL BE REPLACED AND/OR UPGRADED TO MEET CURRENT CODE. 8. SUSPENDED GYP BD CEILING UNDER MEZZANINE TO BE COORDINATED WITH
- FIRE SPRINKLER SYSTEM AND MOUNTING HEIGHT TO BE AS HIGH AS

9. FINAL HEIGHT OF SUSPENDED GYP BD TO BE VERIFIED WITH FIELD

CHRISTOPHER NOLL No. C15916 REN. 12-31-25 2 10 REFER TO SHT A2.42 FOR LIGHTING LAYOUT **KEYNOTE LEGEND Keynote Text**

ARCHITECTS

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SONOMA COUNTY

RENOVATION

PROJECT NO.

100 FAIRGROUNDS DRIVE

DESCRIPTION

PETALUMA, CA 94952

PERMIT SET

PETALUMA

REGIONAL

LIBRARY

Berkeley, CA 94710

(DEDUCT ALTERNATE #1) RE-INSTALL EXISTING SALVAGED T&G
CEILING IN KIND, PROVIDE BUILDING INSULATION IN AFFECTED AREAS OF WORK FOR SKYLIGHTS. (DEDUCT ALTERNATE #2) RE-INSTALL EXISTING SALVAGED T&G
CEILING IN KIND. PROVIDE BUILDING INSULATION IN AFFECTED AREAS
OF WORK FOR ROOF LIFELINE SYSTEMS. (DEDUCT ALTERNATE #1) PROVIDE 10'X10' SKYLIGHT ON RAISED CURB. PROVIDE MODIFICATION OF EXISTING MEMBRANE ROOFING FLASHING AND ROOF CRICKETS AS REQUIRED FOR DRAINAGE AND WATERPROOFING AROUND SKYLIGHT. AUGMENTATION OF ROOF DIAPHRAGM, NAILING, AS REQUIRED WITH ASSOCATED DEMO AND NEW WORK.SEE STRUCTURAL DWGS PROVIDE WALL MOUNTED 2" THK ACOUSTICAL PANELS, EXTRUDED POLYESTER, FROM TOP OF (E)BEAM TO UNDERSIDE OF (E) T&G CEILING. PROVIDE GYP BD TO UNDERSIDE OF CEILING JOIST. (ADD ALTERNATE #1) SAND AND REFINISH EXISTING EXTERIOR T&G SIDING IN KIND OVER EXISTING ASSEMBLY, AT ENTRY CANOPY AND SOFFIT AROUND PERIMETER OF BUILDING. PROVIDE FINISH AT (3) STRUCTURAL MEMBERS TO MATCH EXISTING ADJACENT TRUSS

PROVIDE BEAM FOR SUPPORT OF EXISTING OVERHEAD WALL DUE TO

PROVIDE CEILING ACCESS PANEL AT GYP BD CEILING. MATCH EXISTING SIZE AND LOCATION, WHERE OCCURS. FIELD VERIFY. 10-04 PROVIDE MOTORIZED SECURITY ROLL-UP GRILLE WITH KEYSWITCH ON BUTTON - SSD FOR EXTENT OF STRUCTURAL WORK FOR GUIDE RAIL MOUNTING. SALVAGE AND RE-INSTALL WALL T&G SIDING FINISHES IN KIND AS AFFECTED BY NEW WORK. PROVIDE NEW MATCHING IN KIND.

REROUTE MECHANICAL TO ALLOW FOR SKYLIGHT WELL. SMD. EXISTING MECHANICAL DUCTWORK, TO REMAIN. PAINT (E) EXPOSED

DUCTWORK

(ADD ALTERNATE #2) REMOVE AND REPLACE DIGHT FIXTURES AT ENTRY CANOPY. SED

(ADD ALTERNATE #3) REMOVE AND REPLACE LIGHT FIXTURES AND CONTROLS IN COMMUNITY ROOM, SED

RCP LEGEND

EXISTING T&G CEILING EXISTING GYP BD CEILING


EXISTING CEILING TO REMAIN

SALVAGE AND REINSTALL (E)T&G CEILING ASSEMBLY IN KIND (INCLUDING NEW GYP BD AND STRIPPING) DEDUCT ALTERNATE #1 & #2

GYP BD CEILING OVER FRAMING, SSD (GWB-1)

GYP BD, REPLACEMENT TO MATCH EXISTING. (GWB-2) OVER EXISTING WOOD FRAMING. REMOVE AND REPLACE AS NECESSARY FOR FIRE SPRINKLER WORK.

GYP BD OVER METAL SUSPENSION SYSTEM (GWB-3) SEE CEILING DETAILS ON A8.32 AND A8.33

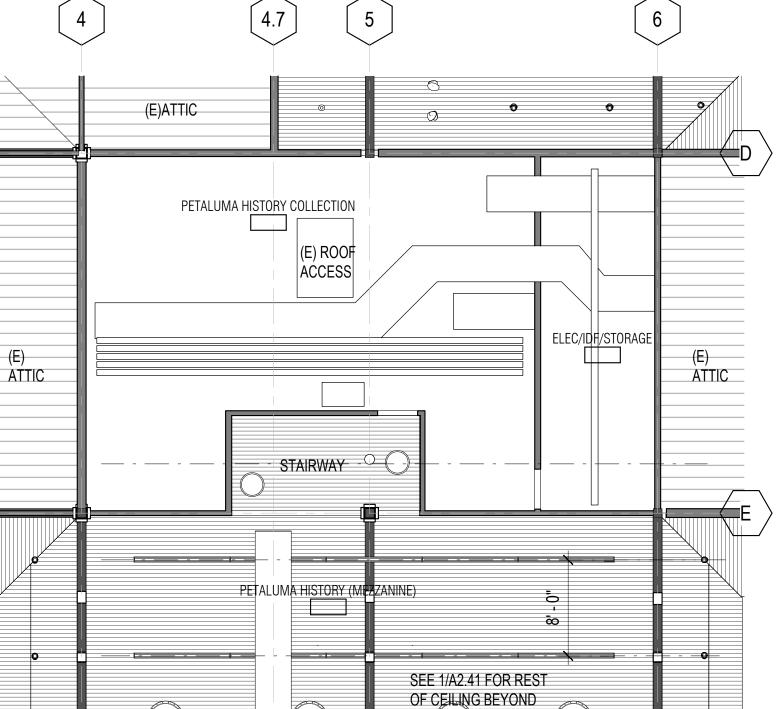

REVIEWED FOR CODE COMPLIANCE 05/03/2024 Shums Coda Associates

2 4/25/2024 RESUBMITTAL 2

PROJECT TITLE

ISSUE DATE

REVISIONS

N&T JOB NUMBER


SHEET TITLE REFLECTED CEILING

SHEET NUMBER

A2.41

APPROVALS

2 MEZZANINE - RCP
A2.41 1/8" = 1'-0"

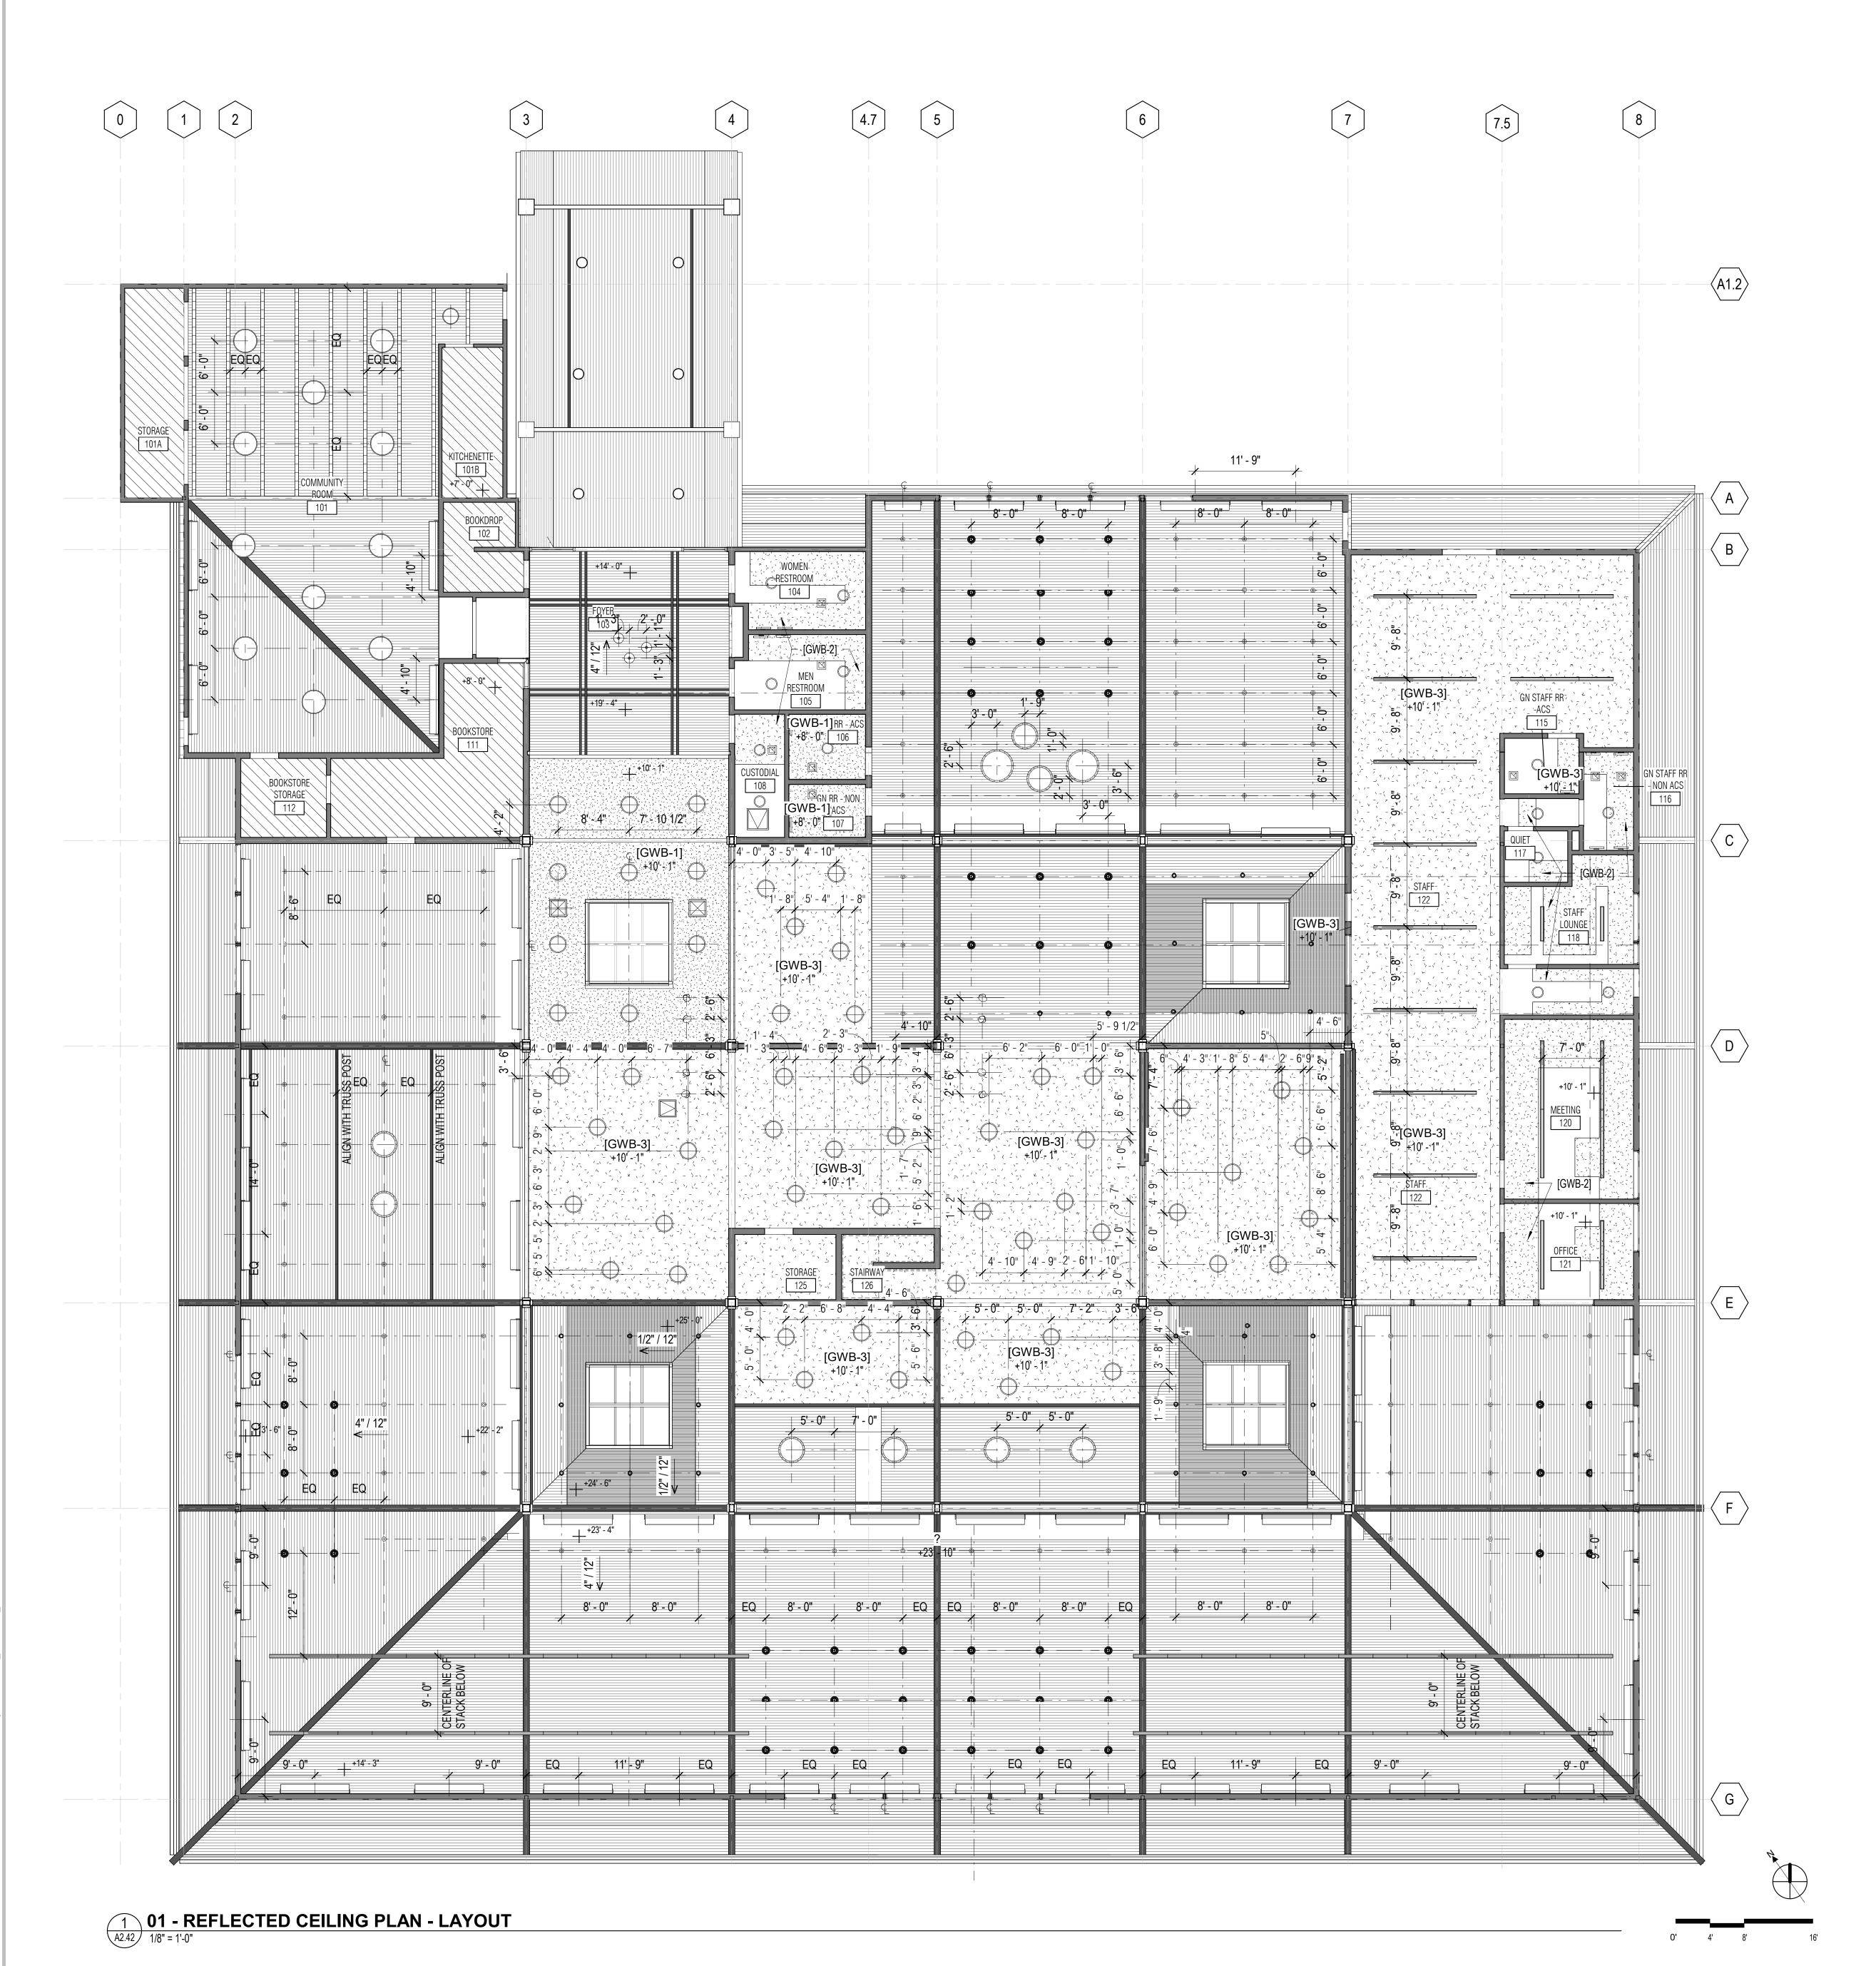

NOLL & TAM ARCHITECTS

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CHRISTOPHER NOLL

No. C15916

REN. 12-31-25

PROJECT TITLE

PETALUMA
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PROJECT NO.
10-19

100 FAIRGROUNDS DRIVE PETALUMA, CA 94952

PERMIT SET

ISSUE DATE 11/27/2

N&T JOB NUMBER 21

REVISIONS

DATE DESCRIPTION

05/03/2024
Shums Coda Associates

SHEET TITLE


REFLECTED CEILING PLAN- LIGHTING LAYOUT

SHEET NUMBER

A2.42

APPROVALS

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- 1. REFER TO SHT A2.41 FOR GENERAL NOTES, KEYNOTE LEGEND AND RCP
- 2. THIS IS AN ALTERNATE REFLECTED CEILING PLAN FOR DEDUCT ALTERNATE # 1 FOR AREAS OF (4) SKYLIGHTS AND ASSOCIATED WORK. ALL OTHER AREAS ARE SAME AS SHEET A2.42.

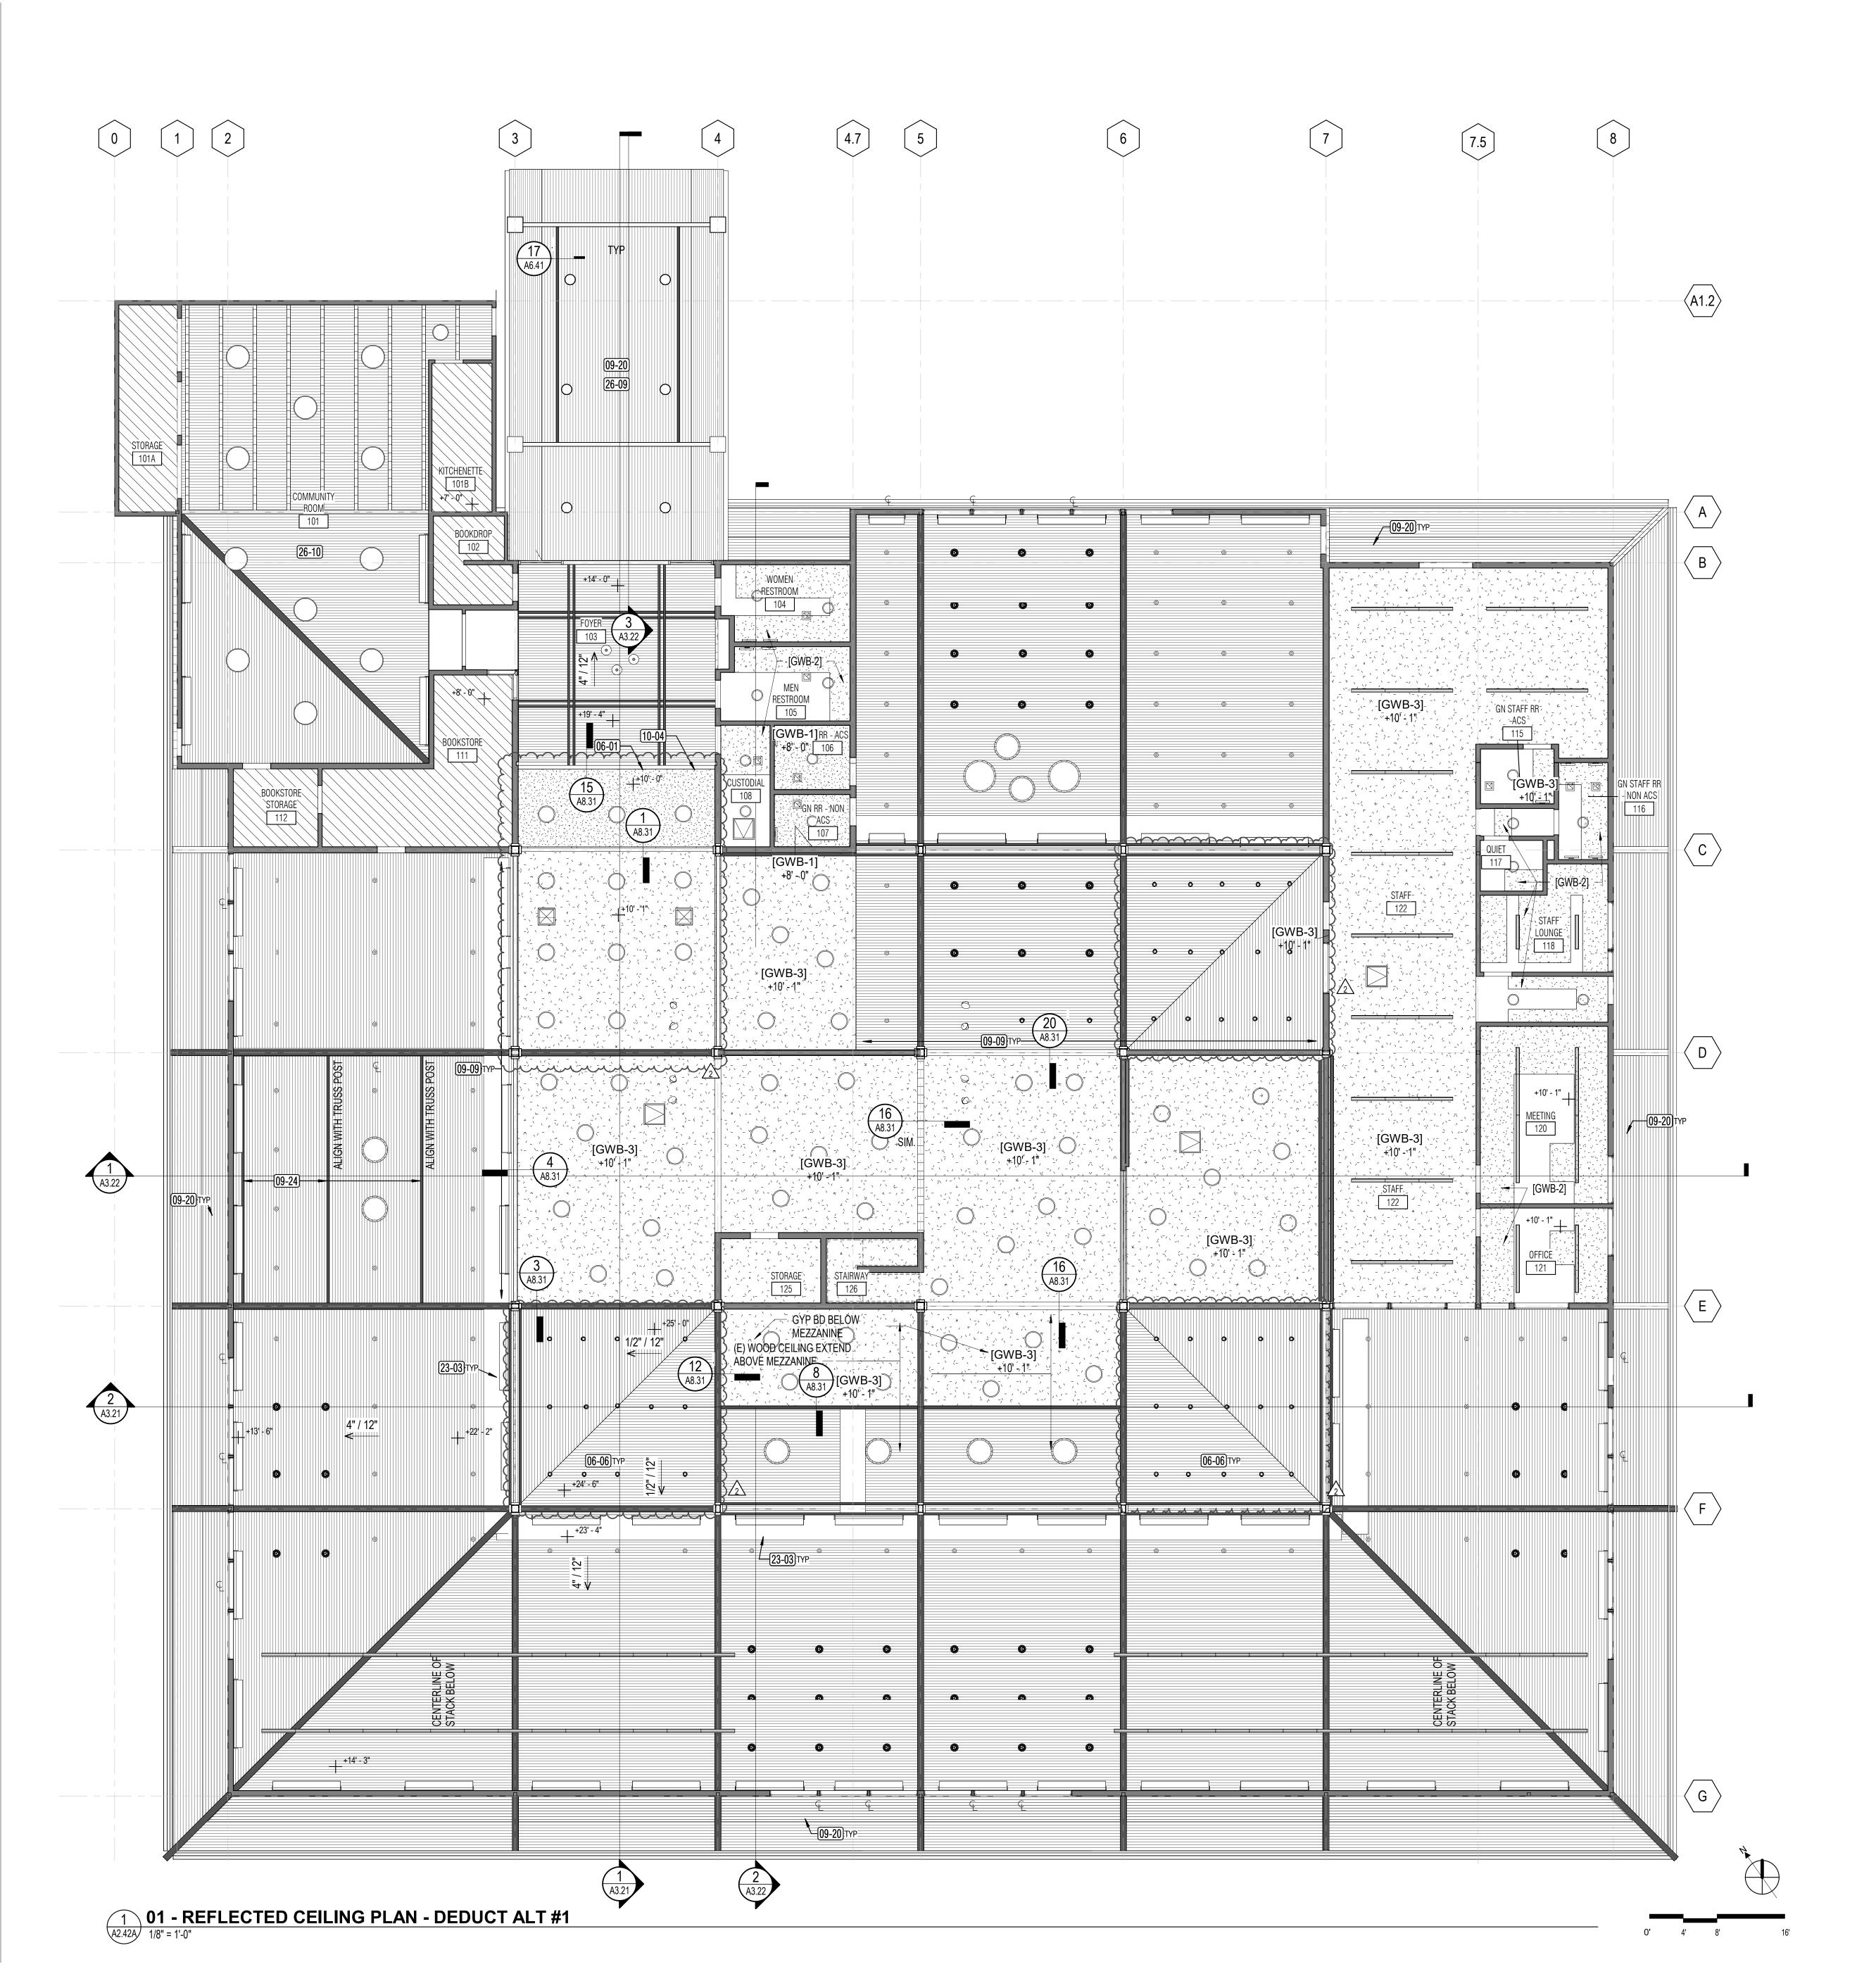 \cdots

3. REFER TO STRUCTURAL, MECHANICAL, ELECTRICAL, AND FIRE PROTECTION DRAWINGS FOR REVISIONS ASSOCIATED WITH DEDUCT ALTERNATE #1.

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ARCHITECTS

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PROJECT TITLE

SONOMA COUNTY PETALUMA REGIONAL LIBRARY RENOVATION PROJECT NO.

100 FAIRGROUNDS DRIVE PETALUMA, CA 94952

PERMIT SET

ISSUE DATE

N&T JOB NUMBER

REVISIONS

DATE DESCRIPTION

2 4/25/2024 RESUBMITTAL 2 DESCRIPTION


> REVIEWED FOR CODE COMPLIANCE 05/03/2024


> > Shums Coda Associates

REFLECTED CEILING ₹ PLAN - DEDUCT **ALTERNATE #1**

SHEET NUMBER

A2.42A

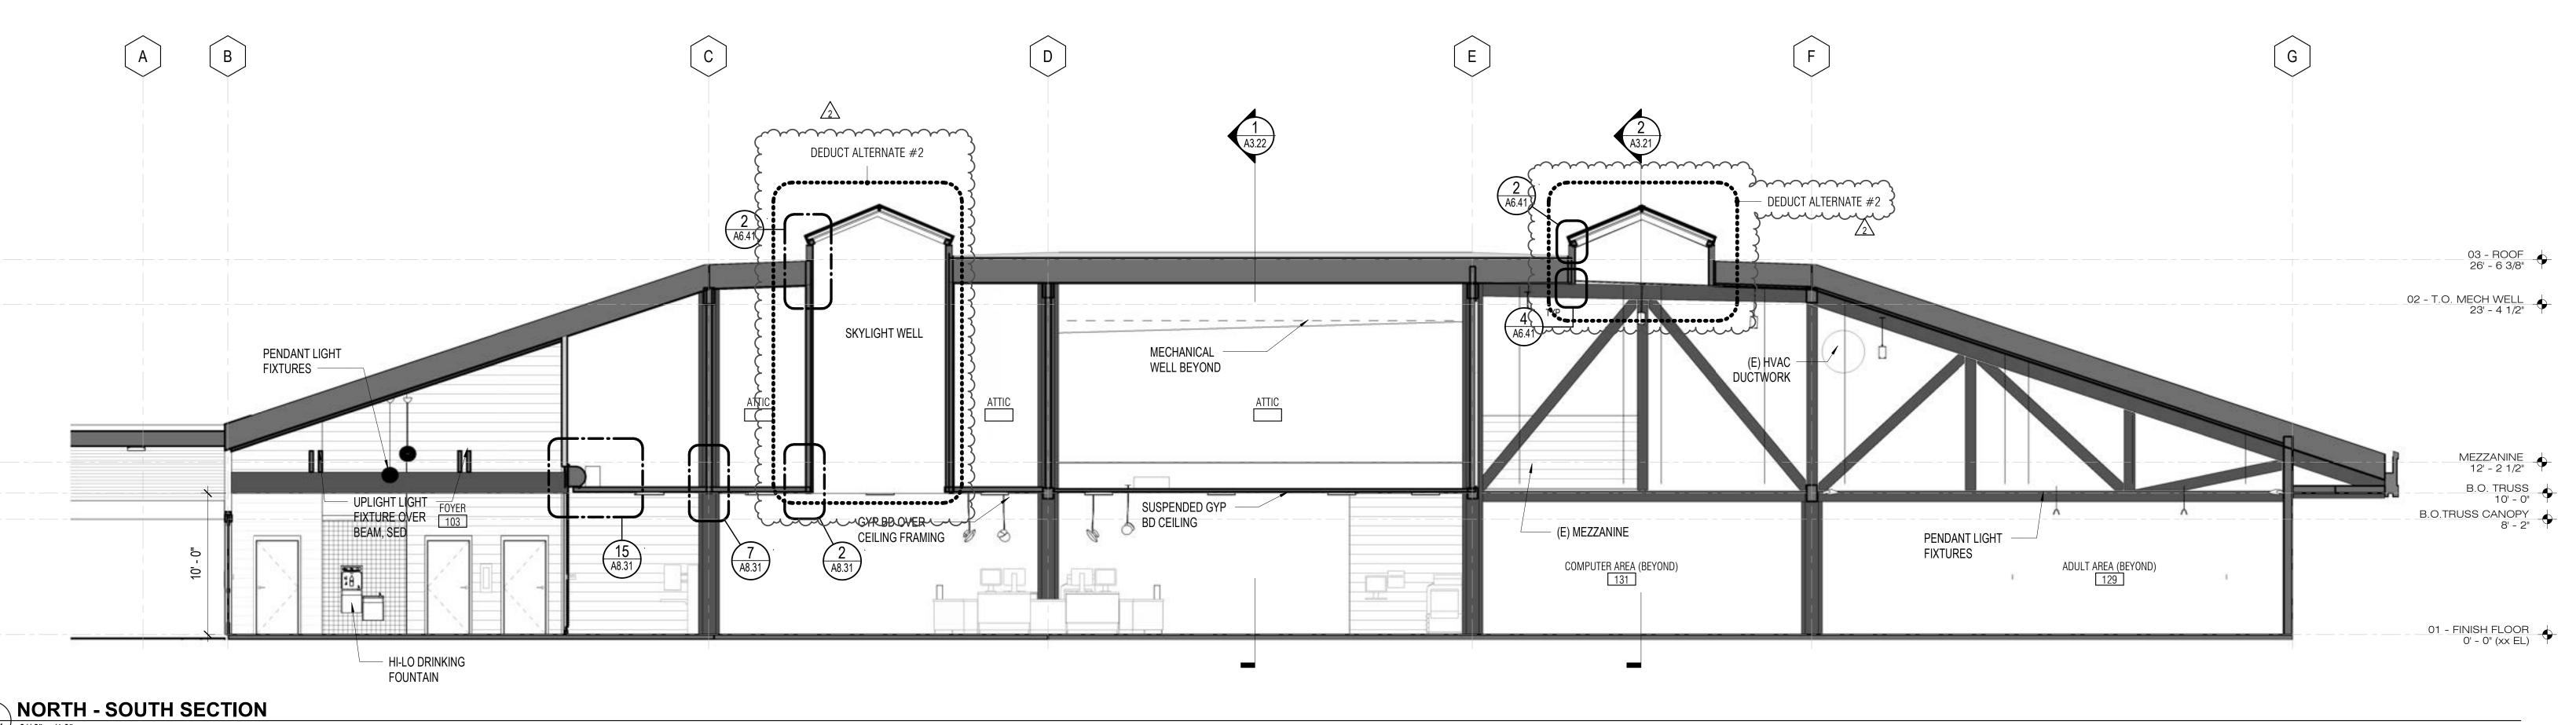

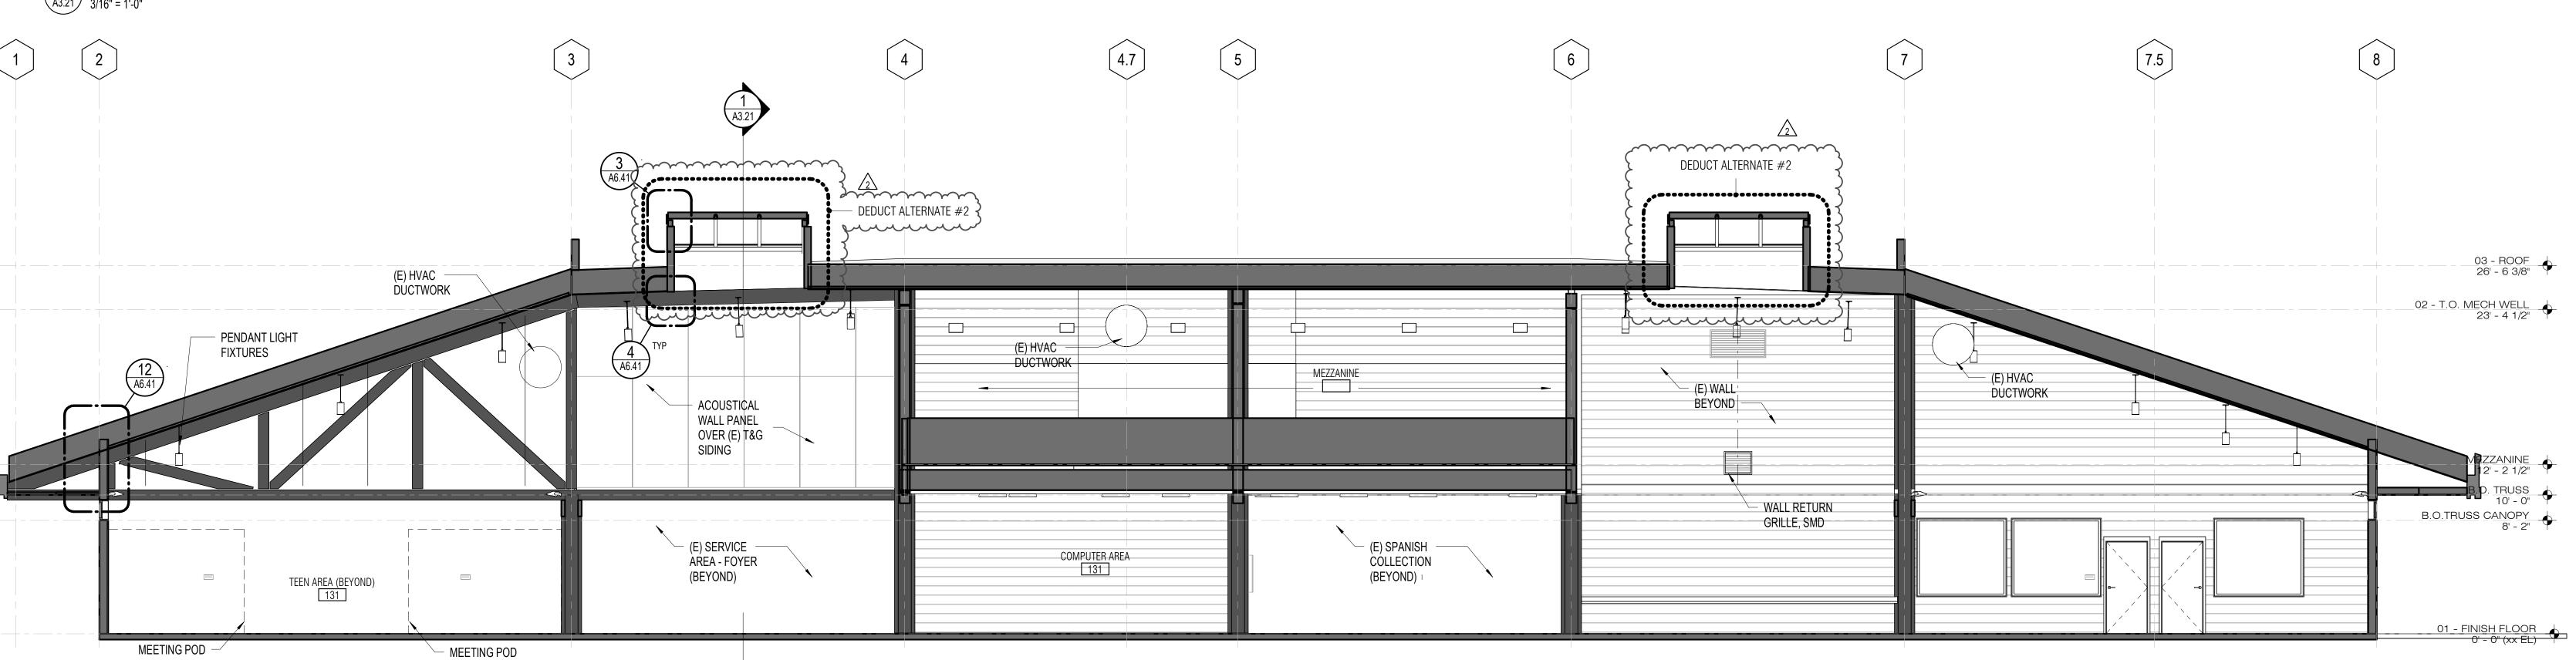


2 **EAST-WEST SECTION**A3.21 3/16" = 1'-0"

GENERAL NOTES

- REFER TO DEMO PLAN, DEMO RCP, FLOOR PLAN, RCP, INTERIOR ELEVATIONS, DETAILS, AND FINISH SCHEDULE FOR ADDITIONAL INFO ON SCOPE OF WORK
- CONTRACTOR TO COORDINATE REMOVAL, REPAIR AND REPLACEMENT OF CEILING ASSEMBLY WITH OTHER TRADES TO AVOID CONFLICTS WITH WORK FROM OTHER SECTIONS.
 REFER TO MECHANICAL ELECTRICAL FIRE SPRINKLER AND STRUCTURAL
- 3. REFER TO MECHANICAL, ELECTRICAL, FIRE SPRINKLER AND STRUCTURAL DWGS FOR ADDITIONAL WORK.

NOLL & TAM ARCHITECTS

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PROJECT TITLE

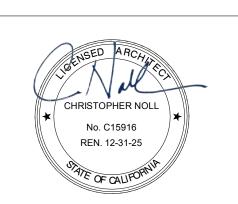SONOMA COUNTY
PETALUMA
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PROJECT NO.
10-19

100 FAIRGROUNDS DRIVE PETALUMA, CA 94952

PERMIT SET

REVIEWED FOR CODE COMPLIANCE

05/03/2024

Shums Coda Associates

SHEET TITLE


BUILDING SECTIONS

SHEET NUMBER

A3.21

APPROVALS


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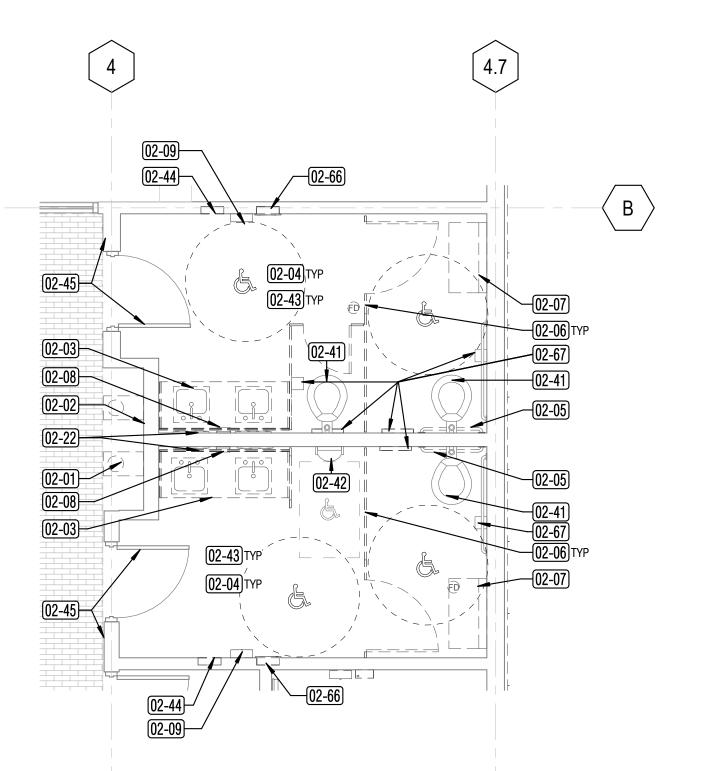


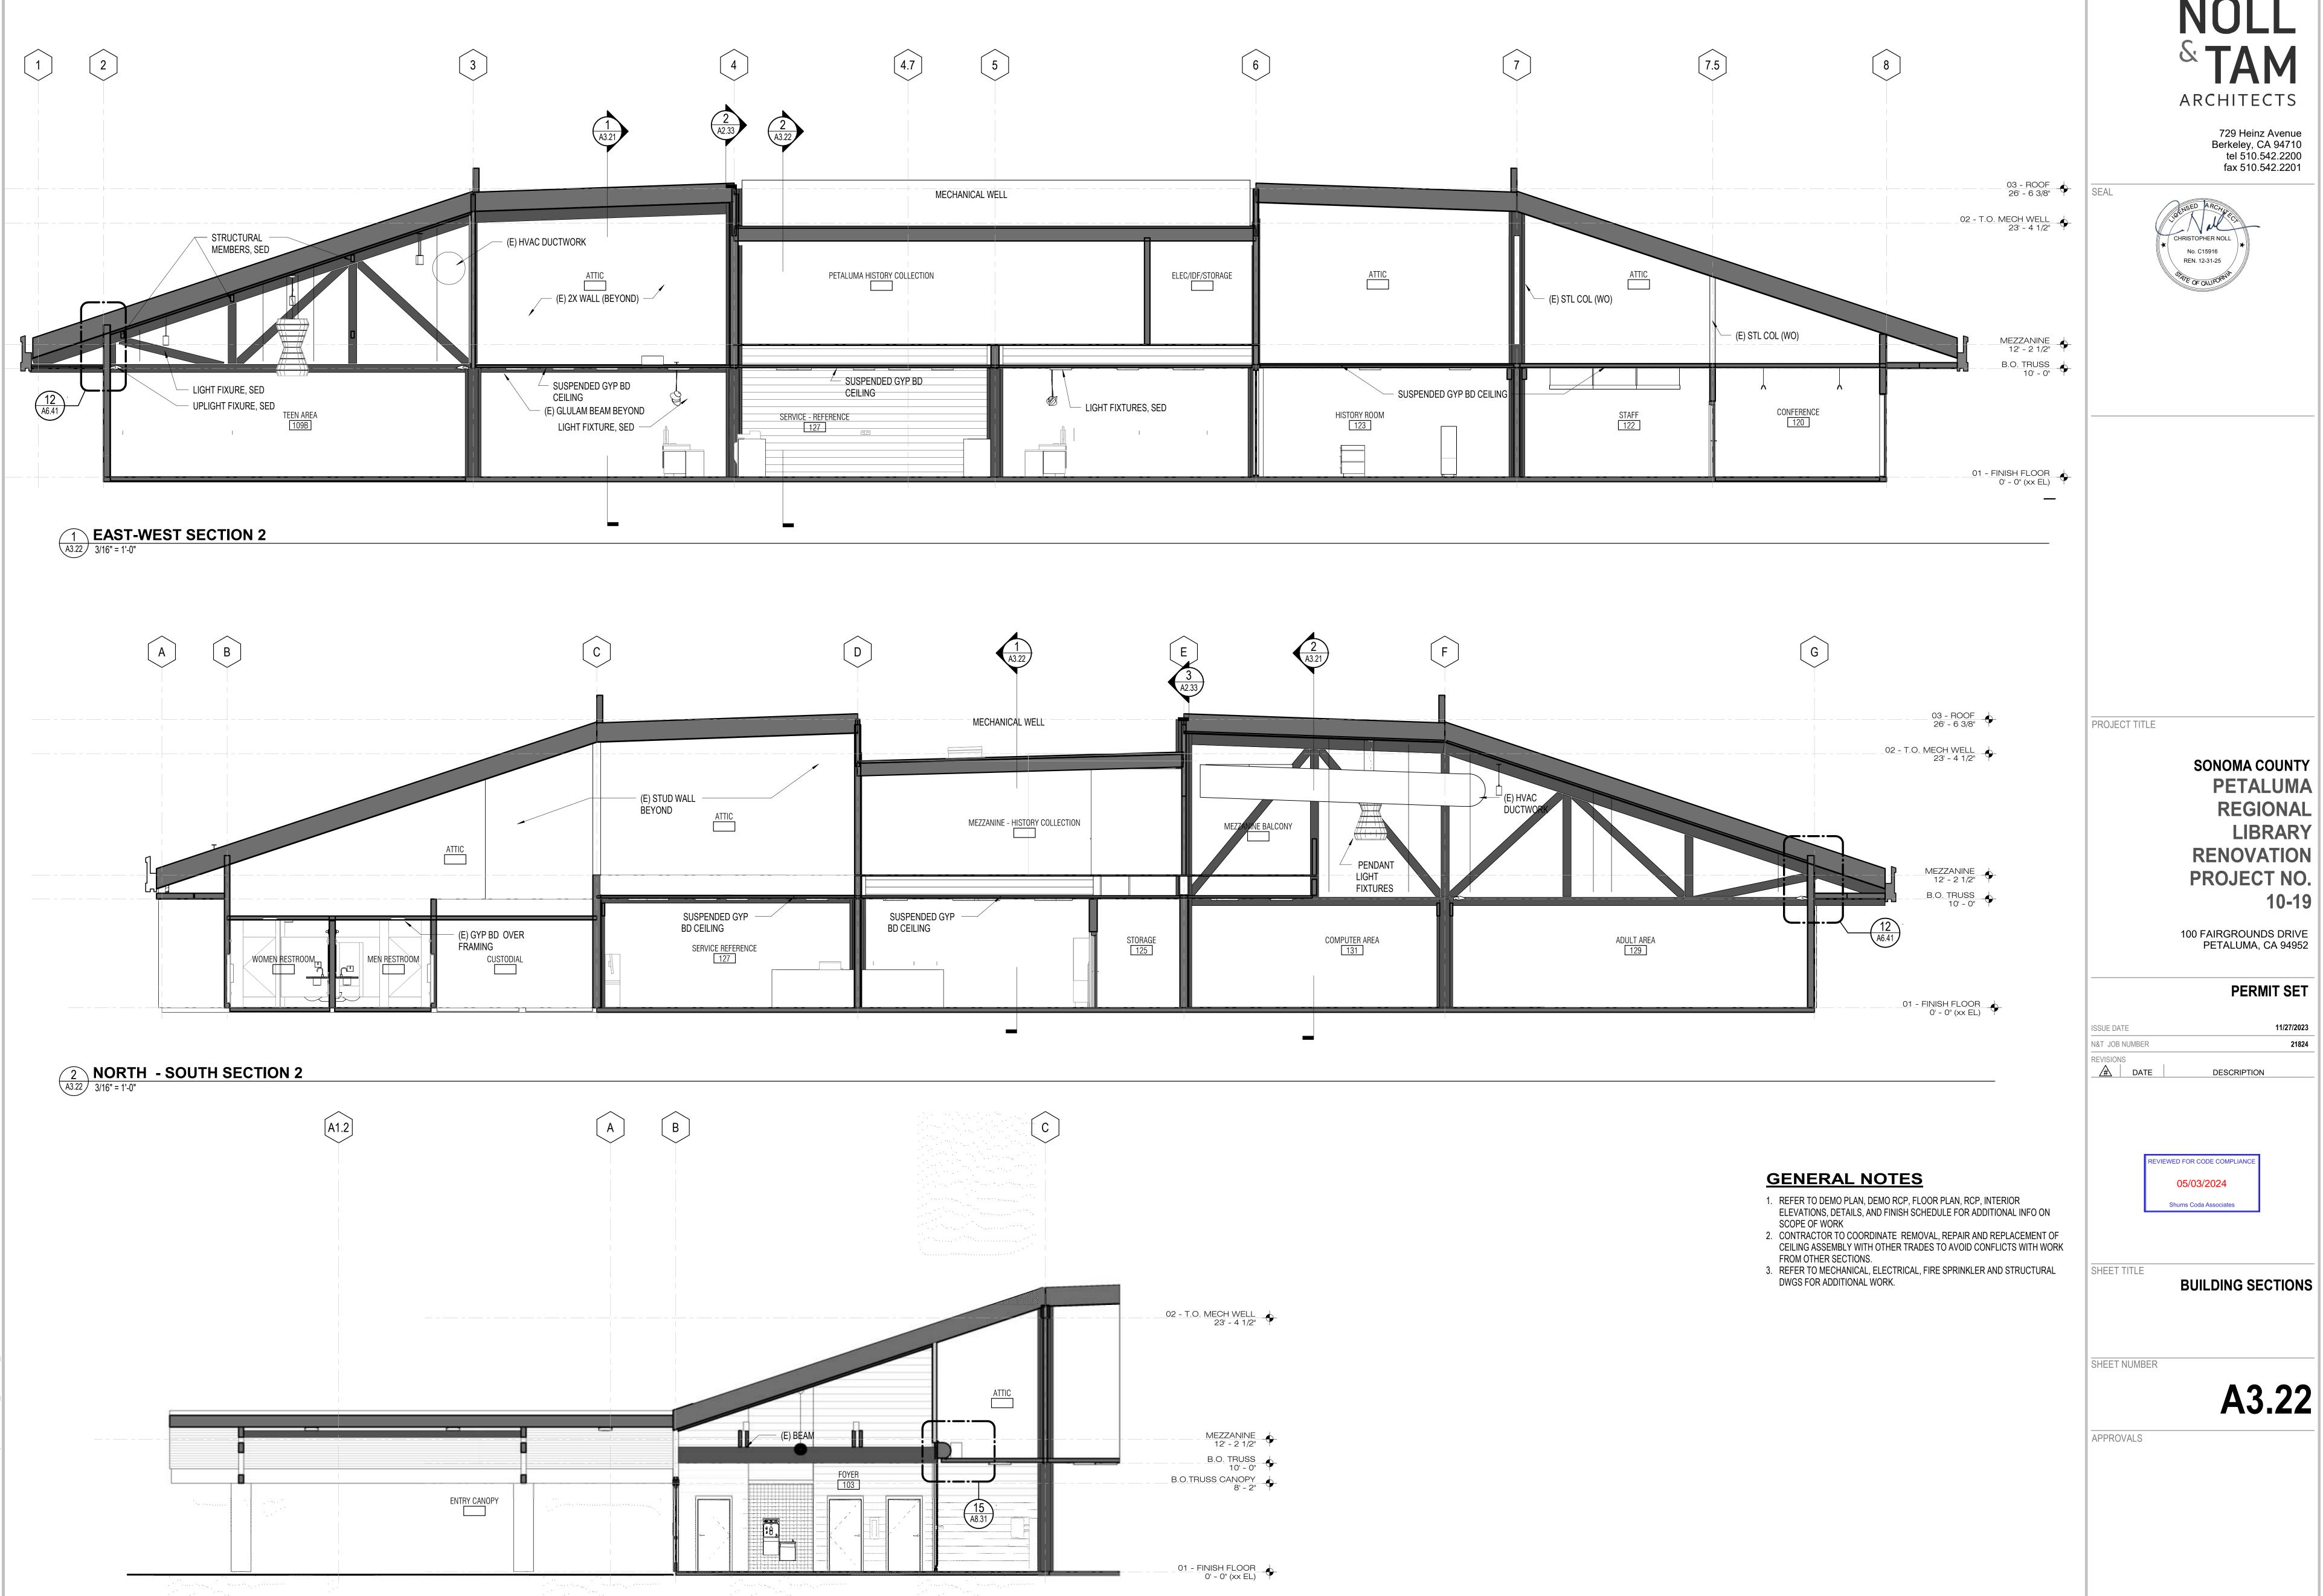NORTH - SOUTH SECTION - ENTRY CANOPY


A3.22 3/16" = 1'-0"


PETALUMA REGIONAL LIBRARY RENOVATION PROJECT NO.



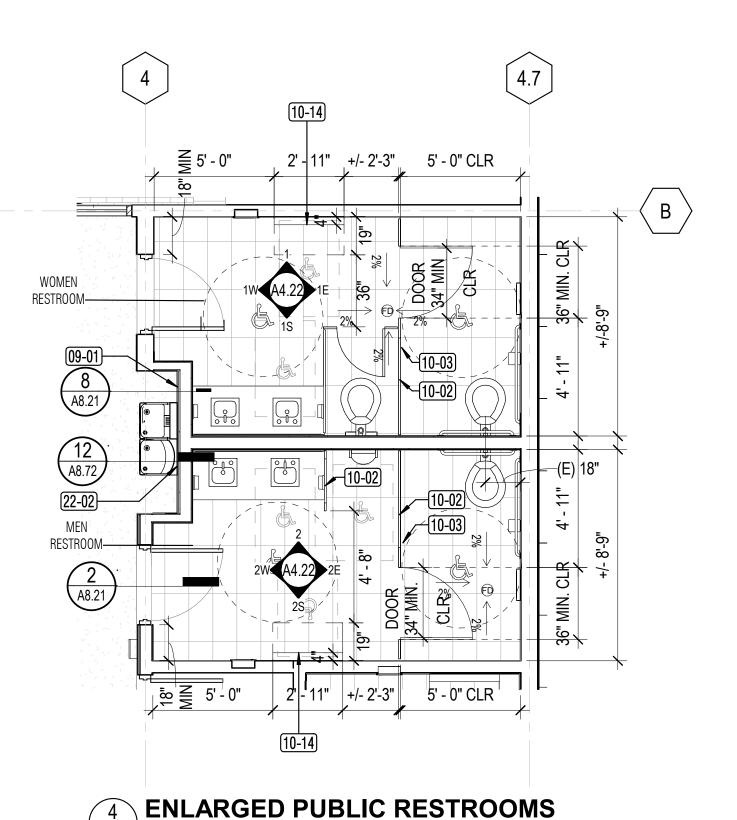

ENLARGED PUBLIC RESTROOMS (DEMO)

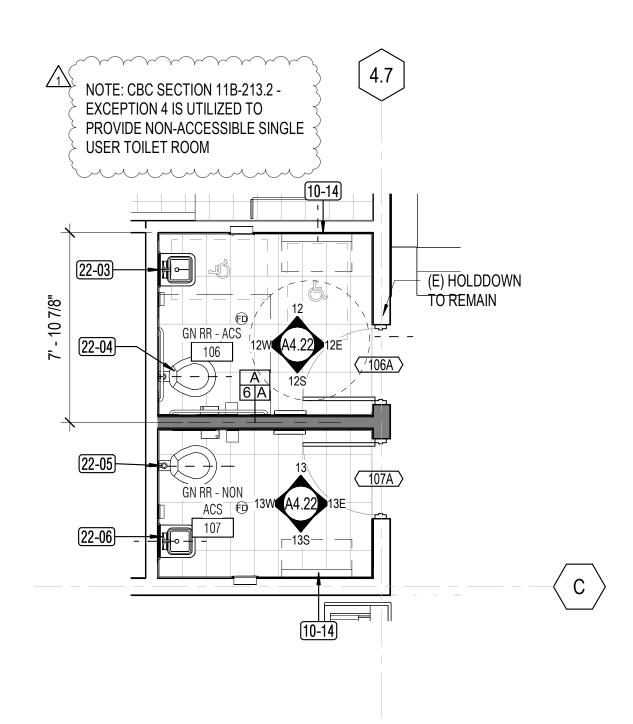


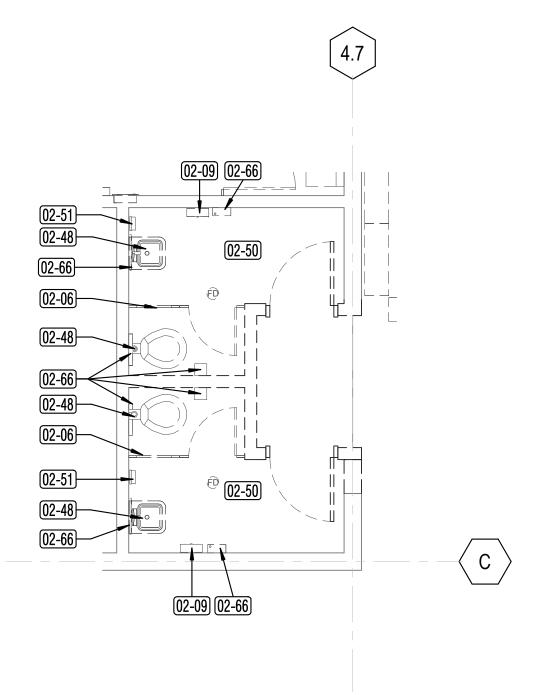


5 ENLARGED RESTROOM - 106 & 107 - CHILDREN AREA

ENLARGED RESTROOM - 106 & 107 - CHILDREN AREA

(DEMO)

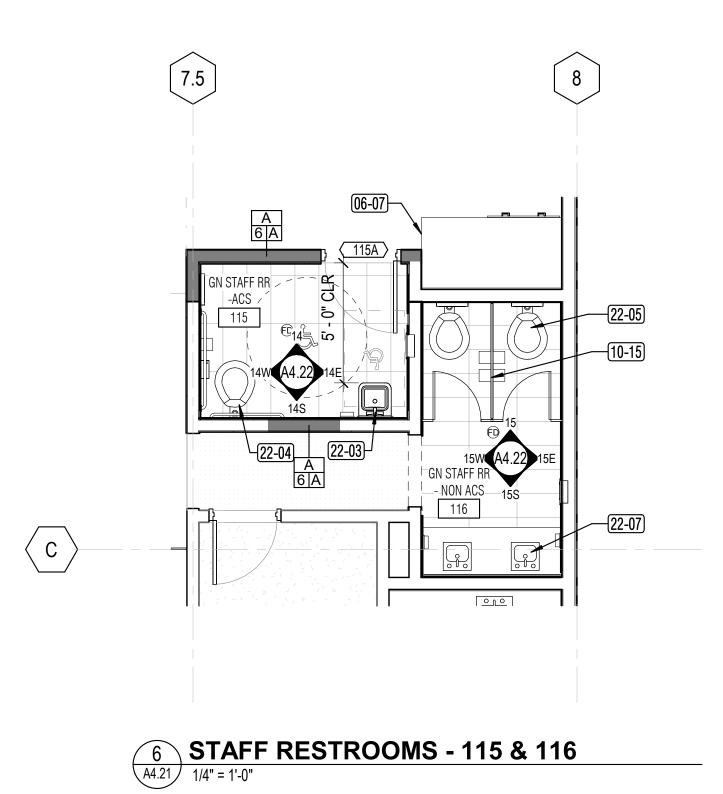

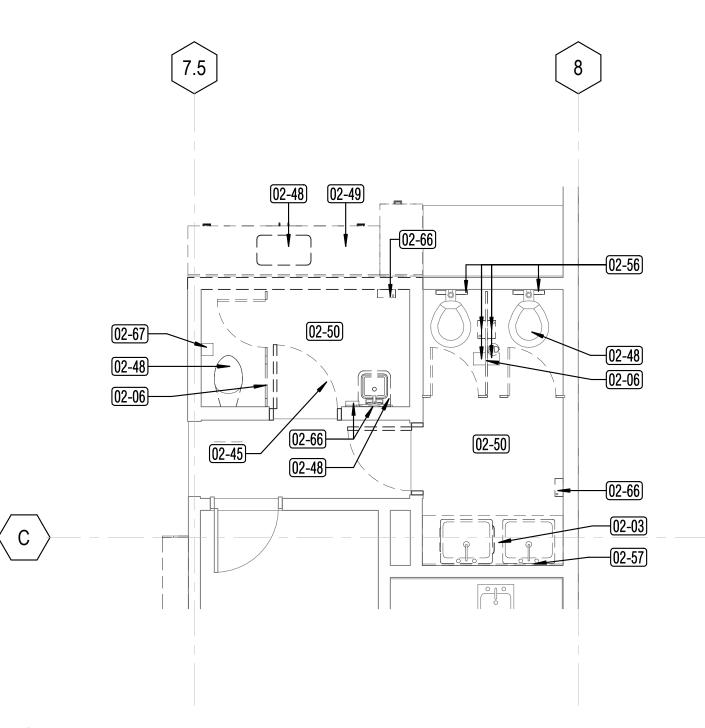

3 STAFF RESTROOM - 115 & 116 (DEMO)

PROJECT NOTES

1. EXISTING PUBLIC MEN AND WOMEN TOILET ROOM WAS PART OF ORIGINAL 1974 BUILDING. TOILET ROOM WAS RENOVATED IN 1999. AT TIME OF RENOVATION, BABY CHANGING STATIONS WERE PERMITTED INSIDE THE ACCESSIBLE TOILET COMPARTMENT STALL. FOR THE LIBRARY REFRESH PROJECT, THE RESTROOM ARE UPDATED WITH FINISHES, LAVATORY SINK UNIT, TOILET COMPARTMENT (WHERE OCCURS ON PLAN), AND INSTALLATION OF TOILET ACCESSORIES TO 2022 CBC. THE BABY CHANGING STATION IS RELOCATED OUTSIDE OF THE ACCESSIBLE TOILET COMPARTMENT. TO ACCOMODATE EXISTING BUILDING RESTROOM CONDITIONS, DOOR TO ACCESSIBLE COMPARTMENT IS LOCATED AS SUCH (GREATER THAN 4" MAX FROM CORNER) TO ALLOW THE BABY CHANGING TABLE TO NOT ENCROACH INTO PATH OF TRAVEL. THE ACCESSIBLE TOILET THE CHILDREN'S RESTROOMS FOR THE LIBRARY REFRESH PROJECT ARE UPDATED WITH ONE ACCESSIBLE GENDER NEUTRAL RESTROOM WITH BABY CHANGING STATION. THE OTHER IS NON-ACCESSIBLE RESTROOM BUT ALSO HAS A BABY CHANGING STATION AT REQUEST OF THE LIBRARY. 3. THE EXISTING STAFF RESTROOM ARE FROM 1974. THE MEN'S AND WOMEN'S STAFF RESTROOM ARE NON-ACCESSIBLE. IN THE LIBRARY REFRESH PROJECT, ONE ACCESSIBLE GENDER NEUTRAL RESTROOM AND ONE NON-ACCESSIBLE GENDER NEUTRAL RESTROOM WITH FULL HEIGHT PRIVACY TOILET COMPARTMENT, WILL BE PROVIDED. PLUMBING FIXTURE COUNT REMAINS SAME

Key Value	Keynote Text				
06-07	REPAIR SIDES OF THE BASE CABINET. ADD SIDEPANEL AND LAMINATE EDGING AS REQUIRED TO COVER TRIMMED EDGES				
09-01	PROVIDE CERAMIC TILE FINISH AT ALCOVE WALLS				
10-02	PROVIDE FLOOR TO CEILING BRACED TOILET PARTITIONS AND URINAL SCREEN. COORDINATE TO MATCH EXISTING CEILING LOCATION.				
10-03	PROVIDE PULL-DOWN STAINLESS STEEL SHELVIING UNIT, MOUNTED TO TOILET PARTITION				
10-14	PROVIDE HORIZONTAL WALL MOUNTED STAINLESS STEEL BABY CHANGING STATION - 4" MAX PROTRUSION.				
10-15	PROVIDE FLOOR TO CEILING BRACED TOILET PARTITIONS, EXTENDED HEIGHT,. FULL PRIVACY WITH 1" FLOOR CLEARANCE - GAP FREE DOORS AND STILES				
22-02	PROVIDE PLUMBING ADJUSTMENTS NEEDED FOR NEW DRINKING FOUNTAIN UNIT. MOUNT AT COMPLIANT HEIGHT.				
22-03	ADJUST PLUMBING AS REQUIRED FOR ACCESSIBLE COMPLIANT SINK. SPD				
22-04	PROVIDE WATER CLOSET. ADJUST PLUMBING AS REQUIRED FOR ACCESSIBLE WATER CLOSET. SPD				
22-05	PROVIDE WATER CLOSET. SPD				
22-06	PROVIDE WALL MOUNTED SINK. SPD				
22-07	PROVIDE UNDERMOUNT SINK AT QUARTZ SURFACE COUNTERTOP, SPD				

GENERAL NOTES

1. FOR ACCESSIBLE FIXTURE AND ACCESSORY MOUNTING HEIGHTS AND DIMENSIONS, SEE G3.21
2. PROVIDE BLOCKING AS REQUIRED FOR ACCESSORY MOUNTING INCLUDING BUT

NOT LIMITED TO GRAB BARS, BABY CHANGING STATIONS, AND PARTITIONS INSIDE RESTROOMS. SEE A4.22
3. PROVIDE RELOCATION OF EXISTING WALL MOUNTED ACCESSORIES AS REQUIRED TO ACCOMODATE INSTALLATION OF NEW WALL FINISHES. EXISTING FA

REQUIRED TO ACCOMODATE INSTALLATION OF NEW WALL FINISHES. EXISTING FA DEVICES SHALL REMAIN IN PLACE U.O.N. - ADJUST AS REQUIRED FOR NEW WALL FINISHES.

4. SEE A8.21 FOR WALL AND FLOOR FINISH DETAILS

5. TOILET COMPARTMENT DOORS TO BE SELF-CLOSING TO MEET CBC 11B-604.8.1.2 6. DOOR PULLS AT TOILET COMPARTMENT DOORS TO COMPLY WITH CBC 11B-404.2.7 AND 11B-309.4. DOOR LATCH AND LOCKING MECHANISM TO COMPLY WITH CBC 11B-309. OPERABLE PARTS SHALL BE OPERABLE WITH ONE HAND AND SHALL NOT REQUIRE TIGHT GRASPING, PINCHING OR TWISTING OF WRIST. FORC TO ACTIVATE OPERABLE PARTS SHALL BE 5 LBS, MAX. DOOR PULLS TO BE MOUNTED ON BOTH SIDES OF DOOR NEAR LATCH. SEE SPEC SEC 10 21 13.17 FOR ADDITIONAL INFORMATION ON HARDWARE.


7. COAT HOOK TO BE MOUNTED ON TOILET ROOM OR TOILET COMPARTMENT DOOR, 48" AFF MAX.

8. ADJUST EXISTING FLOOR DRAINS AS REQUIRED FOR NEW FLOOR FINISH.
9. LOCATE AND ADJUST PLUMBING AND FIXTURES AT BUILT IN LAVATORY
COUNTERTOP TO MEET ACCESSIBILTY KNEE CLEARANCE REQUIREMENTS.
10. SEE INTERIOR ELEVATIONS FOR ADDITIONAL INFORMATION.
11. PROVIDE WALL ACCESS PANELS, AS REQUIRED FOR MECHANICAL & PLUMBING ACCESS, AND COORDINATE INSTALLATION WITH NEW WALL FINISHES.
12. PROVIDE ROOM ID AND GEOMETRIC SIGNS AT RESTROOMS 106, 107, 115 AND 116.

KEYNOTE LEGEND_RESTROOM _DEMO Key						
Value	Keynote Text					
02-01	REMOVE EXISTING HIGH AND LOW DRINKING FOUNTAIN					
02-02	REMOVE EXISTING WALL TILES INCLUDING SUBSTRATE AT DRINKING FOUNTAIN ALCOVE.					
02-03	REMOVE EXISTING WALL MOUNTED INTEGRAL SINK LAVATORY AND BASE COVER UNIT. AS REQUIRED FOR NEW WORK,					
02-04	REMOVE EXISTING WALL FINISHES TO STUD, INCLUDING 8" BAND OF TILE INSET, WHERE OCCURS ON ELEVATION. REMOVE AND SALVAGE EXISTING WALL MOUNTED RESTROOM ACCESSORIES FOR RE-INSTALLTION AFTER WALL FINISHES OCCUR.					
02-05	REMOVE EXISTING 30" GRAB BAR. REMOVE AND SALVAGE EXISTING ADJACENT 48" GRAB FOR RE-INSTALLATION AFTER NEW WALL FINISH OCCURS					
02-06	REMOVE EXISTING TOILET PARTITIONS					
02-07	REMOVE EXISTING SEMI-RECESSED BABY CHANGING STATION TO ACCESSIBLE COMPLIANT HEIGHT. INFILL WALL AND PATCH AND REPAIR.					
02-08	REMOVE AND SALVAGE THE EXISTING BUILT IN SOAP DISPENSER BETWEEN MIRRORS FOR RE-INSTALLATION AT COMPLIANT HEIGHT					
02-09	REMOVE EXISTING PAPER TOWEL DISPENSER AND RETURN TO OWNER					
02-22	REMOVE AND SALVAGE EXISTING MIRRORS FOR RE-INSTALLATION AT ADA HEIGHT. RE-INSTALL AT RESTROOMS 106, 107 & 115					
02-41	EXISTING WATER CLOSET, TO REMAIN (ADA WC 17"-19" FROM ADJACENT WALL),					
02-42	EXISTING URINAL, TO REMAIN					
02-43	REMOVE EXISTING FLOOR TILE TO SUBSTRATE AND PREP FOR NEW					
02-44	REMOVE EXISTING HANDDRYER . DISCONNECT. TERMINATE AND CAP EXISTING CIRCUIT AS REQUIRED.					
02-45	REMOVE AND SALVAGE EXISTING RESTROOM SIGNAGE FOR RE-INSTALLATION AT SIGNAGE COMPLIANT HEIGHT					
02-48	REMOVE EXISTING PLUMBING FIXTURE, SPD					
02-49	REMOVE EXISTING SINK BASE CABINET. CUT BACK EXISTING ADJACENT DRAWERS. FIELD VERIFY EXTENT OF REMOVAL.					
02-50	REMOVE EXISTING FLOOR, WALL, AND CARPET BASE FINISHES					
02-51	REMOVE AND SALVAGE EXISTING SOAP DISPENSER FOR REINSTALLATION					
02-56	REMOVE AND SALVAGE EXISTING TOILET SEAT PAPER DISPENSER, SANITARY NAPKIN DISPOSAL, AND TOILET PAPER DISPENSER FOR REINSTALLATION					
02-57	FIELD VERIFY EXISTING MIRROR TO +40' TO EDGE OF VISIBLE EDGE. REMOUNT TO COMPLIANT MOUNTING HEIGHT					
02-66	REMOVE EXISTING TOILET ROOM ACCESSORY - WALL MOUNTED OR RECESSED					
02-67	REMOVE AND SALVAGE EXISTING TOILET ROOM ACCESSORY FOR REINSTALLATION					



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PROJECT TITLE

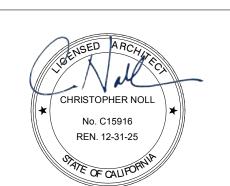100 FAIRGROUNDS DRIVE PETALUMA, CA 94952

SONOMA COUNTY

RENOVATION

PROJECT NO.

PETALUMA

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LIBRARY

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HEET TITLE

ENLARGED PLANS AND INTERIOR ELEVATIONS-RESTROOMS

SHEET NUMBER

A4.21



KEYNOTE LEGEND Key Value **Keynote Text** REMOVE EXISTING 30" GRAB BAR. REMOVE AND SALVAGE EXISTING ADJACENT 48" GRAB FOR RE-INSTALLATION AFTER NEW WALL FINISH OCCURS COMPUTER COUNTERTOP WITH LINOLEUM TOP AND HARDWOOD TRIM,, 24" DEEP, WITH INTERMEDIATE VERTICAL DIVIDERS PROVIDE QUARTZ SURFACE COUNTERTOP WITH UNDERMOUNT SINKS - SEE DET 3/A4.21 PROVIDE SMOOTH NONABSORBENT SURFACES (CERAMIC TILE) TO 6'-0" AFF, ON ALL ELEVATIONS OF THE RESTROOMS. TYP. GYP BD WALL ABOVE TILE TO BE PREPPED AND PAINTED, TYP. SEE FINISH SCHEDULE. PROVIDE WALL INFILL AT EXISTING BOOK SHELVING NICHE PRIOR TO CERAMIC TILE FINISH PROVIDE 36" REAR LONG GRAB BAR. ADJUST BLOCKING AS REQUIRED. RE-INSTALL EXISTING ADJACENT 48" GRAB BAR IN PROVIDE FLOOR TO CEILING BRACED TOILET PARTITIONS AND URINAL SCREEN. COORDINATE TO MATCH EXISTING CEILING PROVIDE SOAP DISPENSER RE-INSTALL (E) MIRROR IN NEW LOCATION. REINSTALL (E) ACCESSORIES (SOAP DISPENSER, PAPER TOWEL DISPENSER, TOILET PAPER DISPENSER, TOILET SEAT COVER DISPENSER, ETC.). UON. PROVIDE RECESSED PAPER TOWEL DISPENSER AND WASTE RECEPTACLE. PROVIDE HORIZONTAL WALL MOUNTED STAINLESS STEEL BABY CHANGING STATION - 4" MAX PROTRUSION. PROVIDE FLOOR TO CEILING BRACED TOILET PARTITIONS, EXTENDED HEIGHT,. FULL PRIVACY WITH 1" FLOOR CLEARANCE -GAP FREE DOORS AND STILES PROVIDE FRAMED MIRROR, LENGTH SIZED TO FIT LOCATION AT MULTIPLE LAVATORY. PROVIDE 18"x30" AT SINGLE LAVATORY. RE-INSTALL EXISTING SOAP DISPENSER, WHERE AVAILABLE, FROM EXISTING LOCATIONS. PROVIDE NEW AS REQUIRED PROVIDE TOILET PAPER DISPENSER PROVIDE 36" REAR AND 48" SIDE GRAB BAR. PROVIDE TOILET SEAT PAPER DISPENSER AND SANITARY NAPKIN RE-INSTALL EXISTING TOILET SEAT PAPER DISPENSER, SANITARY NAPKIN DISPOSAL, AND TOILET PAPER DISPENSER ADJUST PLUMBING AS REQUIRED FOR ACCESSIBLE COMPLIANT SINK. SPD PROVIDE WATER CLOSET. ADJUST PLUMBING AS REQUIRED FOR ACCESSIBLE WATER CLOSET. SPD PROVIDE WALL MOUNTED SINK. SPD PROVIDE UNDERMOUNT SINK AT QUARTZ SURFACE COUNTERTOP

WALL MOUNTED LIGHT FIXTURE, SED

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CHRISTOPHER NOLL

No. C15916

REN. 12-31-25

OF CALLY

PROJECT TITLE

SONOMA COUNTY
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PROJECT NO.
10-19

100 FAIRGROUNDS DRIVE PETALUMA, CA 94952

PERMIT SET

ISSUE DATE 11/20/
N&T JOB NUMBER 2
REVISIONS
DATE DESCRIPTION

1 1/22/2024 RESUBMITTAL

REVIEWED FOR CODE COMPLIANCE


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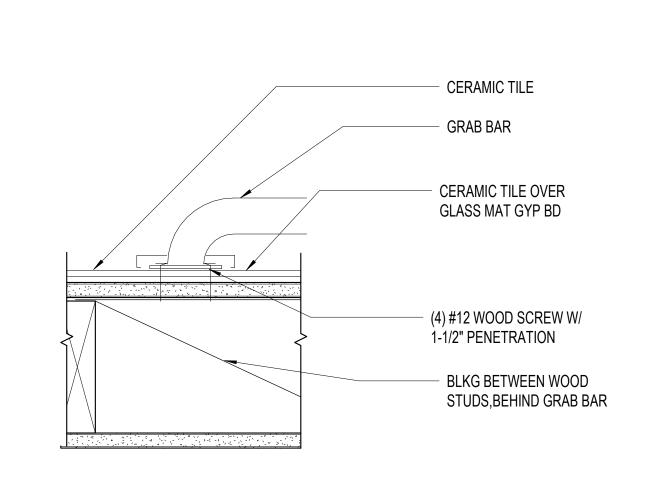
RESTROOM - INTERIOR ELEVATIONS AND DETAILS

SHEET NUMBER


A4.22


APPROVALS



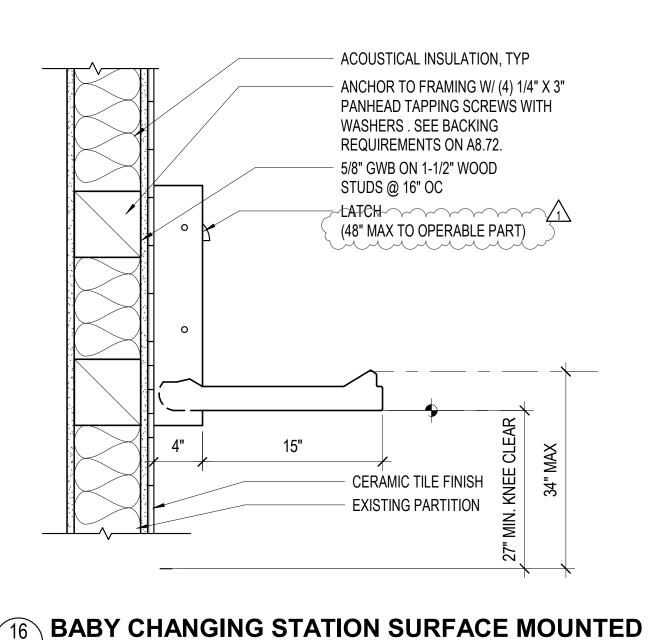

GRAB BAR BACKING

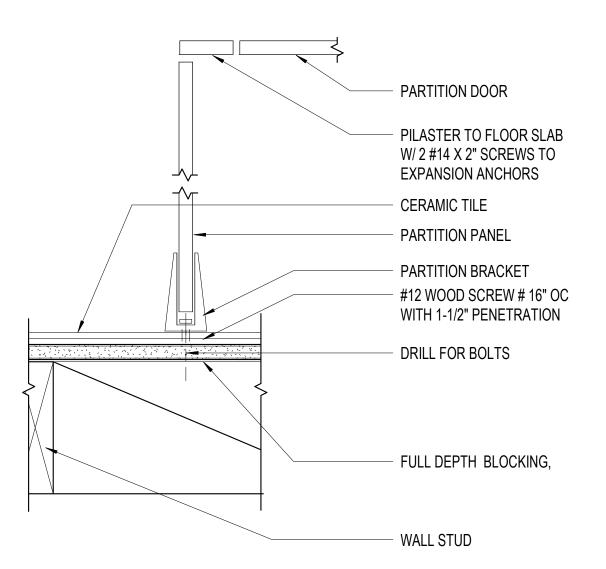

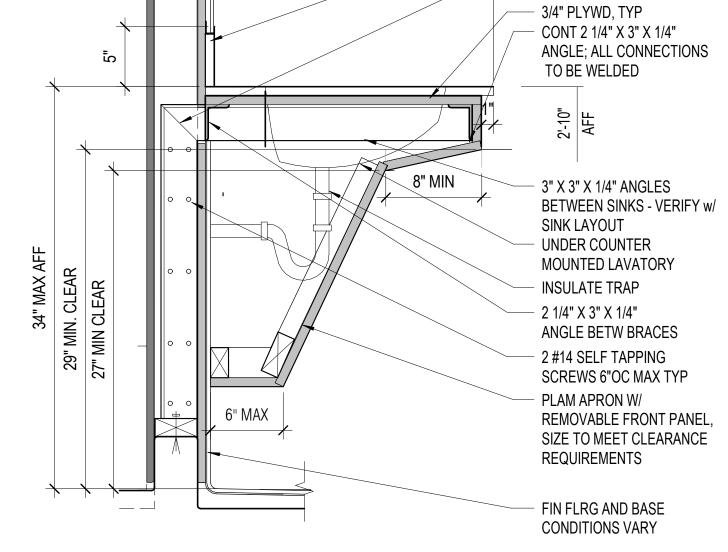

2' - 0"

MIRROR W/ SUPPORT

BACKSPLASH
SCRIBE AND SEAL
MITER AND WELD
CORNER TYP

4 TOILET PARTITION ANCHOR
3" = 1'-0"


3 LAVATORY COUNTER SECTION 1 1/2" = 1'-0"



1 ENTRY - E
A5.11 1/4" = 1'-0"

3 ENTRY - N
A5.11 1/4" = 1'-0"

2 **ENTRY - W**A5.11 1/4" = 1'-0"

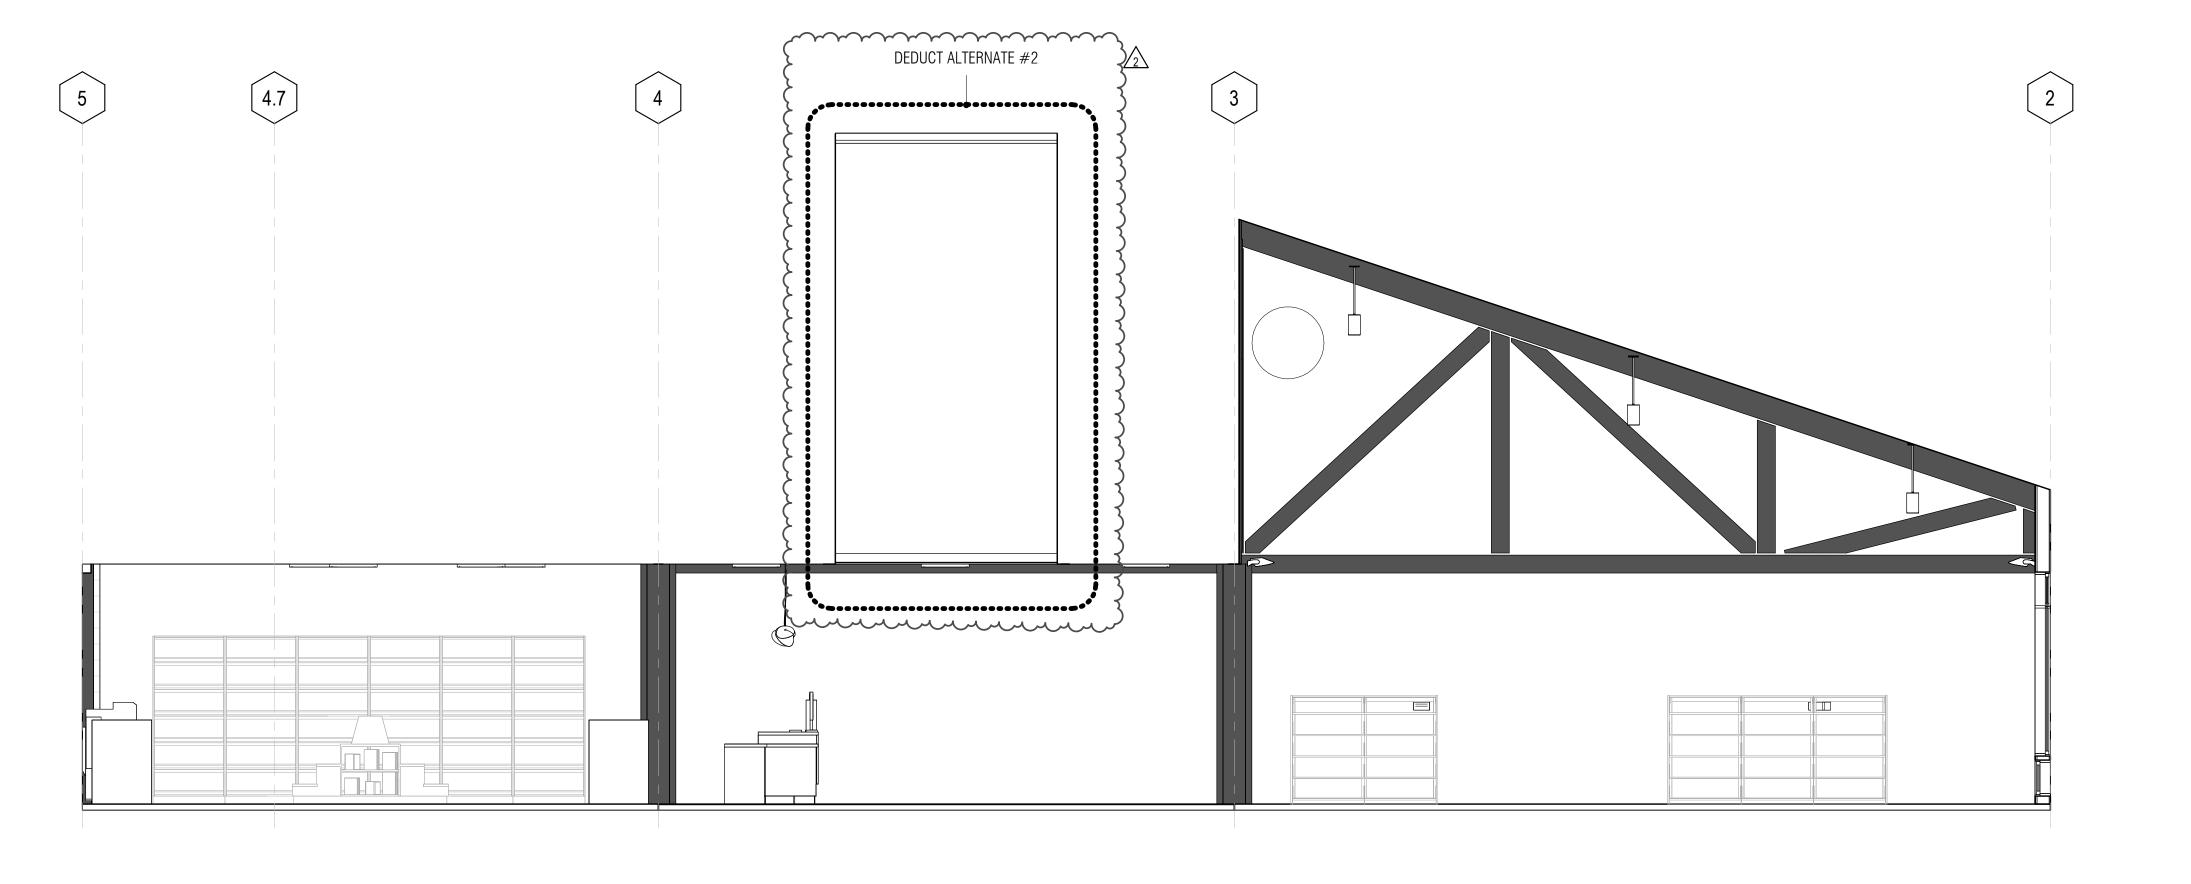

GENERAL NOTES


1. REFER TO INTERIOR FINISH SCHEDULE, A2.41, AND A9.11 FOR FLOOR, WALL AND CEILING FINISHES
2. REFER TO ELECTRICAL AND TECHNOLOGY FOR MORE INFORMATION AND LOCATIONS OF SWITCHES, RECEPTACLES, AND DATA OUTLETS. COORDINATE ROUTING OF EXPOSED RACEWAYS (WHERE OCCURS) AND FINAL LOCATIONS OF DEVICES WITH ARCHITECT AND LIBRARY PRIOR TO INSTALLATION. ALIGN DEVICES, WHENEVER POSSIBLE, WITH ADJACENT DEVICES. NOTIFY ARCHITECT OF ANY CONFLICT AND FOR ANY CLARIFICATIONS OF LOCATION PRIOR TO INSTALLATION.

	KEYNOTE LEGEND				
Key Value	Keynote Text				
09-01	PROVIDE CERAMIC TILE FINISH AT ALCOVE WALLS				
09-13	PAINT EXISTING GYP BD SURFACES & CEILINGS GYP BD- WHERE OCCURS				
10-04	PROVIDE MOTORIZED SECURITY ROLL-UP GRILLE WITH KEYSWITCH ON BUTTON - SSD FOR EXTENT OF STRUCTURAL WORK FOR GUIDE RAIL MOUNTING. SALVAGE AND RE-INSTALL WALL T&G SIDING FINISHES IN KIND AS AFFECTED BY NEW WORK. PROVIDE NEW MATCHING IN KIND.				

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ISSUE DATE

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REVISIONS

DATE DESCRIPTION

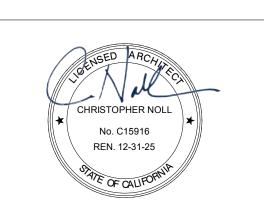2 4/25/2024 RESUBMITTAL 2



SHEET TITLE

INTERIOR ELEVATIONS - ENTRY


SHEET NUMBER

A5.11

APPROVALS

A 1997/2004 44:44:08 ANA A Litade Decelling Lineary Defendation

4 ENTRY - S
A5.11 1/4" = 1'-0"

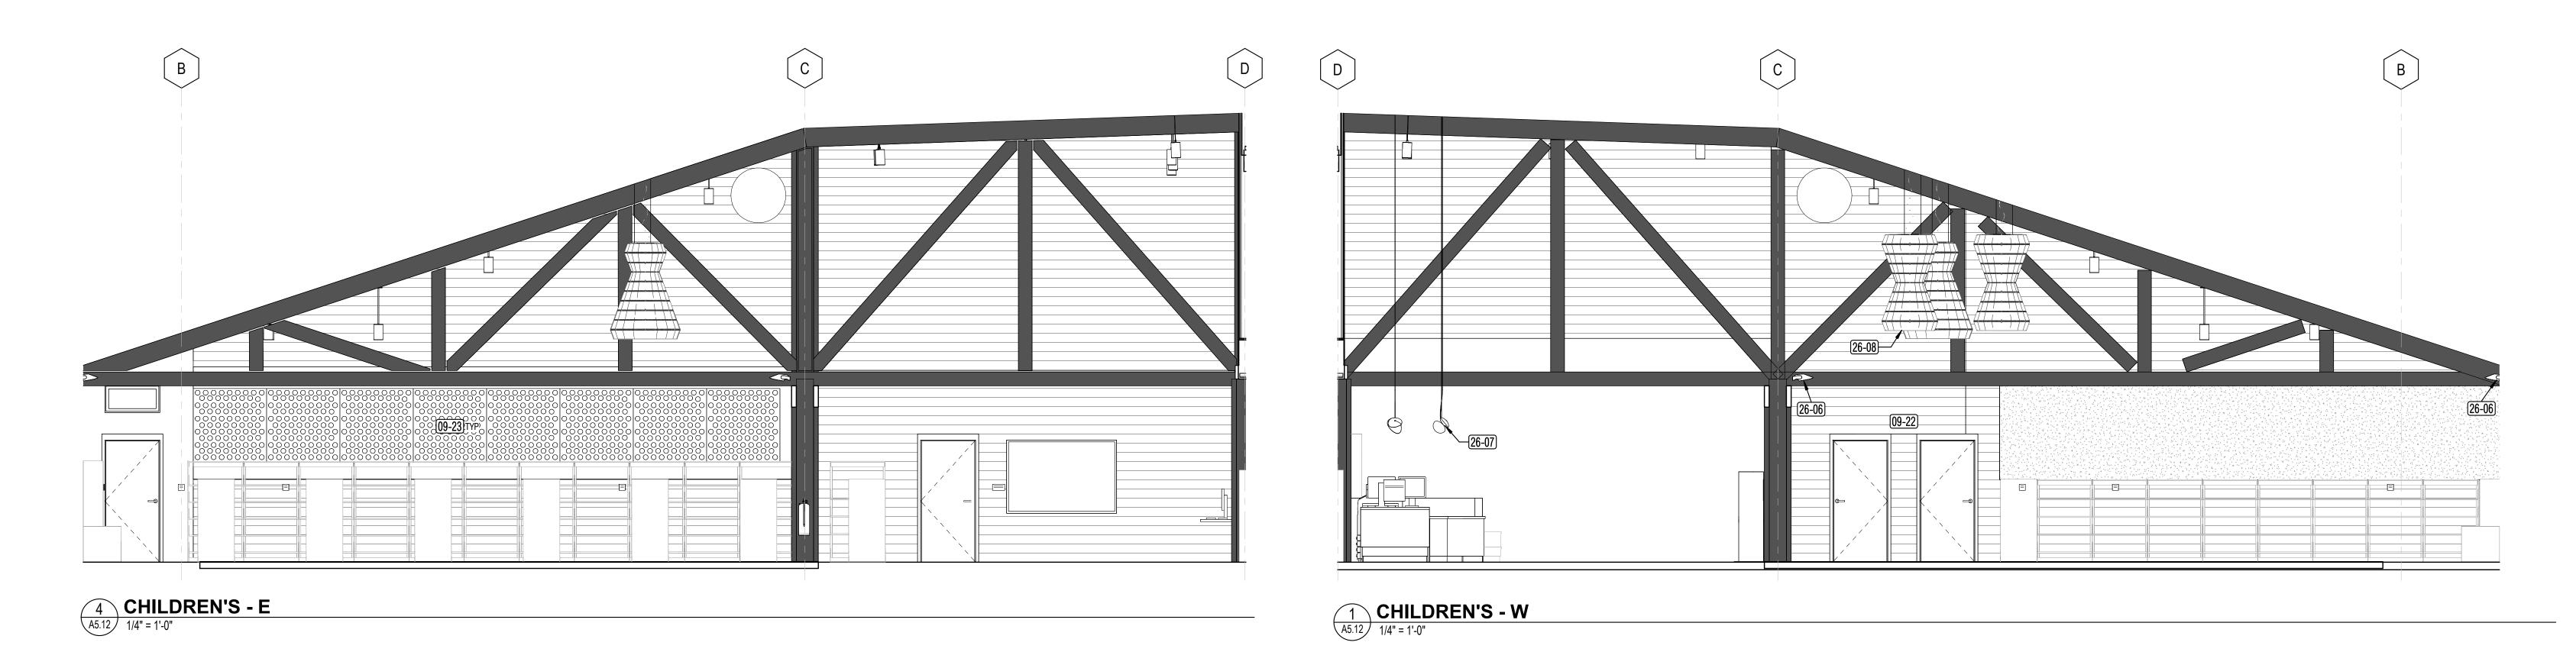

GENERAL NOTES 1. REFER TO INTERIOR FINISH SCHEDULE, A2.41, AND A9.11 FOR FLOOR, WALL AND CEILING FINISHES
2. REFER TO ELECTRICAL AND TECHNOLOGY FOR MORE INFORMATION AND LOCATIONS OF SWITCHES, RECEPTACLES, AND DATA OUTLETS. COORDINATE ROUTING OF EXPOSED RACEWAYS (WHERE OCCURS) AND FINAL LOCATIONS OF DEVICES WITH ARCHITECT AND LIBRARY PRIOR TO INSTALLATION. ALIGN DEVICES, WHENEVER POSSIBLE, WITH ADJACENT DEVICES. NOTIFY ARCHITECT OF ANY CONFLICT AND FOR ANY CLARIFICATIONS OF LOCATION PRIOR TO

	KEYNOTE LEGEND
Key Value	Keynote Text
09-09	PROVIDE WALL MOUNTED 2" THK ACOUSTICAL PANELS, EXTRUDED POLYESTER, FROM TOP OF (E)BEAM TO UNDERSIDE OF (E) T&G CEILING.
09-13	PAINT EXISTING GYP BD SURFACES & CEILINGS GYP BD- WHERE OCCURS
09-22	PROVIDE WALL INFILL WITH 3/8" X 8" WOOD SIDING, MATCH EXISTING ADJACENT IN KIND.
09-23	PROVIDE WALL MOUNTED WOOD GRAIN CONTOUR (3D LAMINATE) PANEL
26-06	SURFACE MOUNT UPLIGHT FIXTURE, SED
26-07	PENDANT LIGHT FIXTURE, SED
26-08	LARGE SCALE PENDANT LIGHT FIXTURE, SED

PROJECT TITLE

SONOMA COUNTY PETALUMA REGIONAL LIBRARY RENOVATION PROJECT NO.

100 FAIRGROUNDS DRIVE PETALUMA, CA 94952


PERMIT SET

ISSUE DATE N&T JOB NUMBER REVISIONS DATE DESCRIPTION


> REVIEWED FOR CODE COMPLIANCE 05/03/2024 Shums Coda Associates


INTERIOR ELEVATIONS -

A5.12

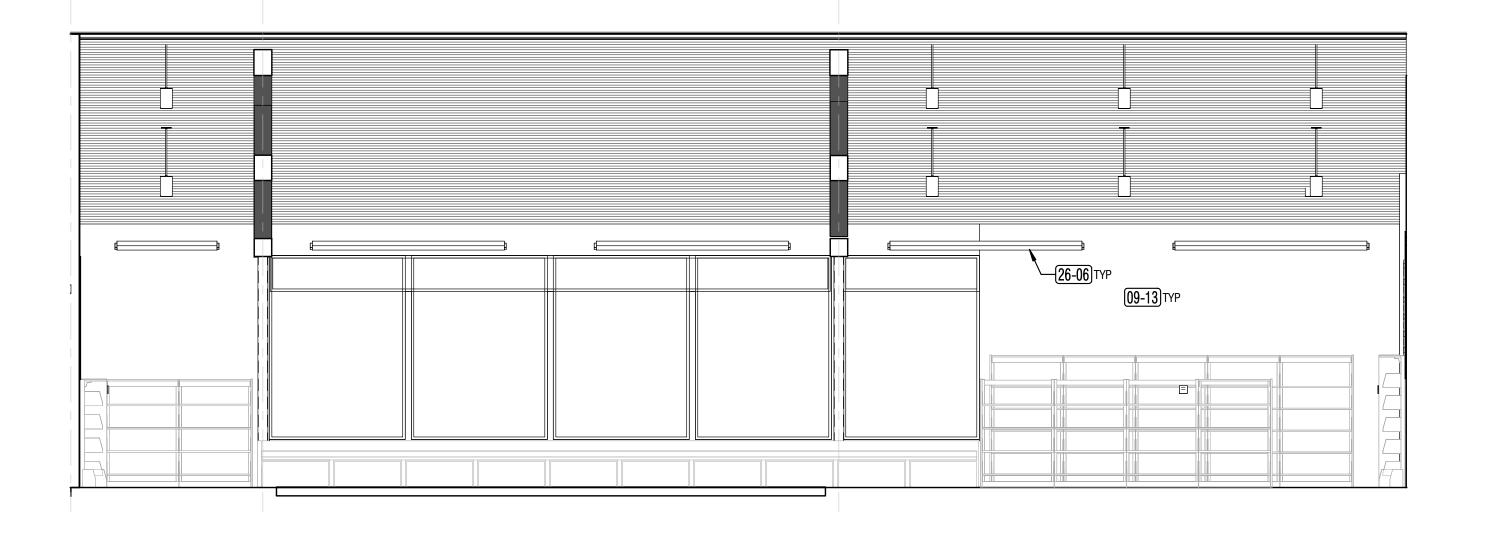


5 **CHILDREN'S - N**A5.12 1/4" = 1'-0"

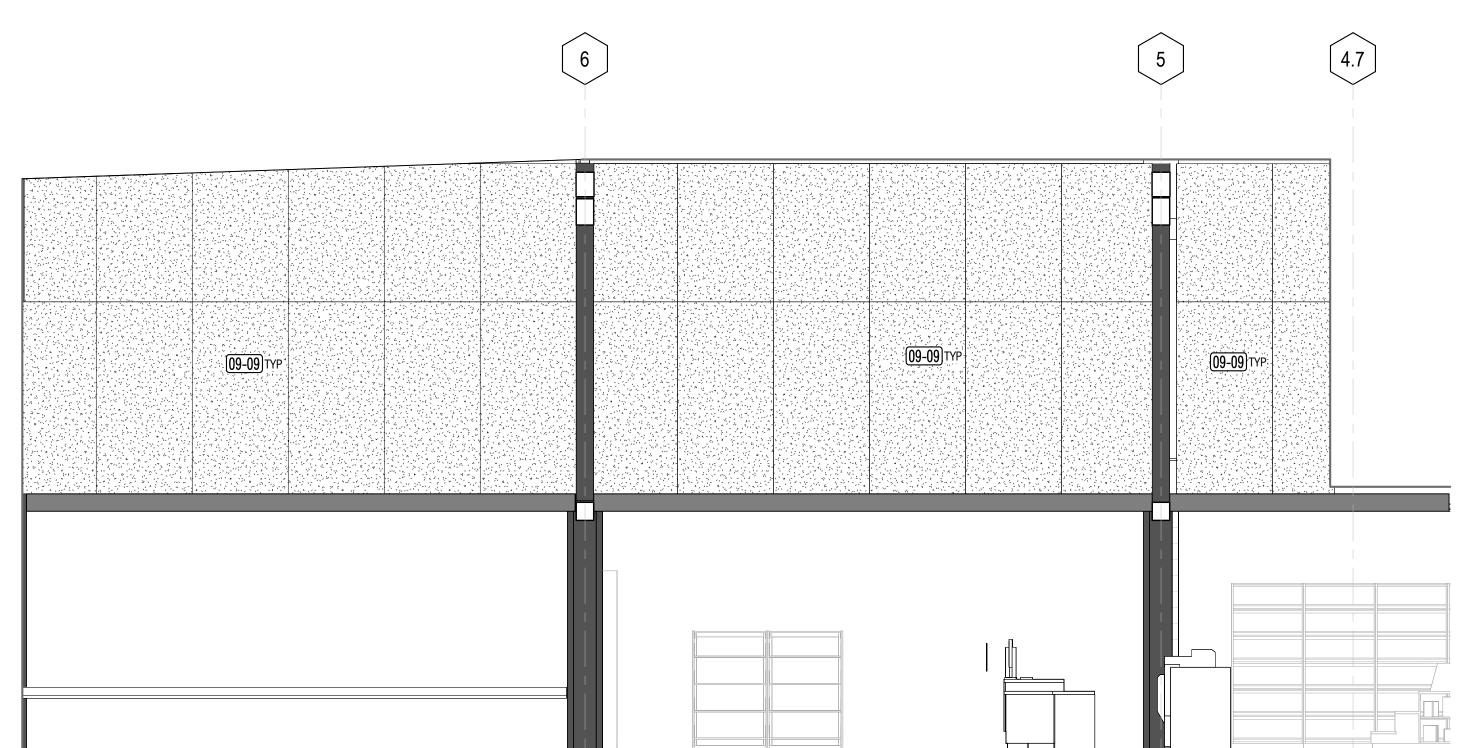

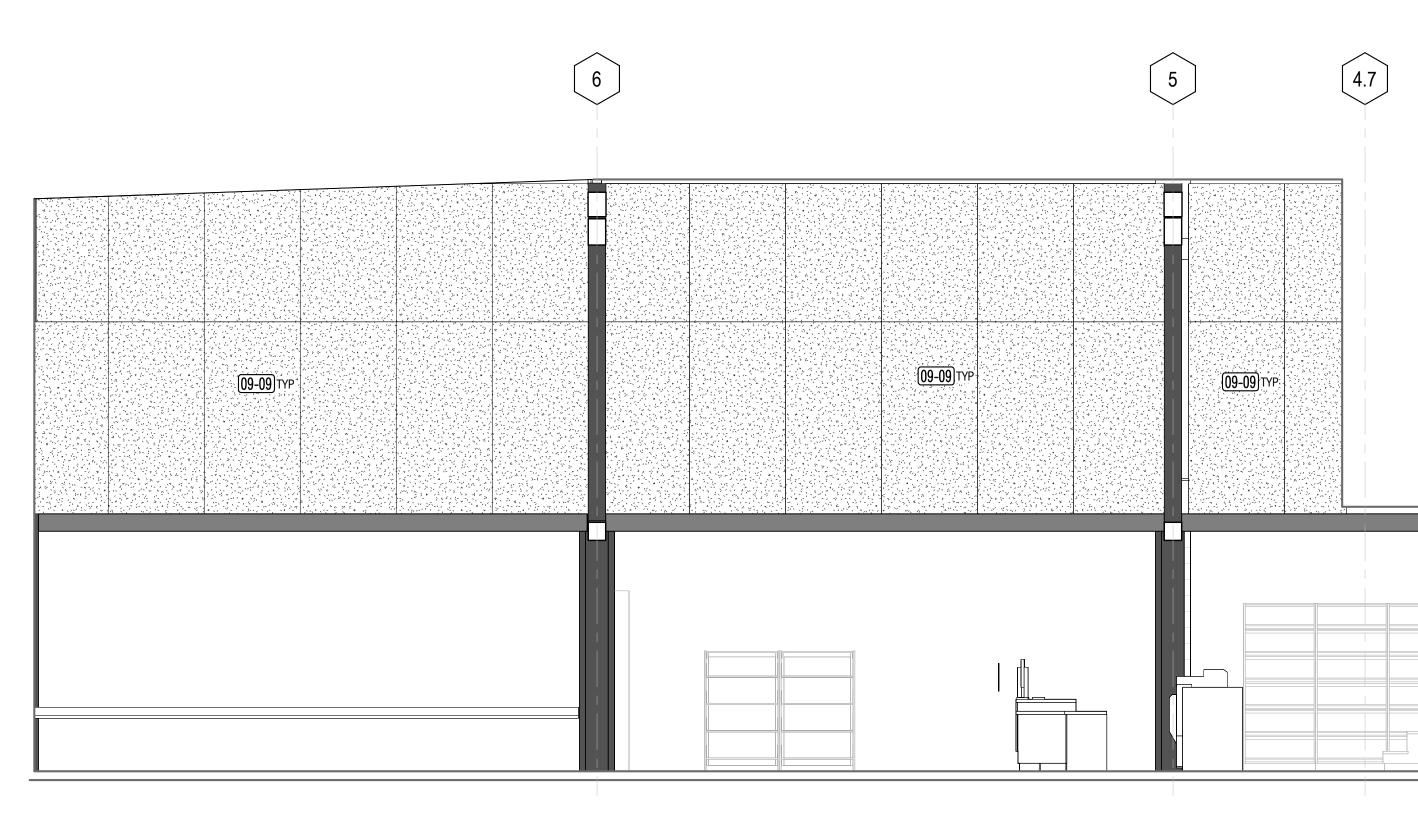


ARCHITECTS


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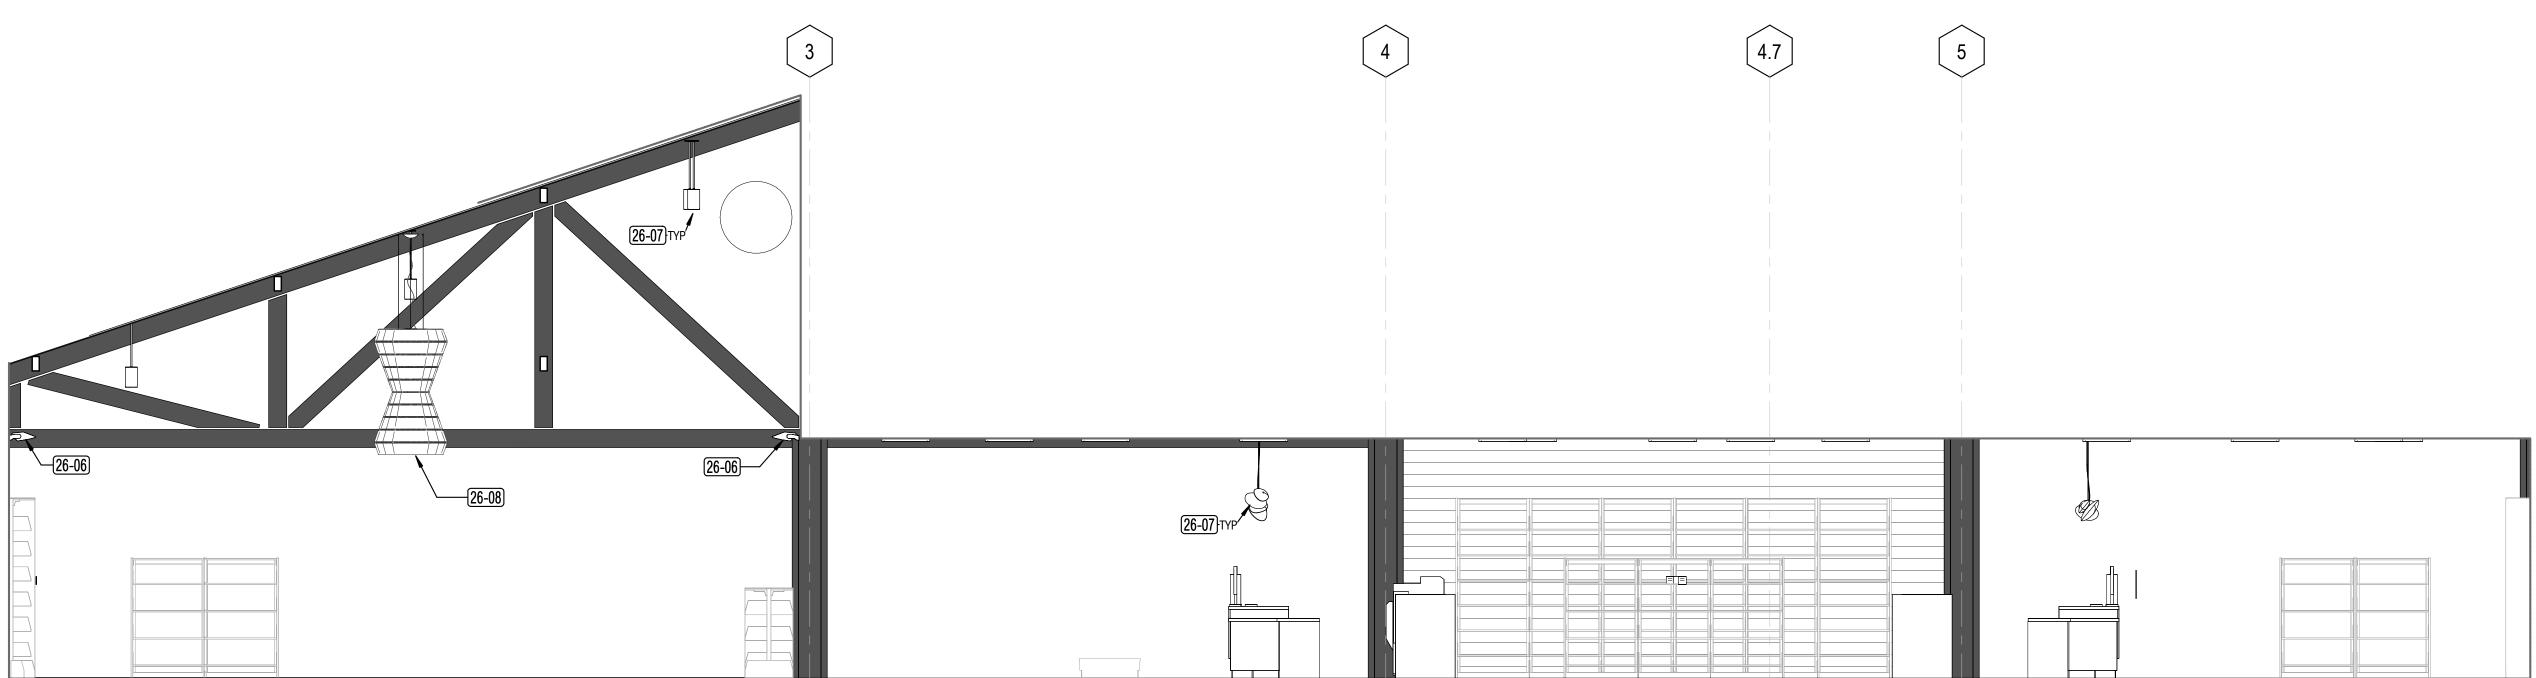
CHILDREN'S AREA

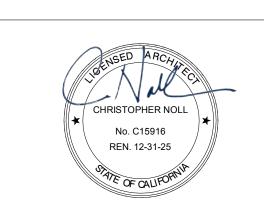
SHEET NUMBER




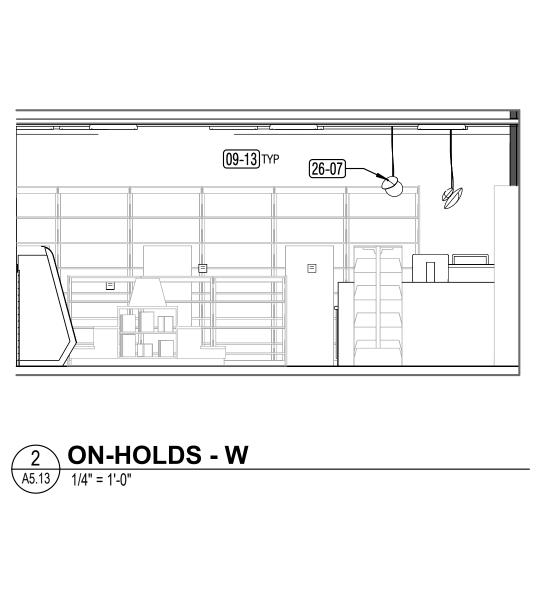



1 ON-HOLDS - E
A5.13 1/4" = 1'-0"

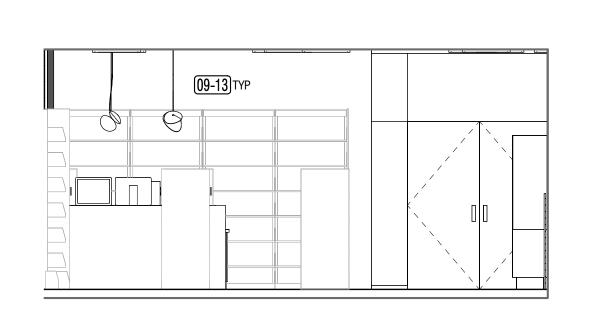


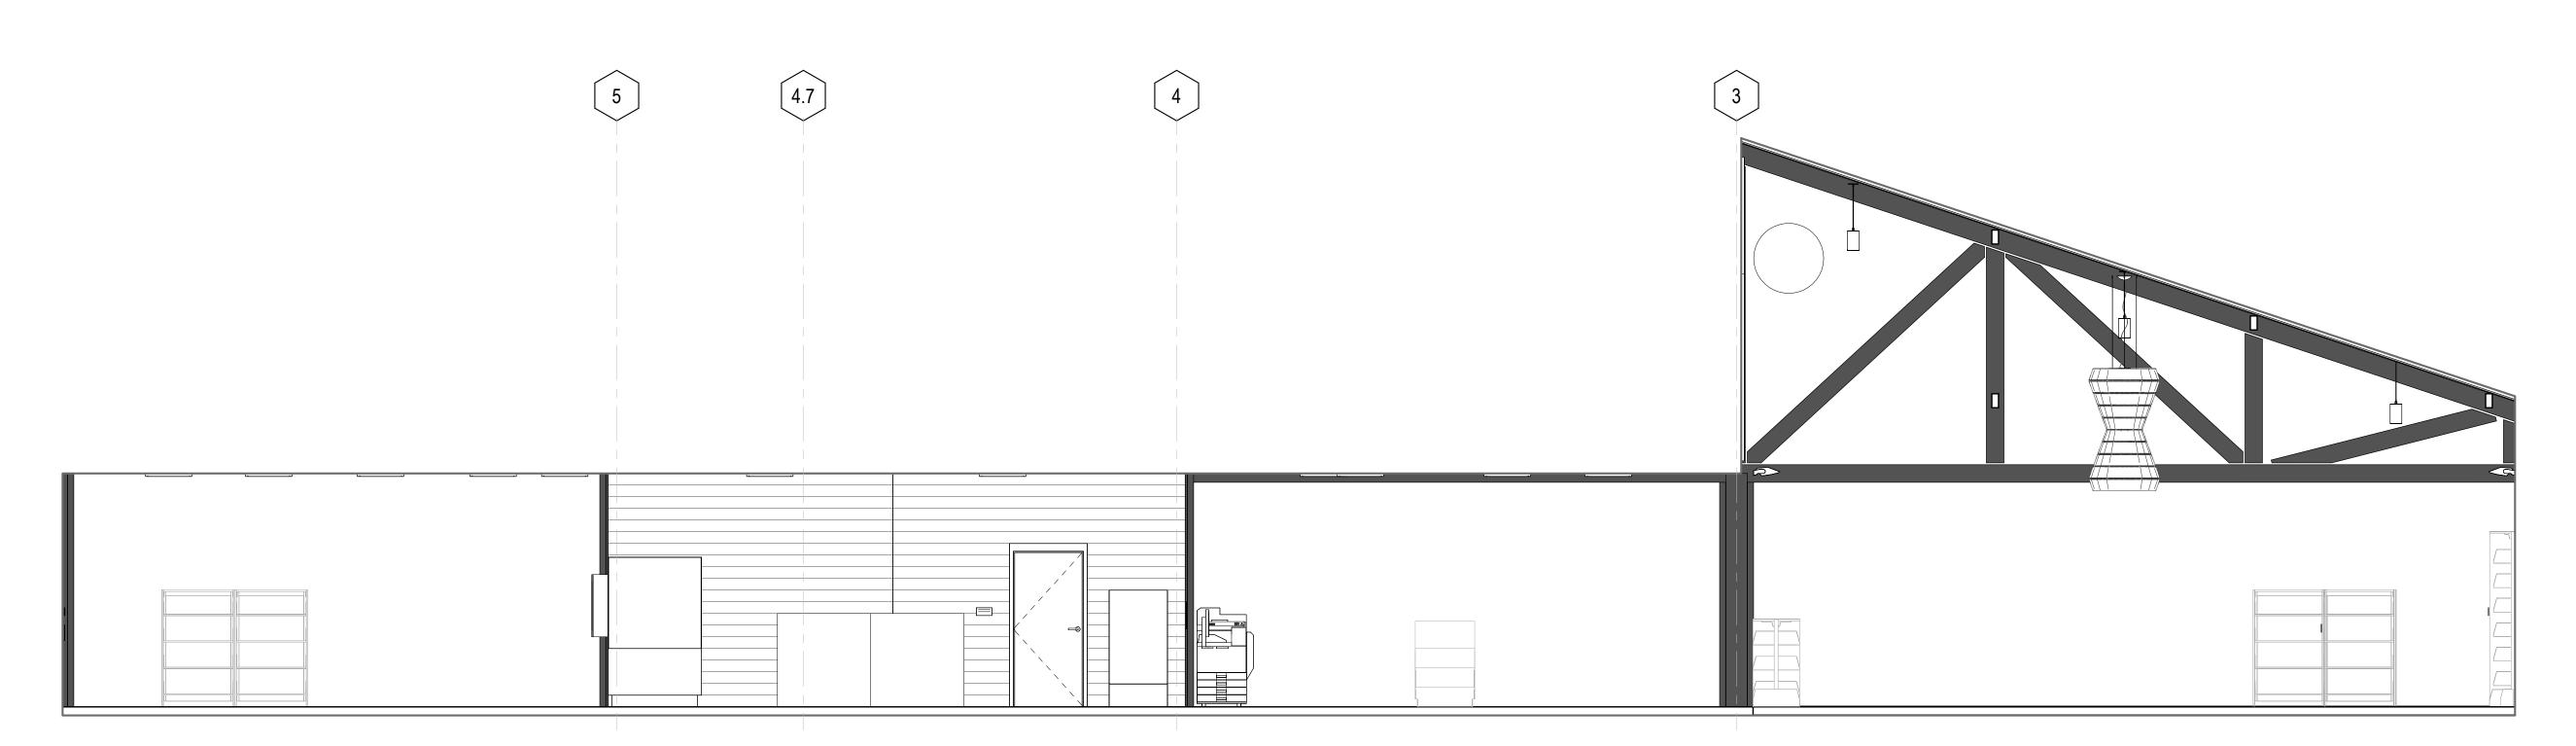

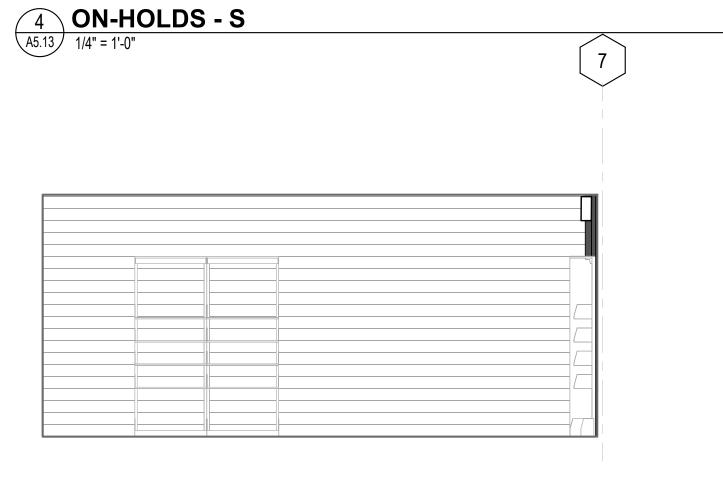

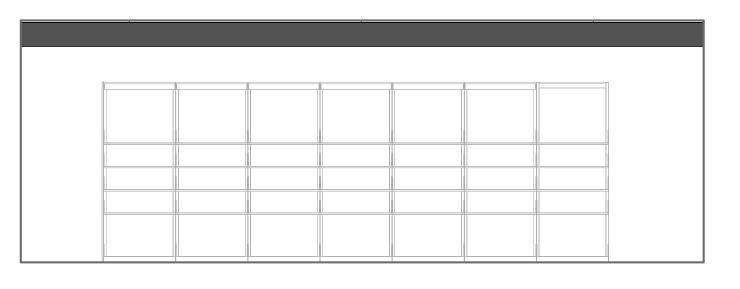

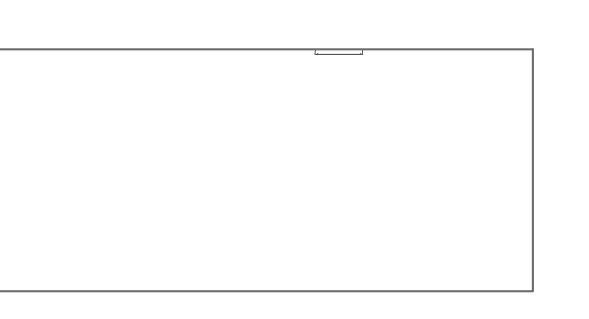

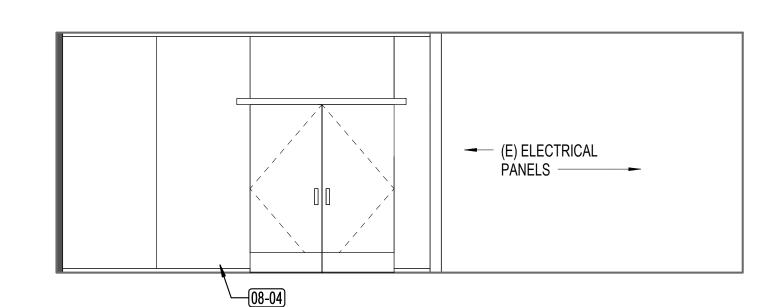

5 PETALUMA HISTORY RM - W

A5.13 1/4" = 1'-0"

8 PETALUMA HISTORY RM - N
A5.13 1/4" = 1'-0"

3 **ON-HOLDS - N**A5.13 1/4" = 1'-0"

6 PETALUMA HISTORY RM - E
A5.13 NOT TO SCALE





GENERAL NOTES

1. REFER TO INTERIOR FINISH SCHEDULE, A2.41, AND A9.11 FOR FLOOR, WALL AND CEILING FINISHES
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KEYNOTE LEGEND				
Key Value	Keynote Text			
08-04	PROVIDE FRAMELESS GLAZED SYSTEM WITH DOUBLE DOORS			
09-13	PAINT EXISTING GYP BD SURFACES & CEILINGS GYP BD- WHERE OCCURS			
26-06	SURFACE MOUNT UPLIGHT FIXTURE, SED			
26-07	PENDANT LIGHT FIXTURE, SED			
26-08	LARGE SCALE PENDANT LIGHT FIXTURE, SED			

NOLL & TAM ARCHITECTS

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CHRISTOPHER NOLL

No. C15916

REN. 12-31-25

PROJECT TITLE

PETALUMA
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10-19

100 FAIRGROUNDS DRIVE PETALUMA, CA 94952

PERMIT SET

ISSUE DATE

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DATE DESCRIPTION

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05/03/2024

Shums Coda Associates

SHEET TITLE


INTERIOR ELEVATIONS -ON HOLDS, HISTORY ROOM

SHEET NUMBER

A5.13


APPROVALS

OVALS

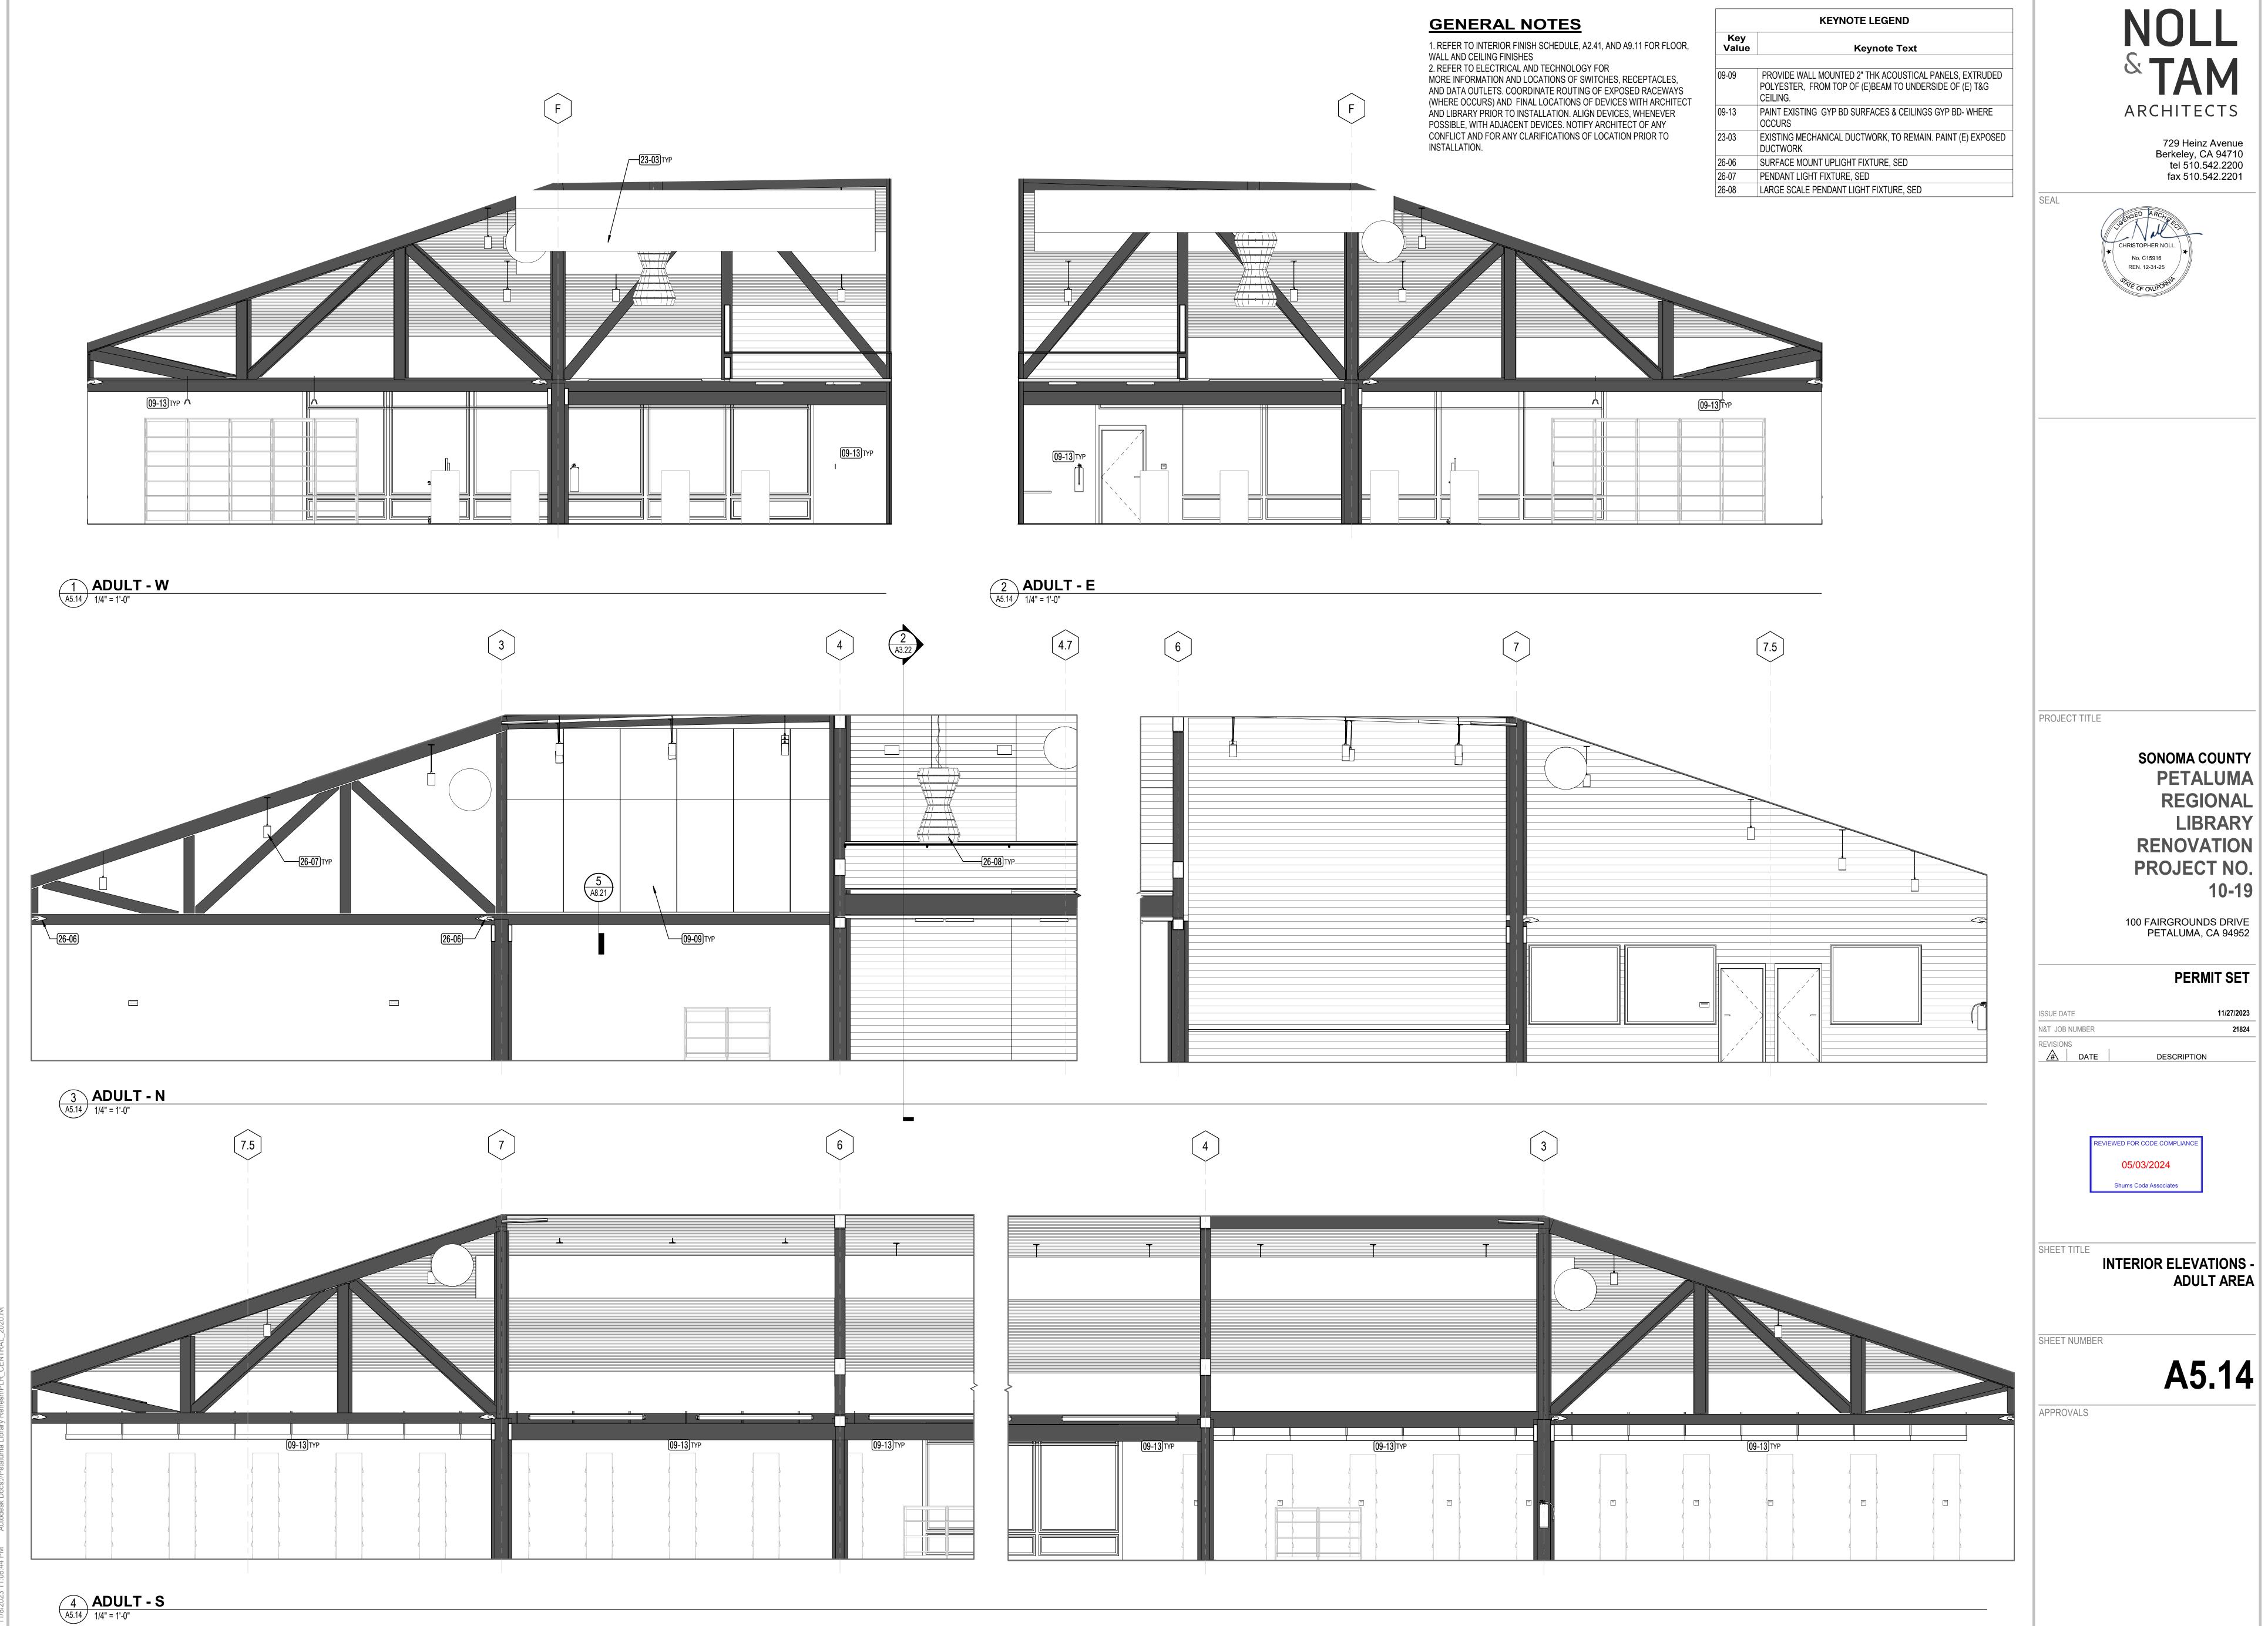


PETALUMA REGIONAL LIBRARY RENOVATION PROJECT NO.

ADULT AREA

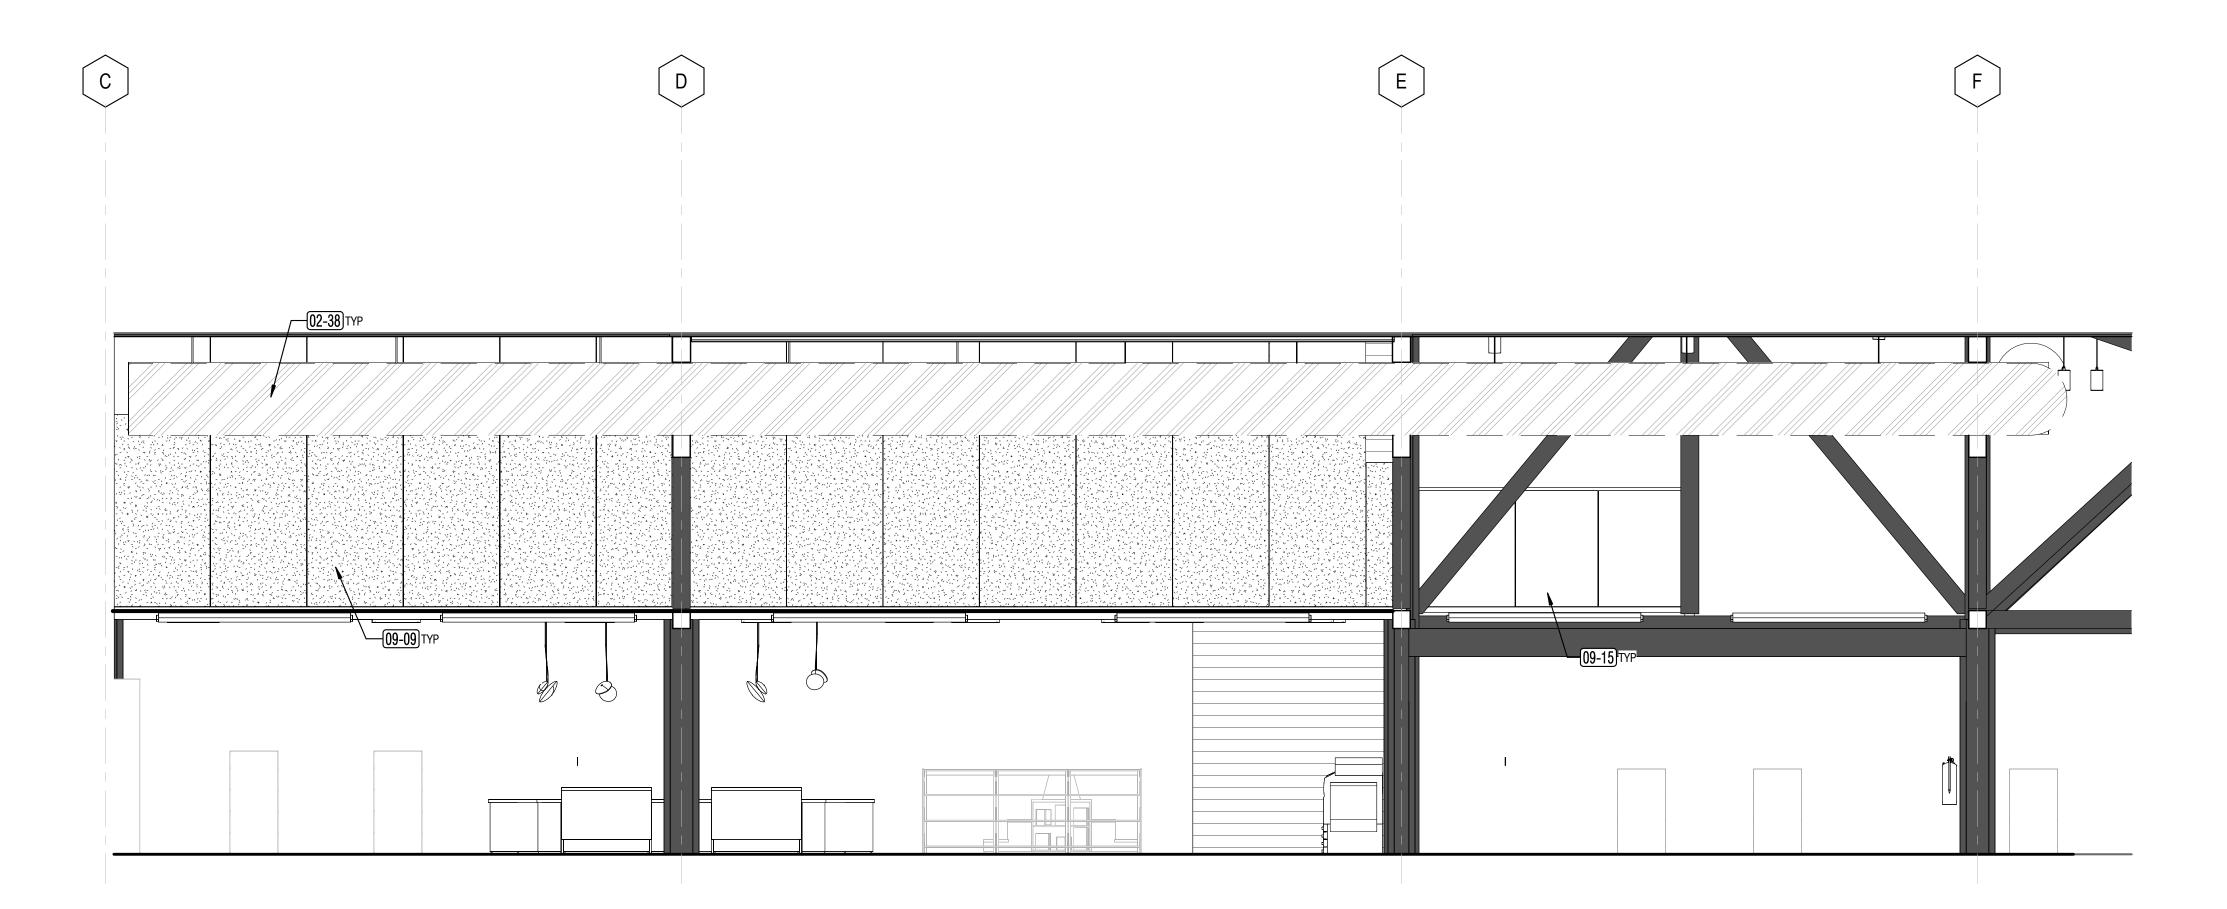

1 TEEN-ADULT_TOWARDS SERVICE DESK A5.15 1/4" = 1'-0"

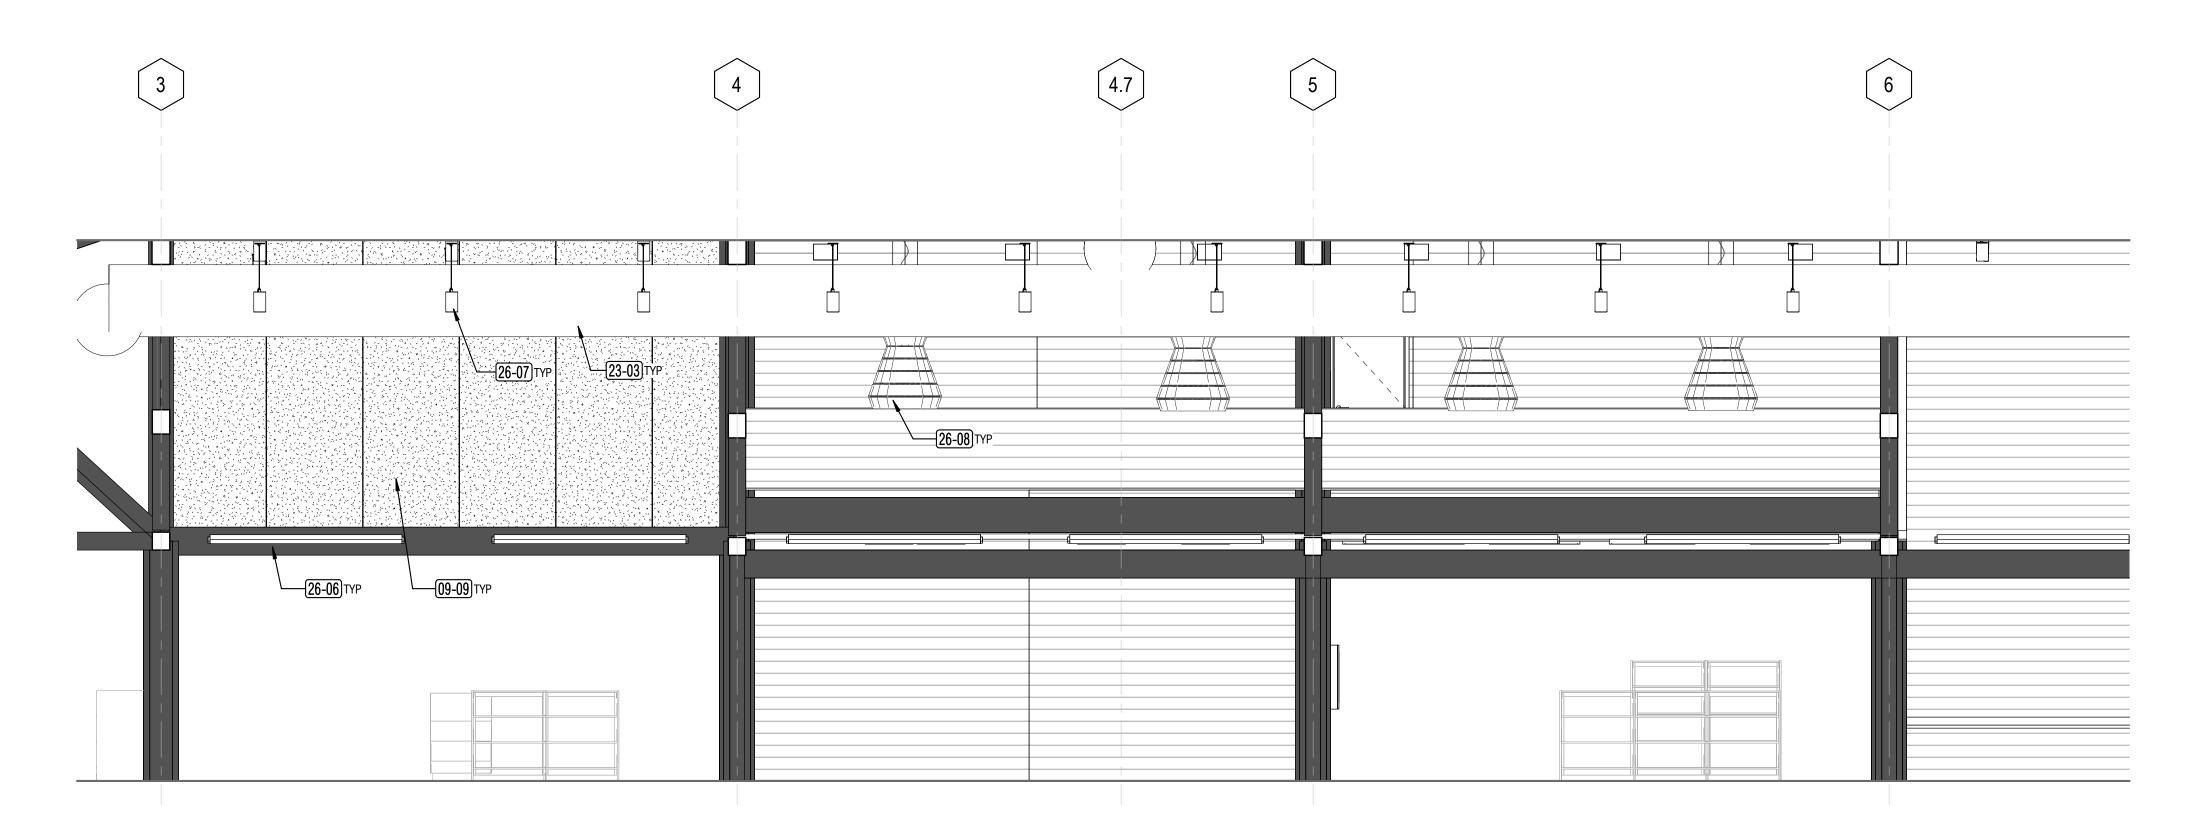

2 ADULT AREA - TOWARDS MEZZANINE

A5.15 1/4" = 1'-0"

GENERAL NOTES


1. REFER TO INTERIOR FINISH SCHEDULE, A2.41, AND A9.11 FOR FLOOR, WALL AND CEILING FINISHES
2. REFER TO ELECTRICAL AND TECHNOLOGY FOR MORE INFORMATION AND LOCATIONS OF SWITCHES, RECEPTACLES, AND DATA OUTLETS. COORDINATE ROUTING OF EXPOSED RACEWAYS (WHERE OCCURS) AND FINAL LOCATIONS OF DEVICES WITH ARCHITECT AND LIBRARY PRIOR TO INSTALLATION. ALIGN DEVICES, WHENEVER POSSIBLE, WITH ADJACENT DEVICES. NOTIFY ARCHITECT OF ANY CONFLICT AND FOR ANY CLARIFICATIONS OF LOCATION PRIOR TO INSTALLATION.

	KEYNOTE LEGEND					
Key Value	Keynote Text					
02-38	EXISTING MECHANICAL DUCTWORK, TO REMAIN					
09-09	PROVIDE WALL MOUNTED 2" THK ACOUSTICAL PANELS, EXTRUDED POLYESTER, FROM TOP OF (E)BEAM TO UNDERSIDE OF (E) T&G CEILING.					
09-15	AT MEZZANINE, PROVIDE WALL MOUNTED 2" THK ACOUSTICAL PANELS, EXTRUDED POLYESTER, FROM TOP OF BEAM TO TOP OF GUARDRAIL ONLY.					
23-03	EXISTING MECHANICAL DUCTWORK, TO REMAIN. PAINT (E) EXPOSED DUCTWORK					
26-06	SURFACE MOUNT UPLIGHT FIXTURE, SED					
26-07	PENDANT LIGHT FIXTURE, SED					
26-08	LARGE SCALE PENDANT LIGHT FIXTURE, SED					

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AL



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DATE

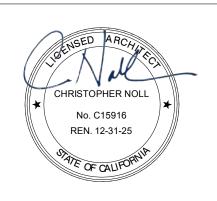DESCRIPTION





SHEET TITI

INTERIOR ELEVATIONS -TEEN, ADULT, & MEETING ROOM


SHEET NUMBER


A5.15

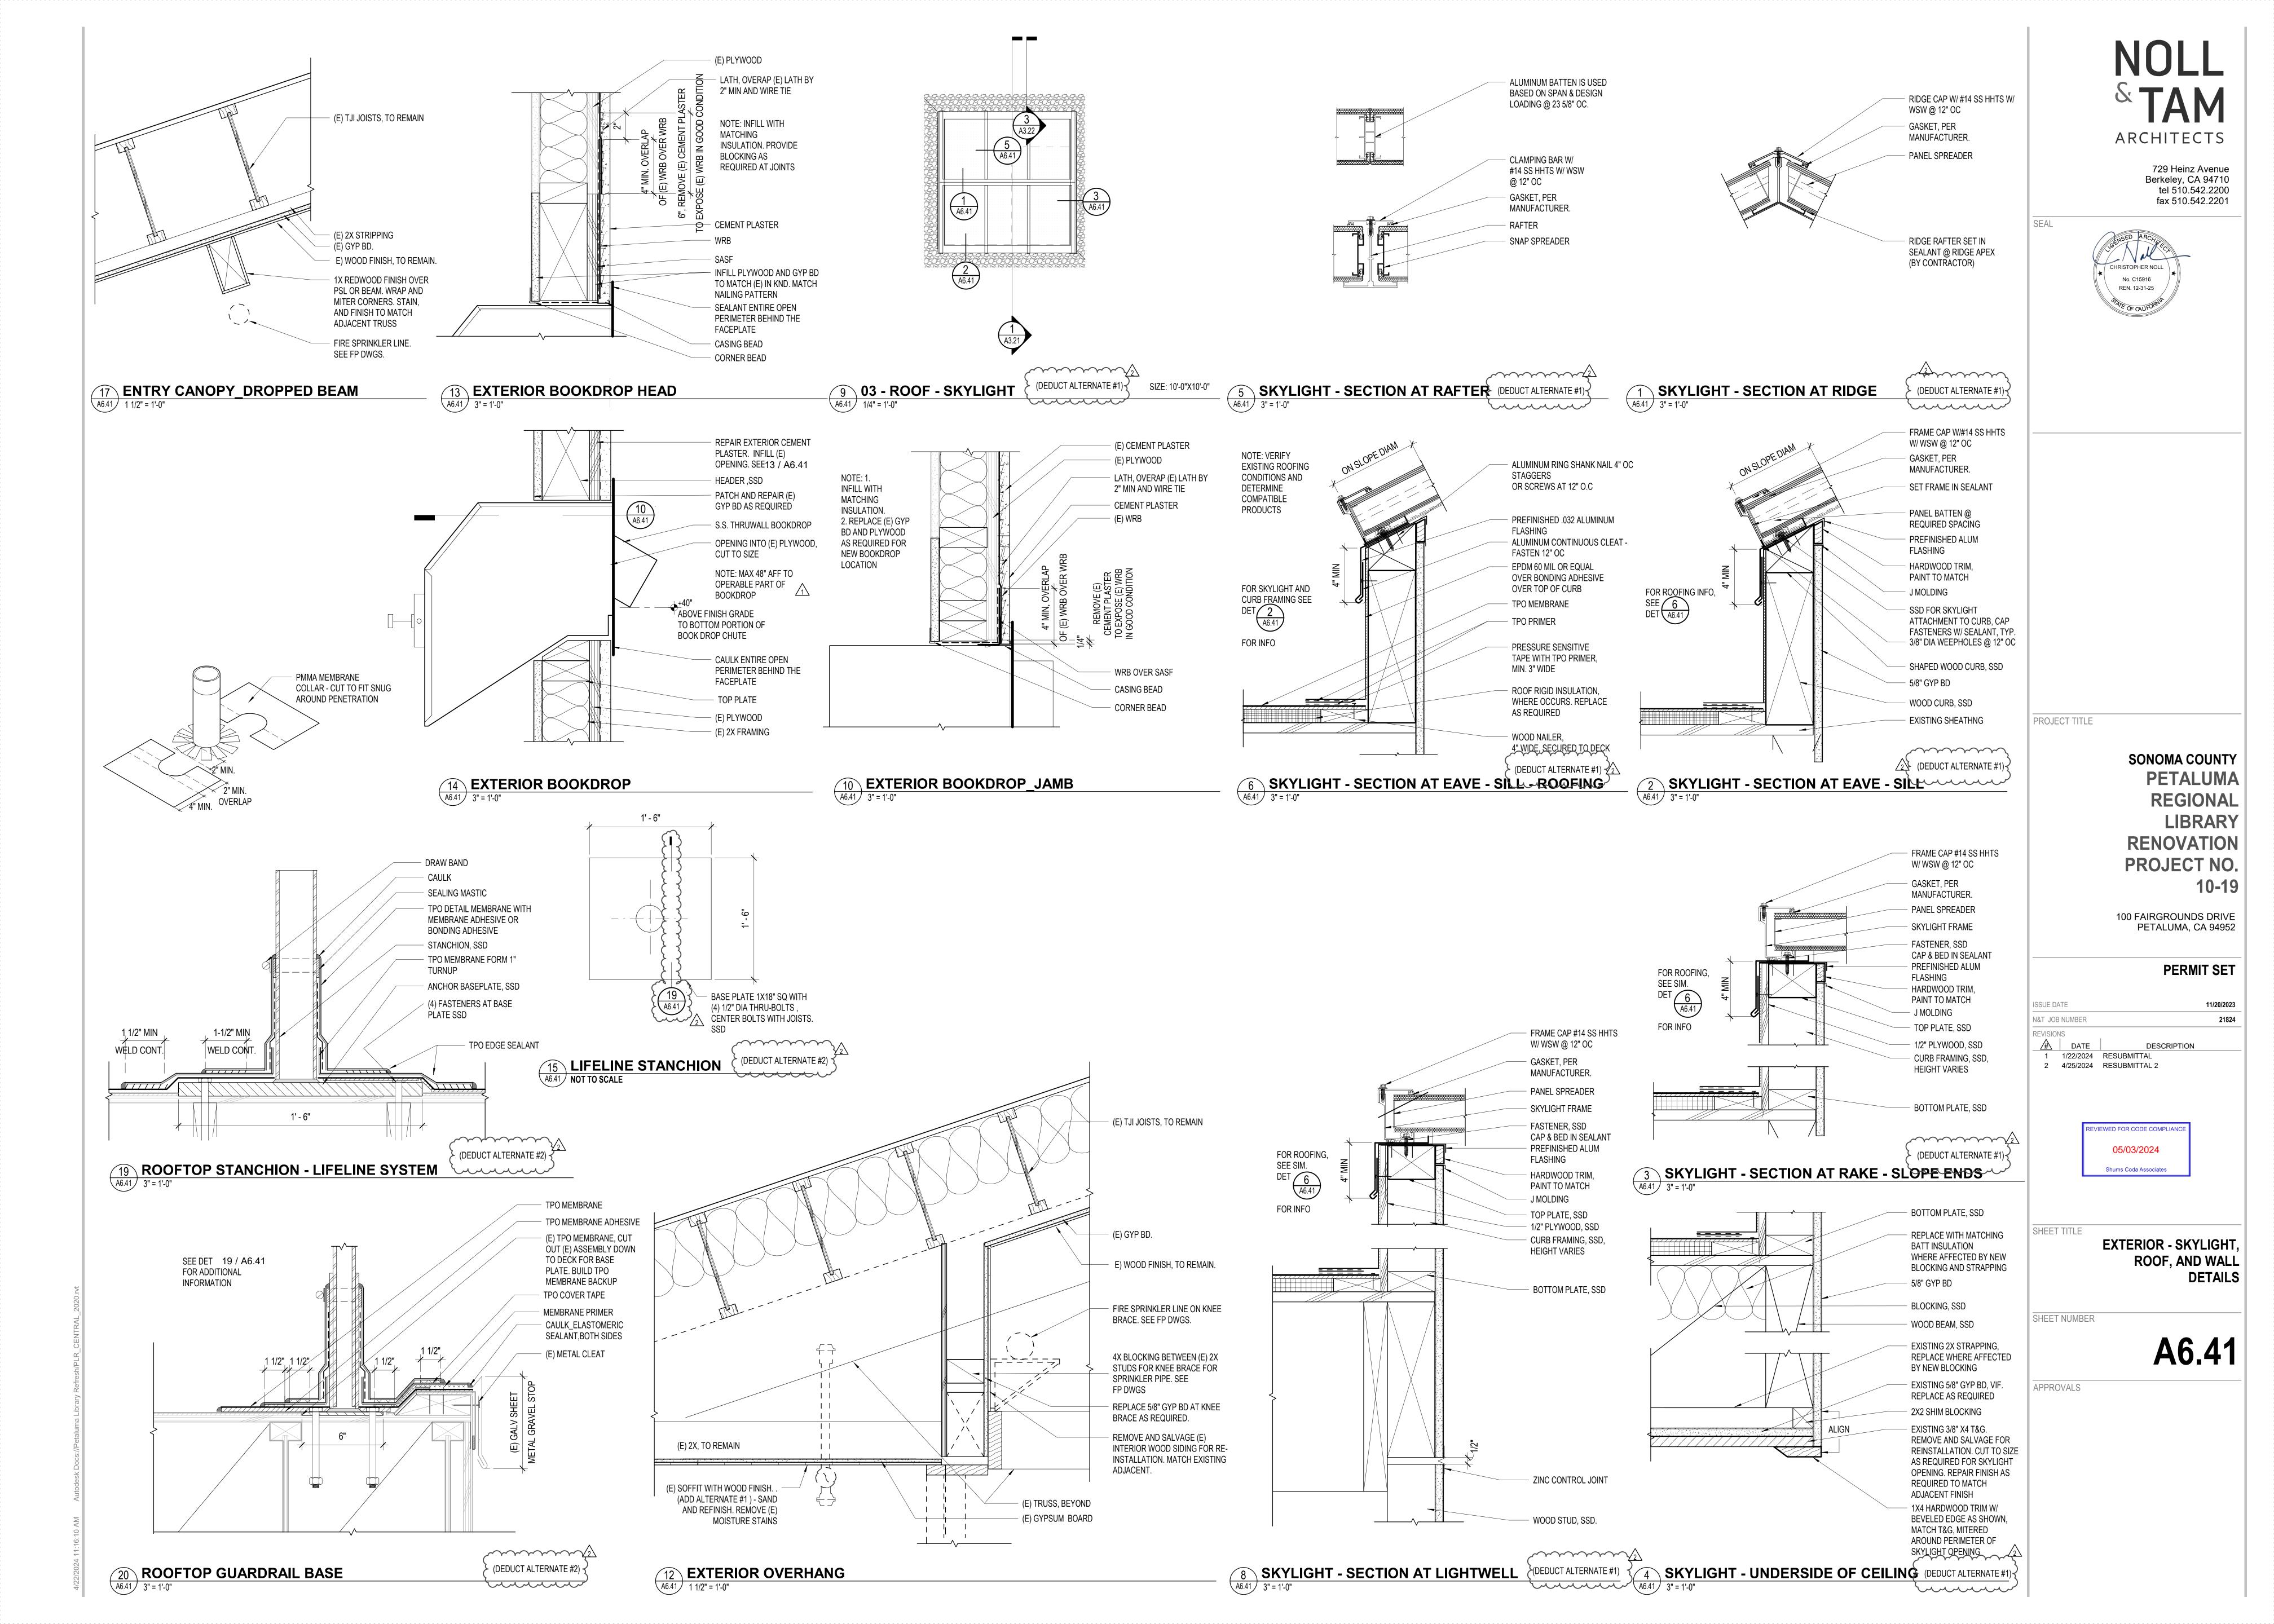

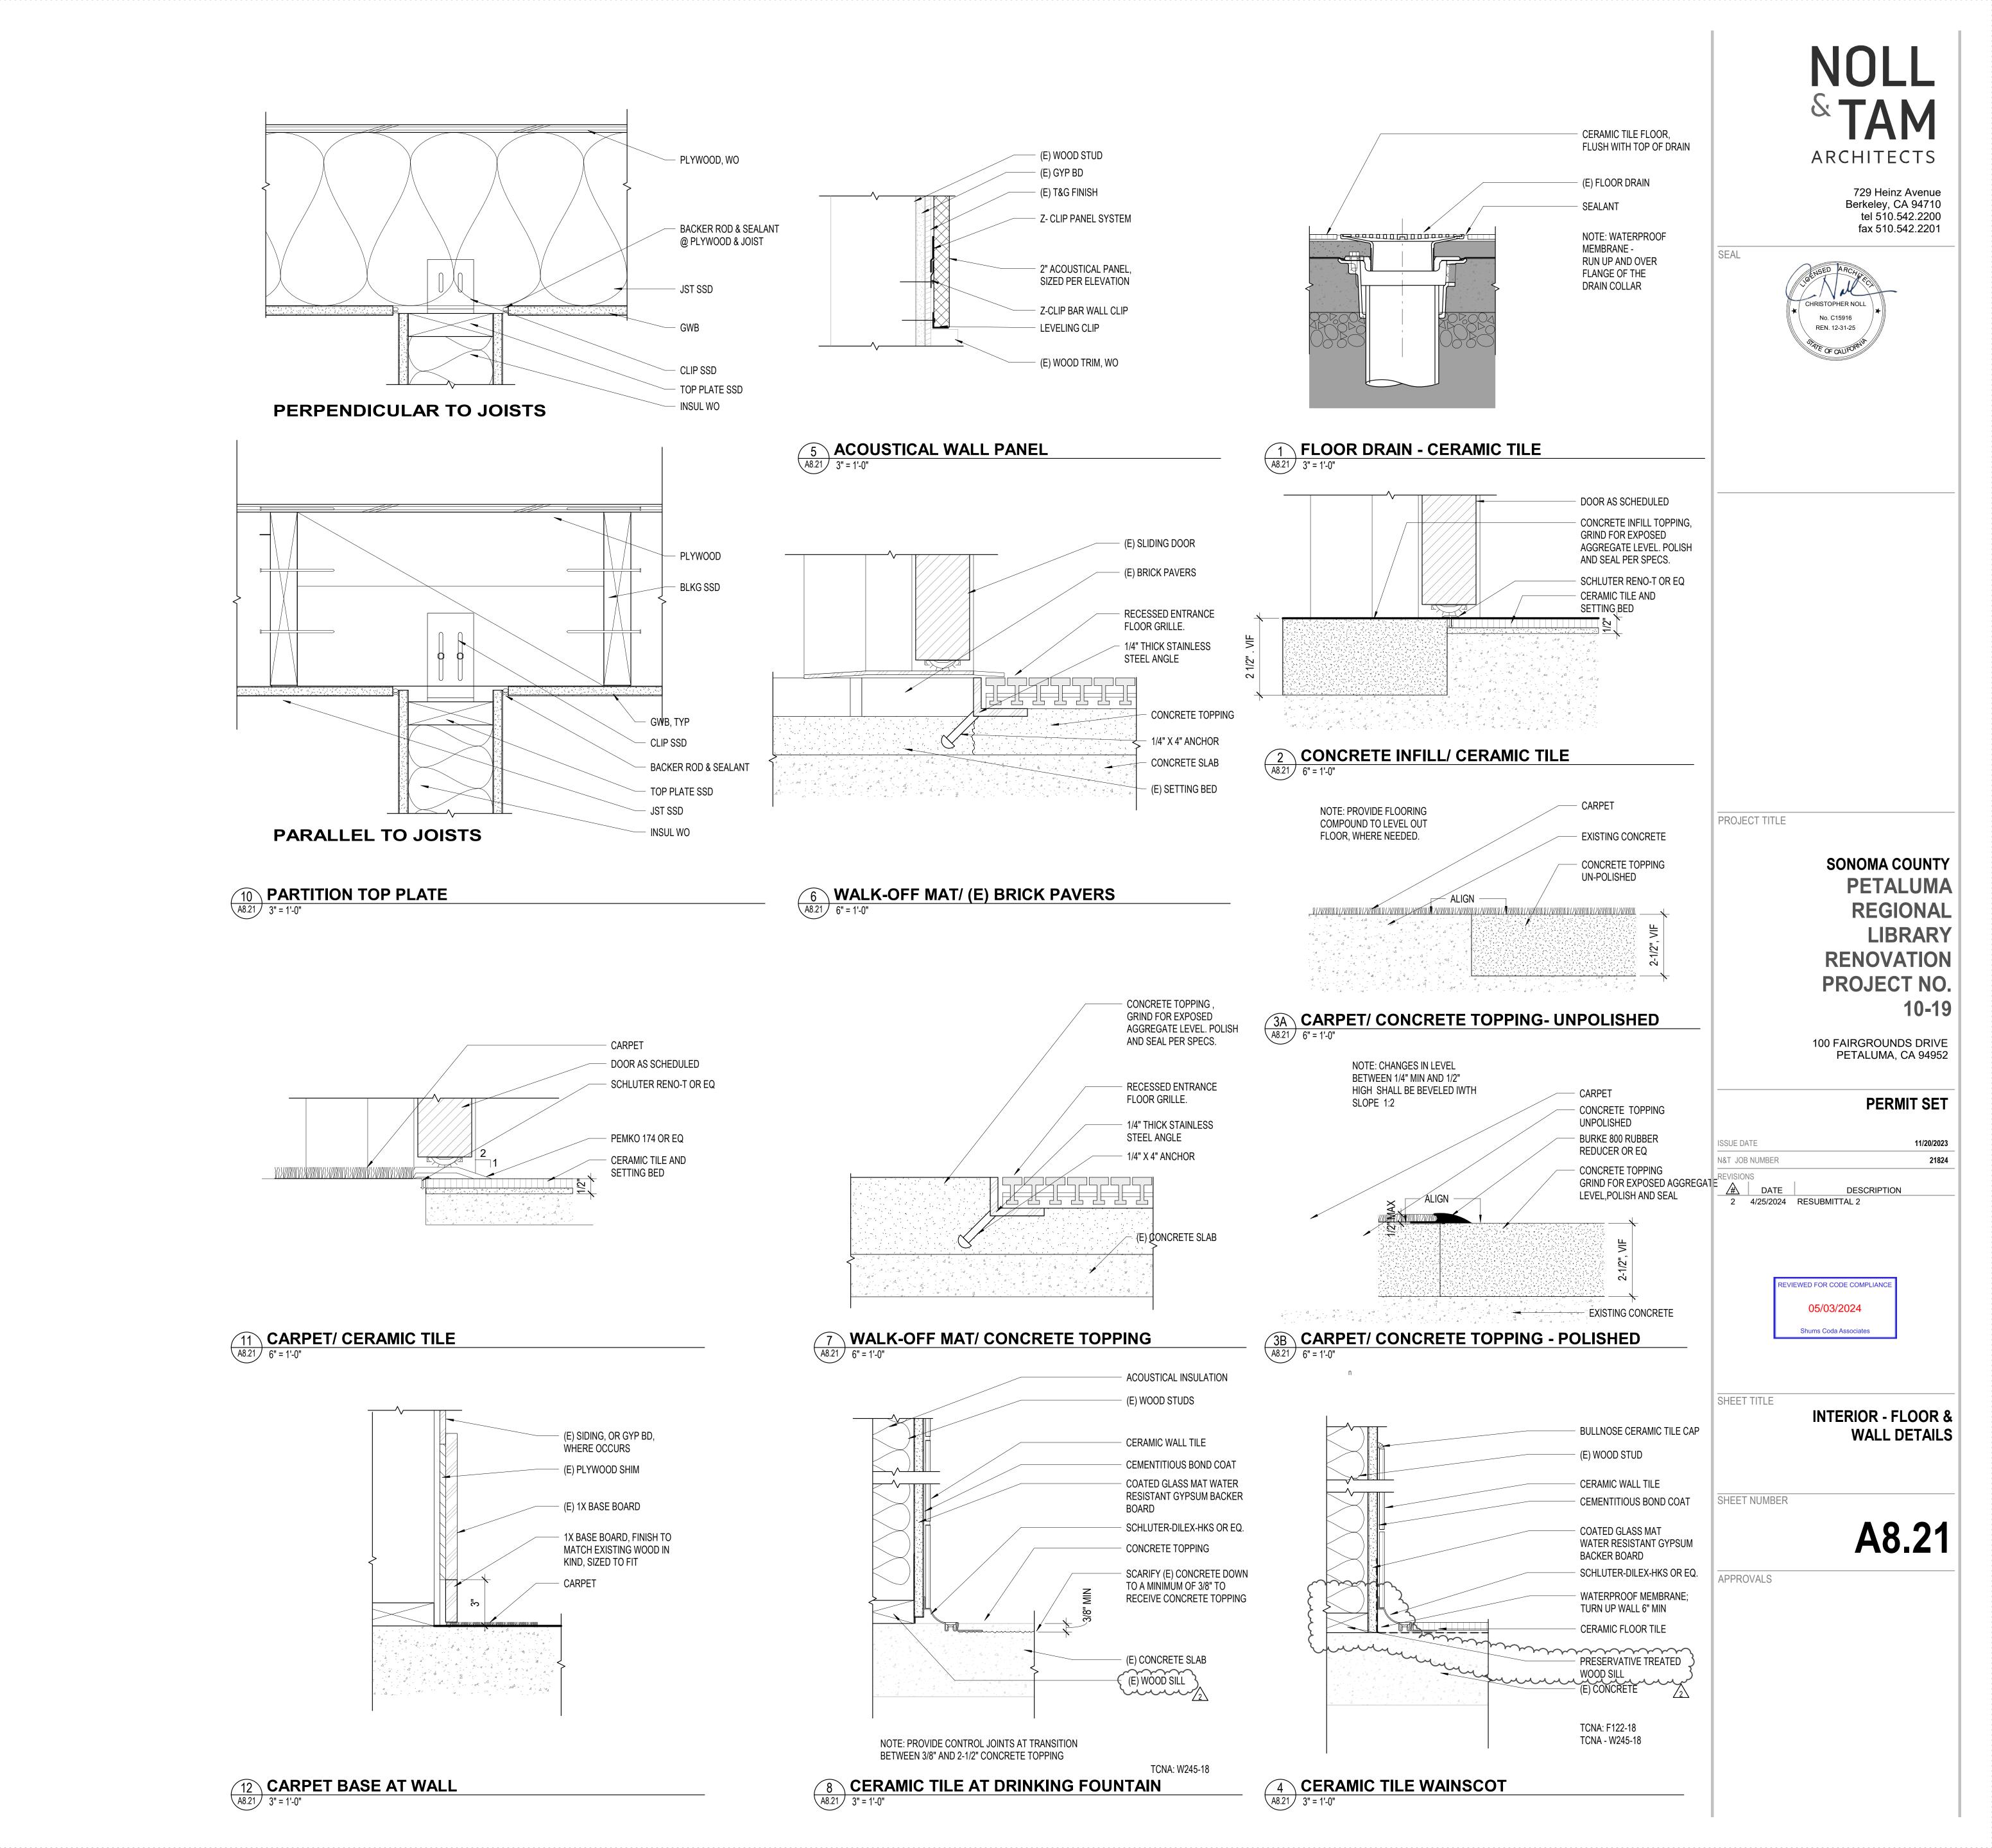

2000 141-16:46 AM Althodock Doce, (Dotalima Library Defendable CENTDAL 2000 at

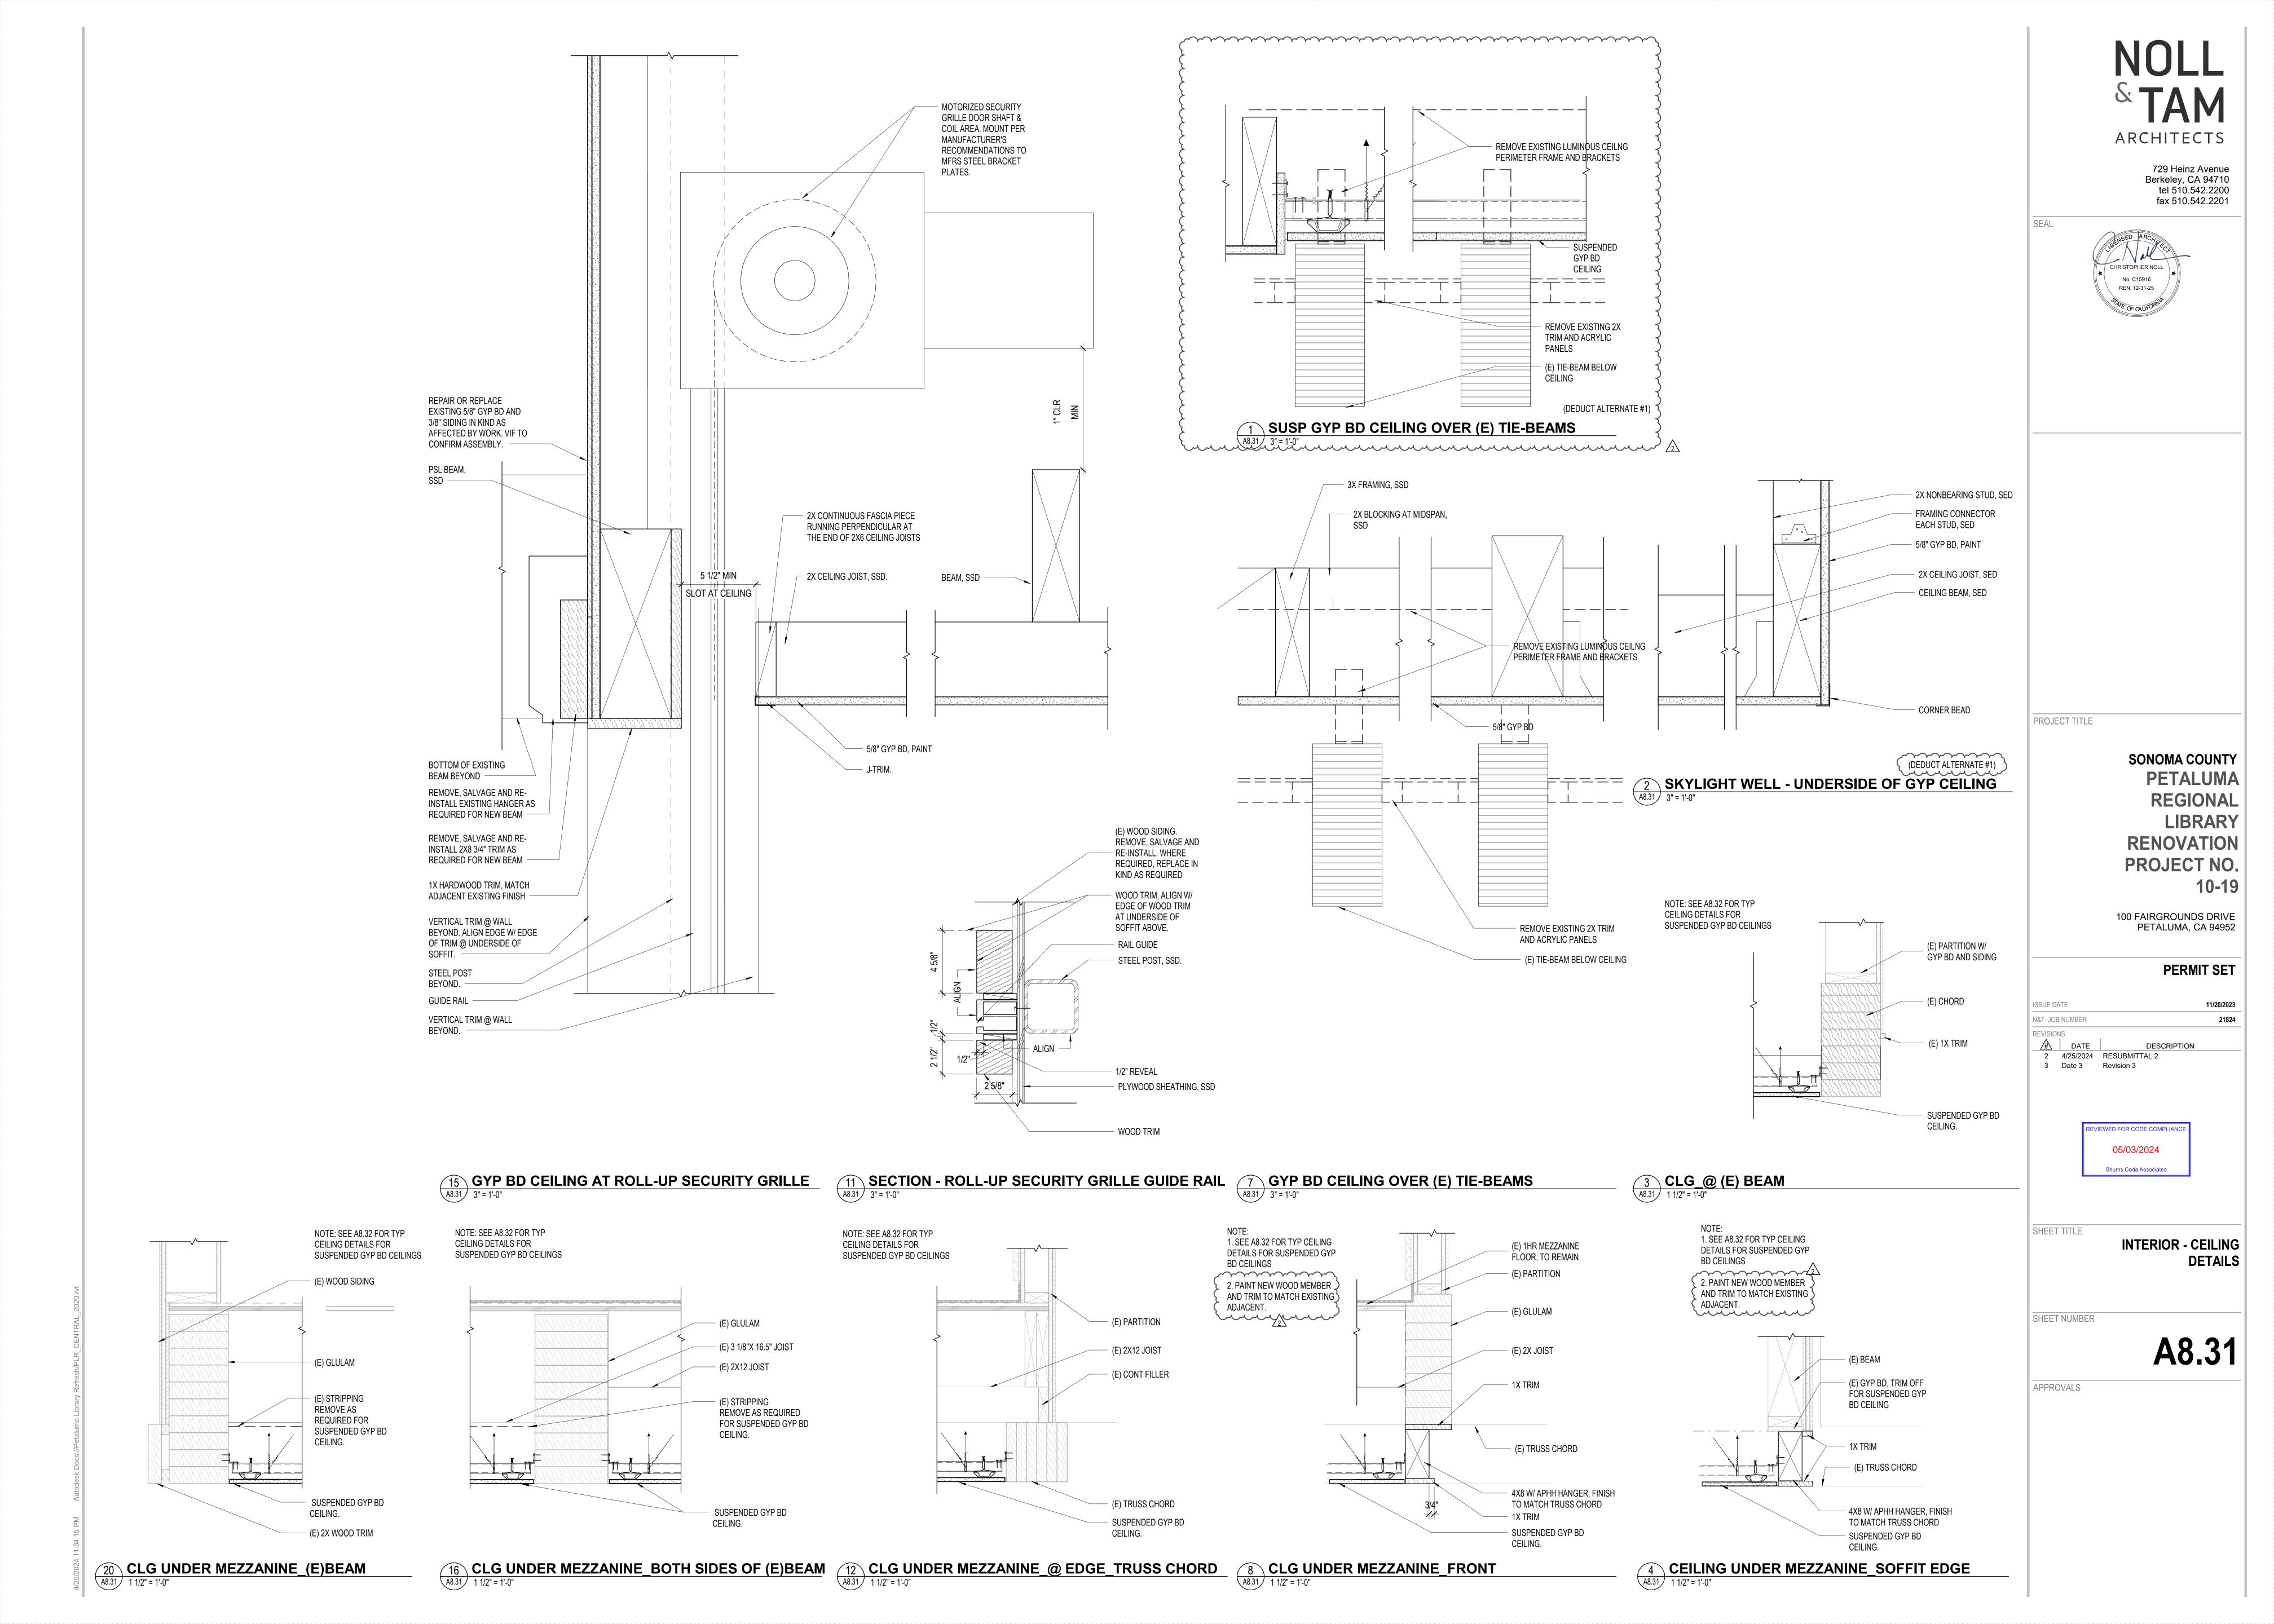


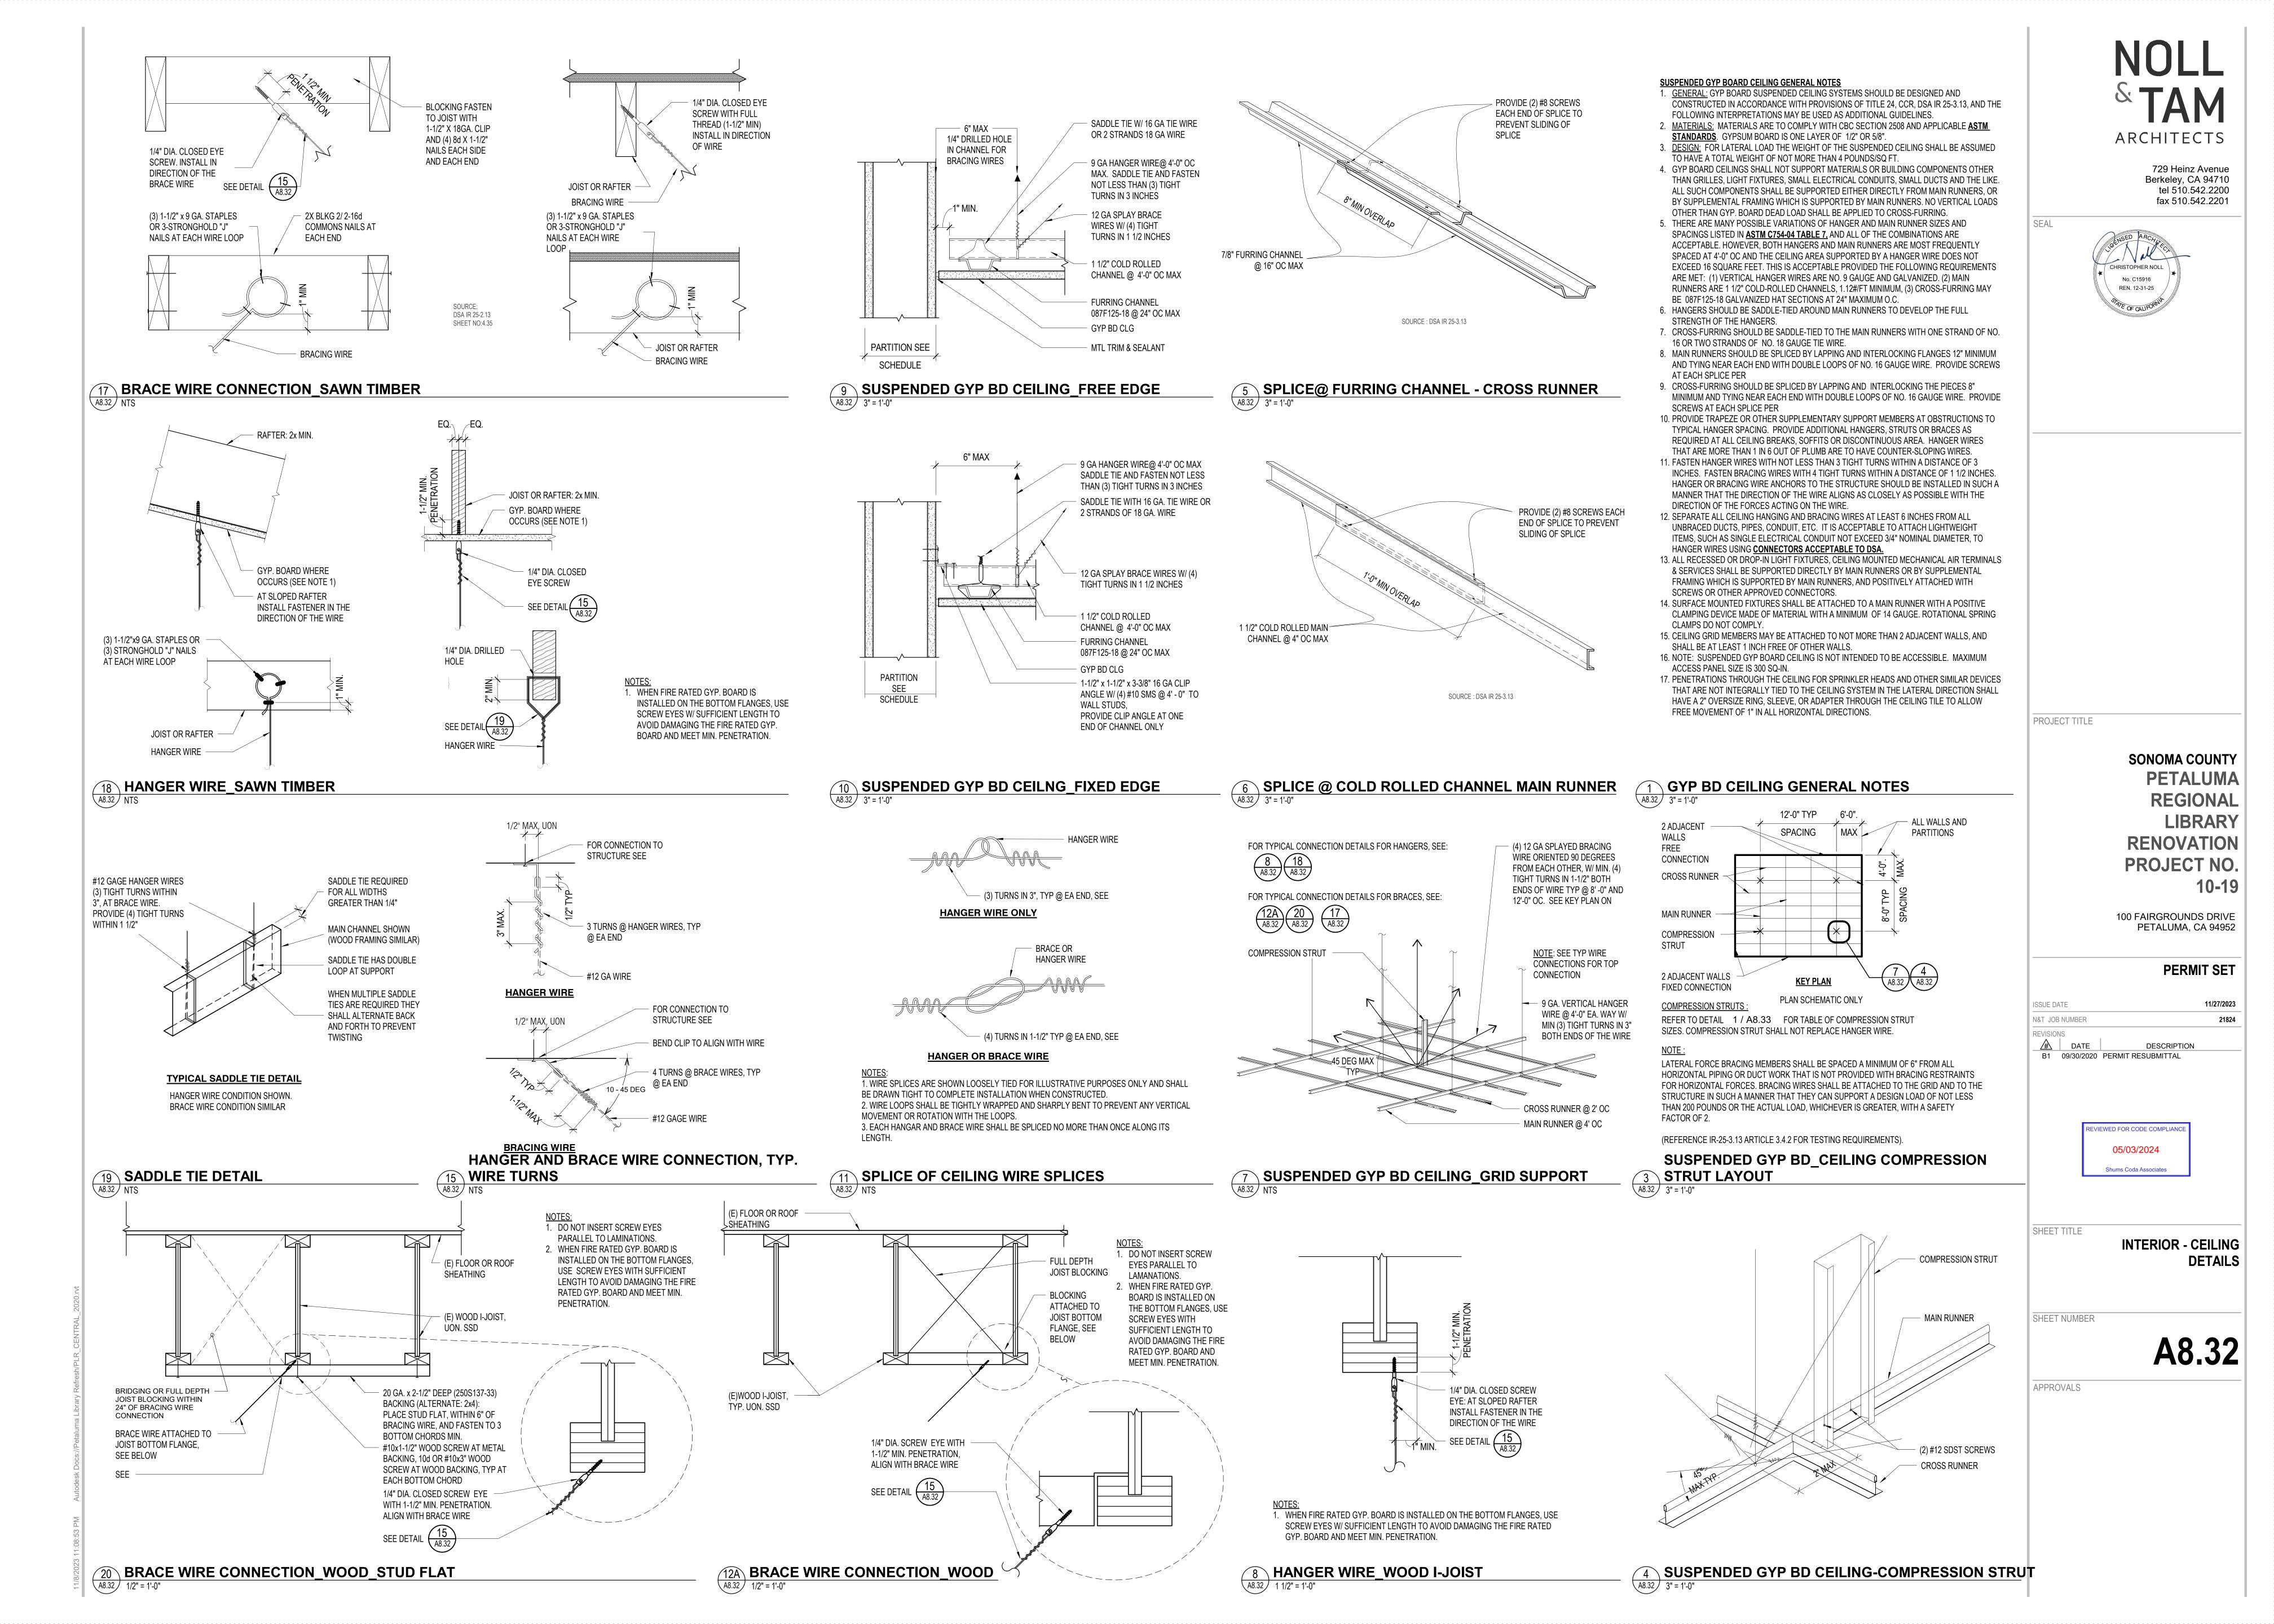


EMT COMPRESSION STRUT	MAXIMU LENGT
1/2" DIAMETER EMT (0.042" WALL THICKNESS)	3'-11"
3/4" DIAMETER EMT (0.049" WALL THICKNESS)	6'-4"
1" DIAMETER EMT (0.057" WALL THICKNESS)	9'-9"
1-1/4" DIAMETER EMT (0.065" WALL THICKNESS)	12'-9"
1-1/2" DIAMETER EMT (0.065" WALL THICKNESS)	14'-9"
2" DIAMETER EMT (0.065" WALL THICKNESS)	18'-10"

CHANNEL COMPRESSION STRUT	MAXIMUM LENGTH
250S125 - 33	5'-0"
250S137 - 33	6'-10"
362S137 - 33	8'-0"
250S137 - 43	8'-10"
400s137 - 43	10'-10"
	,

COMPRESSION STRUT TABLE

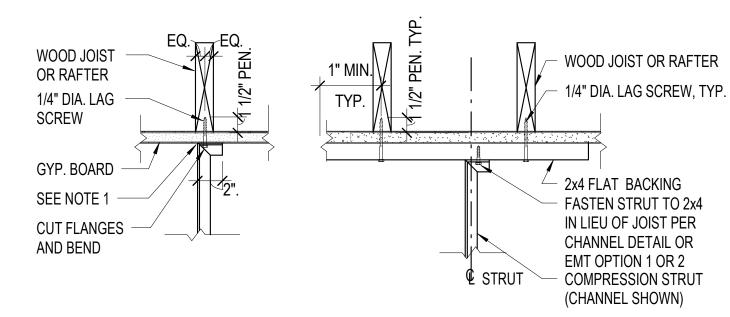

CHANNEL OR EMT STRUT: BETWEEN JOIST CHANNEL STRUT

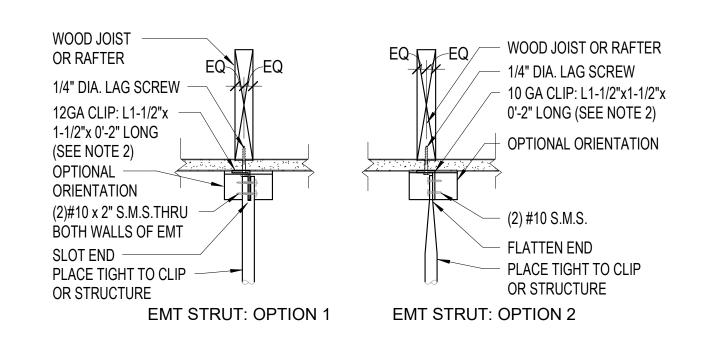


NOTES:

1. WEB OF CHANNEL TO BEAR WITHIN WIDTH OF THE WOOD MEMBER. 2. FOR ANGLE ORIENTED IN THE STANDARD POSITION, VERTICAL LEG TO FALL WITHIN THE

WIDTH OF THE WOOD MEMBER. PEN. = MINIMUM PENETRATION OF LAG SCREW THREADS INTO THE WOOD MEMBER.
 NO. 14 WOOD SCREW MAY BE USED IN LIEU OF 1/4" LAG SCREW.

2 STRUT CONNECTION - SAWN TIMBER W/ GYP BD A8.33 NTS

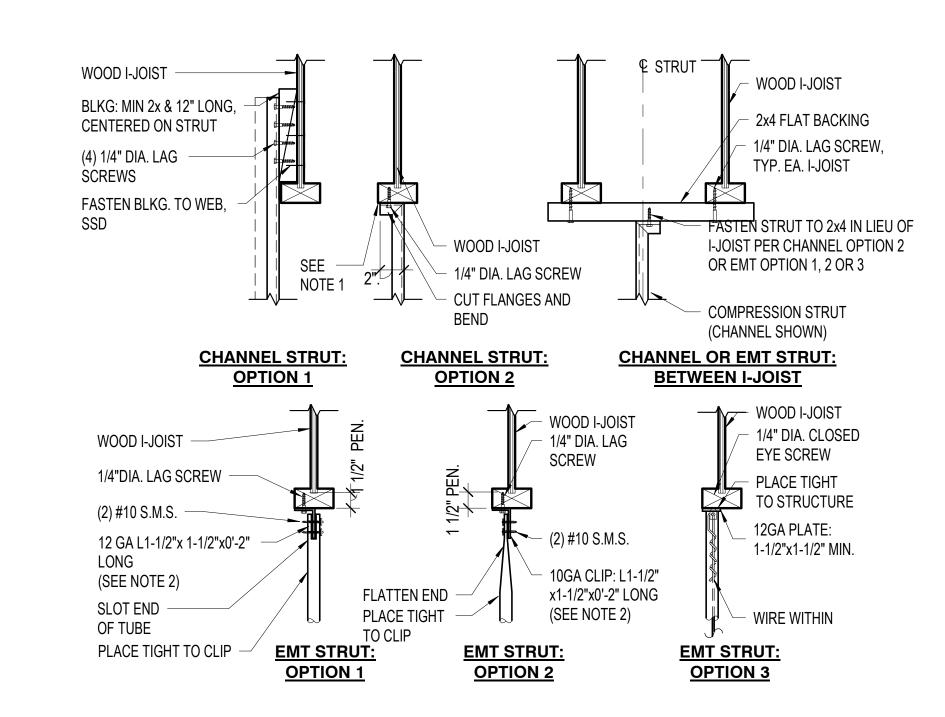


NOTES:

1. WEB OF CHANNEL TO BEAR WITHIN WIDTH OF WOOD MEMBER. 2. VERTICAL LEG OF MEMBER TO FALL WITHIN THE WIDTH OF THE WOOD MEMBER. 3. PEN = MINIMUM PENETRATION OF LAG SCREW THREADS INTO THE WOOD MEMBER. 4. NO. 14 WOOD SCREW MAY BE USED IN LIEU OF 1/4" LAG SCREW.

> STRUT CONNECTION TO I-JOIST

ARCHITECTS

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PROJECT TITLE

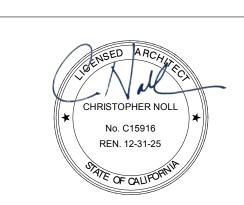ISSUE DATE

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SONOMA COUNTY PETALUMA REGIONAL LIBRARY RENOVATION PROJECT NO.

100 FAIRGROUNDS DRIVE PETALUMA, CA 94952

PERMIT SET N&T JOB NUMBER 21824

DESCRIPTION

REVIEWED FOR CODE COMPLIANCE 05/03/2024


SHEET TITLE


Shums Coda Associates

INTERIOR - CEILING **DETAILS**

SHEET NUMBER


A8.33

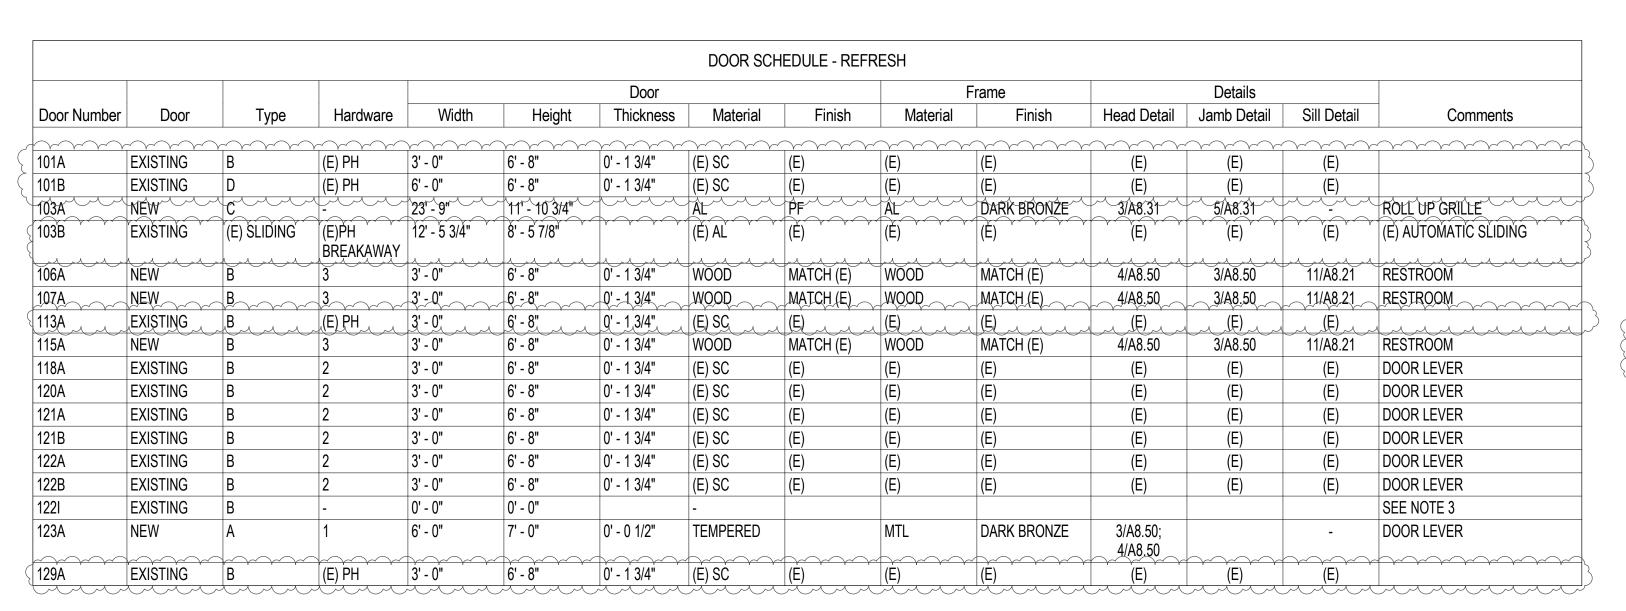


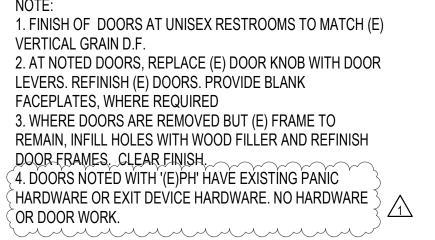


ARCHITECTS

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DOOR TYPE LEGEND

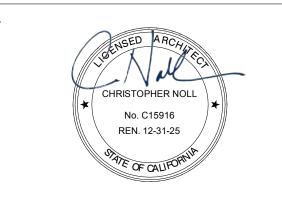

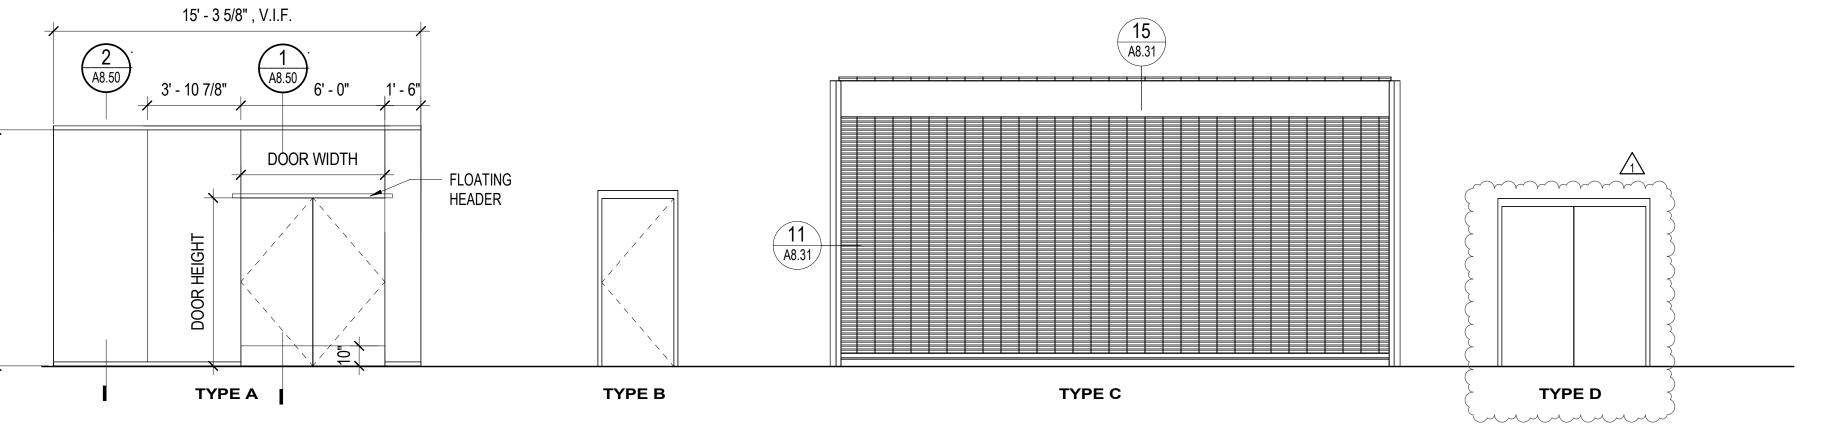- WALL FINISH PER INTERIOR **ELEVATION** NOTE: AT RESTROOM 106 & 107, 5/8" GYP & 3/8" SIDING (MATCH EXISTING) - WHERE POSSIBLE SALVAGE AND REFINISH (E) SIDING TO MATCH EXISTING. - 1X8 TRIM - VIF. MATCH (E) PROFILE 1X2 CASING TRIM - VIF. MATCH (E) PROFILE ON INTERIOR SIDE OF ROOM WOOD DOOR FRAME, MATCH (E) PROFILE,

CLEAR FIŃISH

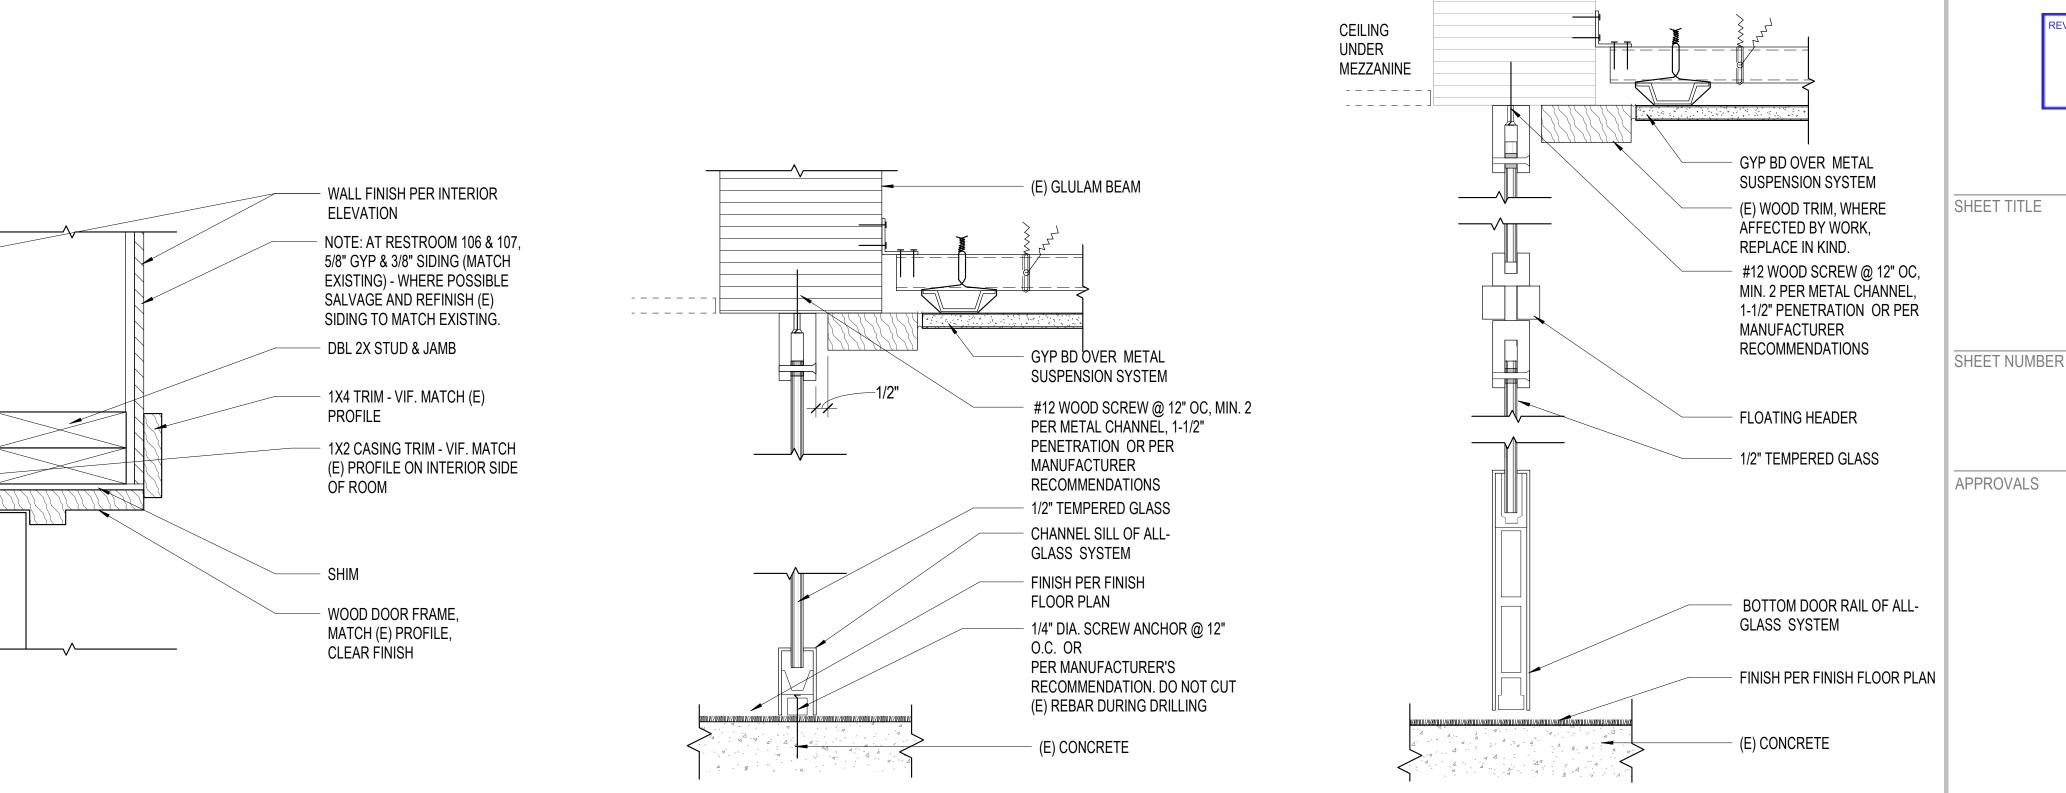4 DOOR HEAD, TYP

DOOR JAMB, TYP

ALL GLASS STOREFRONT_ HEAD_SILL

ALL GLASS STOREFRONT_DOOR HEAD_SILL

100 FAIRGROUNDS DRIVE PETALUMA, CA 94952 **PERMIT SET** ISSUE DATE N&T JOB NUMBER REVISIONS A DATE DESCRIPTION 1 1/22/2024 RESUBMITTAL REVIEWED FOR CODE COMPLIANCE 05/03/2024 Shums Coda Associates INTERIOR - WINDOW & **STOREFRONT**

SCHEDULE AND TYPES

A8.50

SONOMA COUNTY

RENOVATION

PROJECT NO.


PETALUMA


REGIONAL


LIBRARY

PROJECT TITLE

(E) GLULAM BEAM

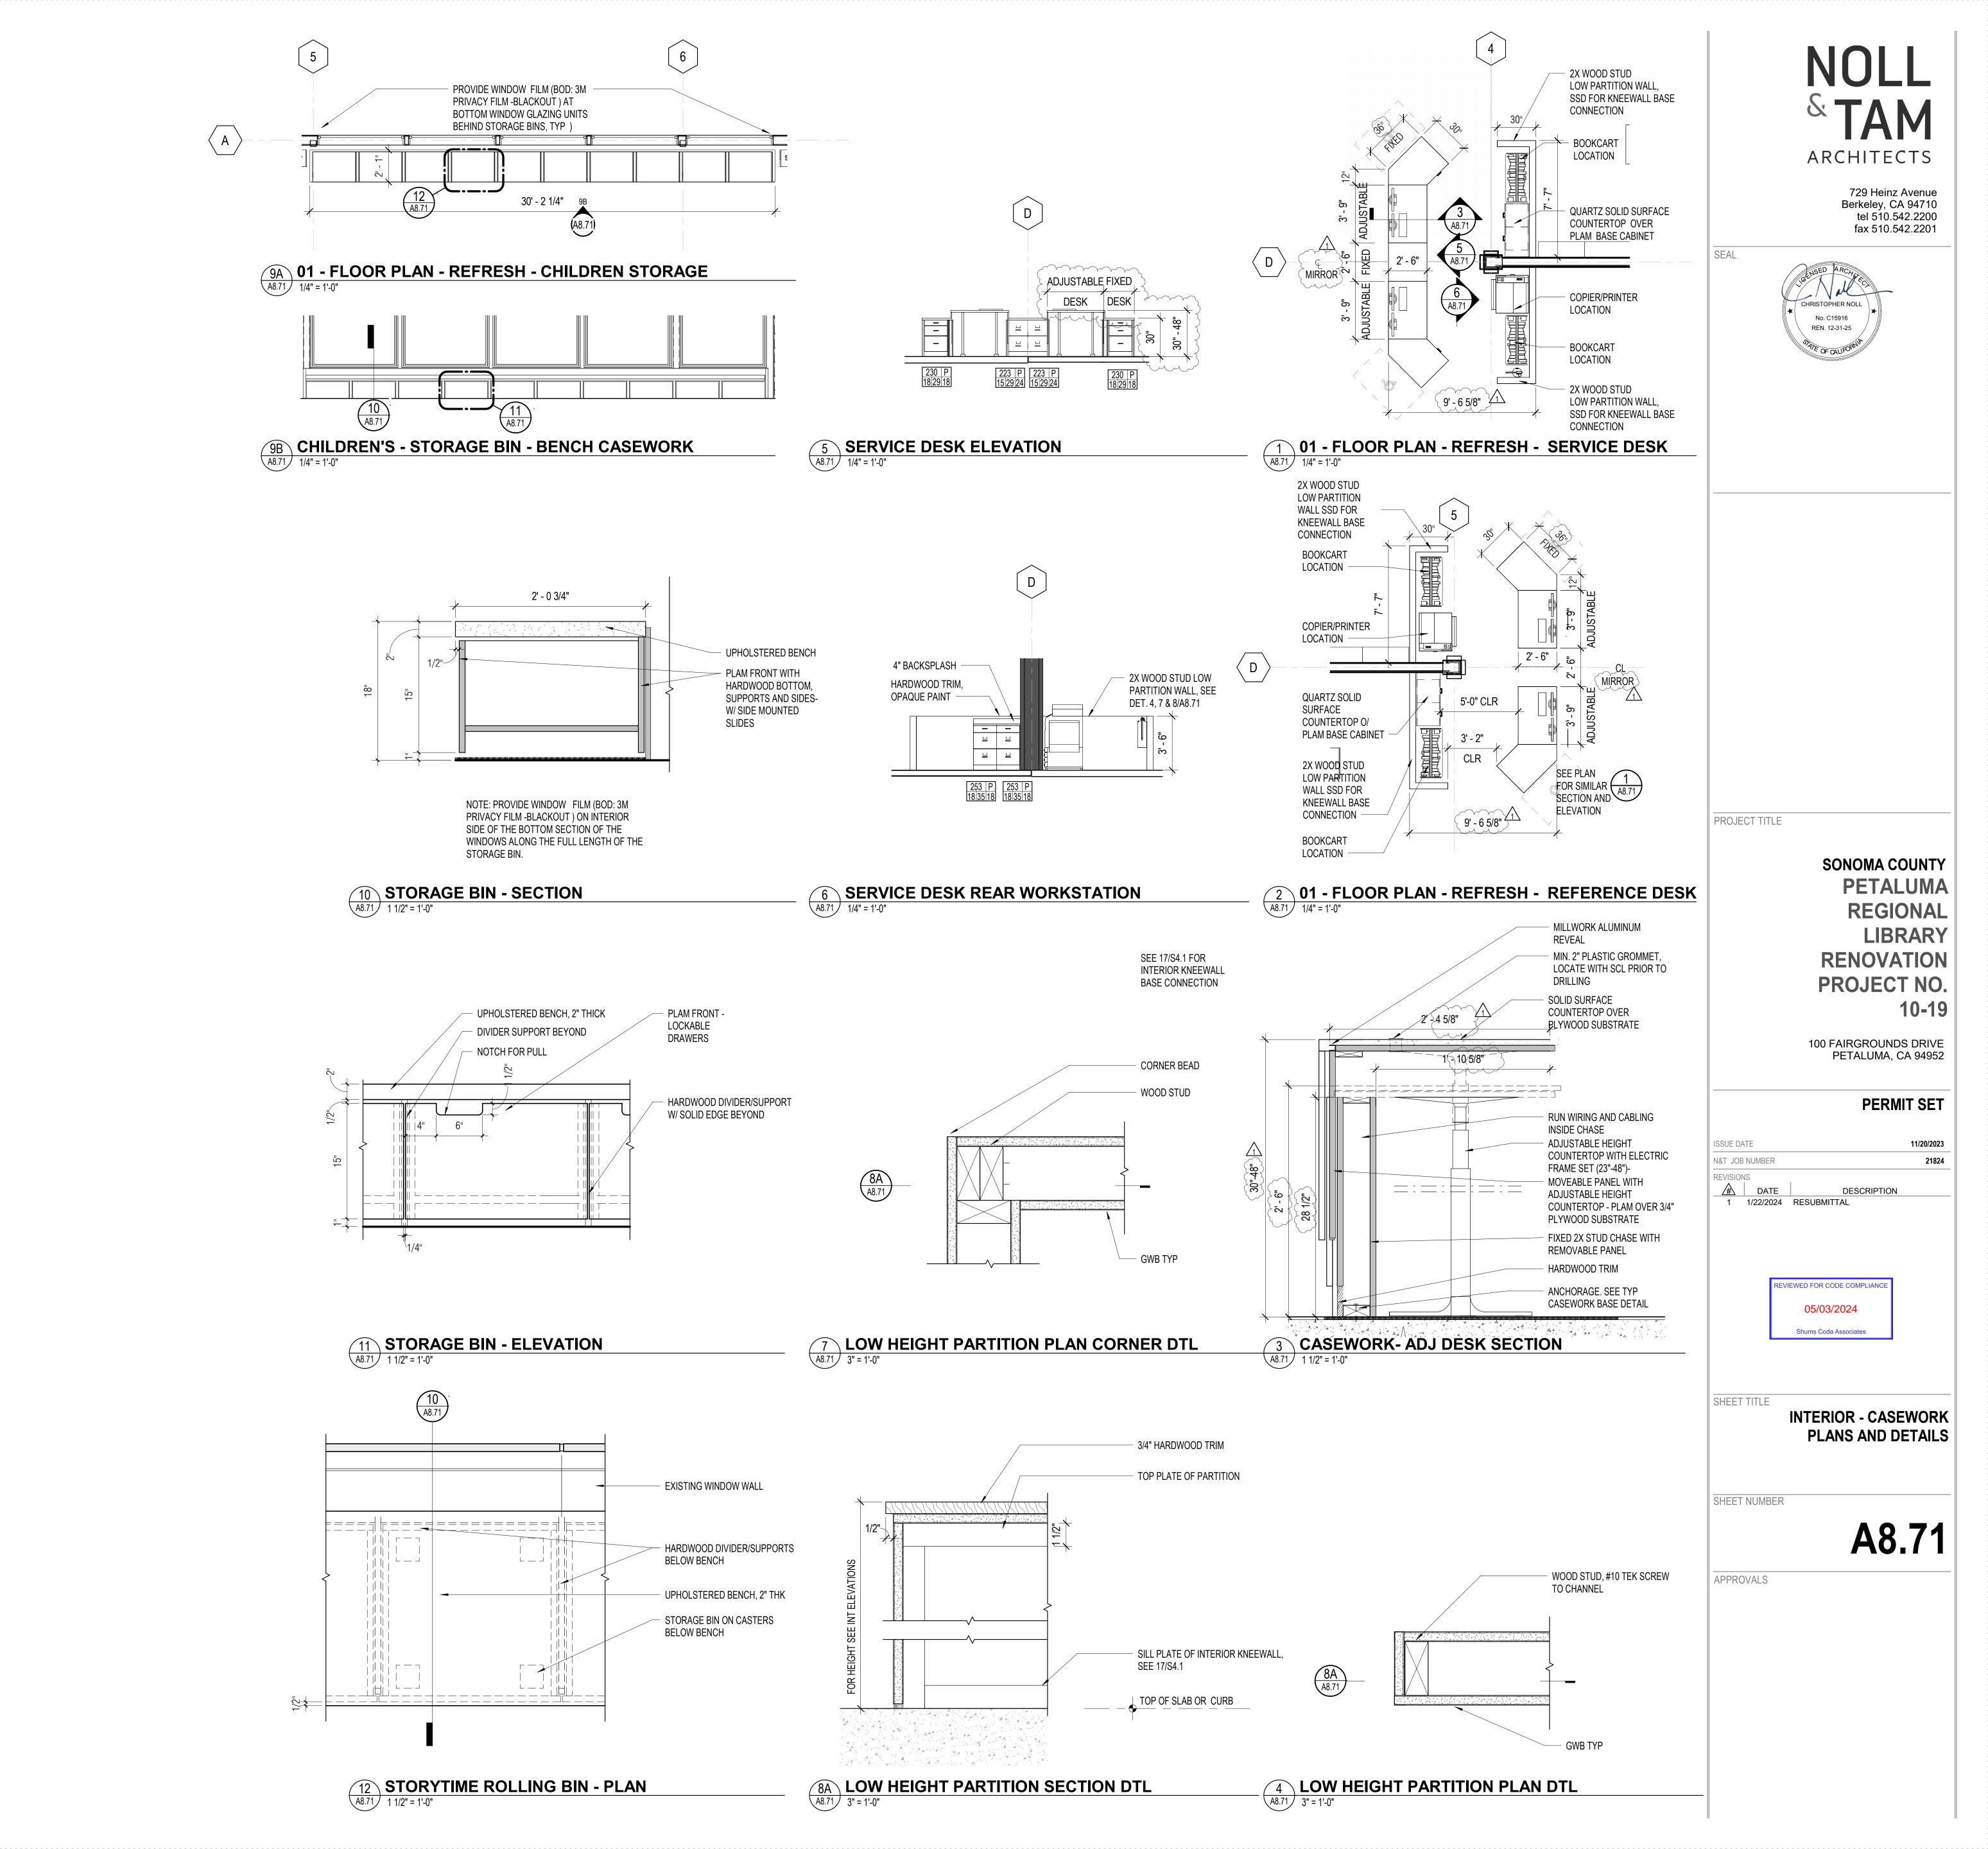

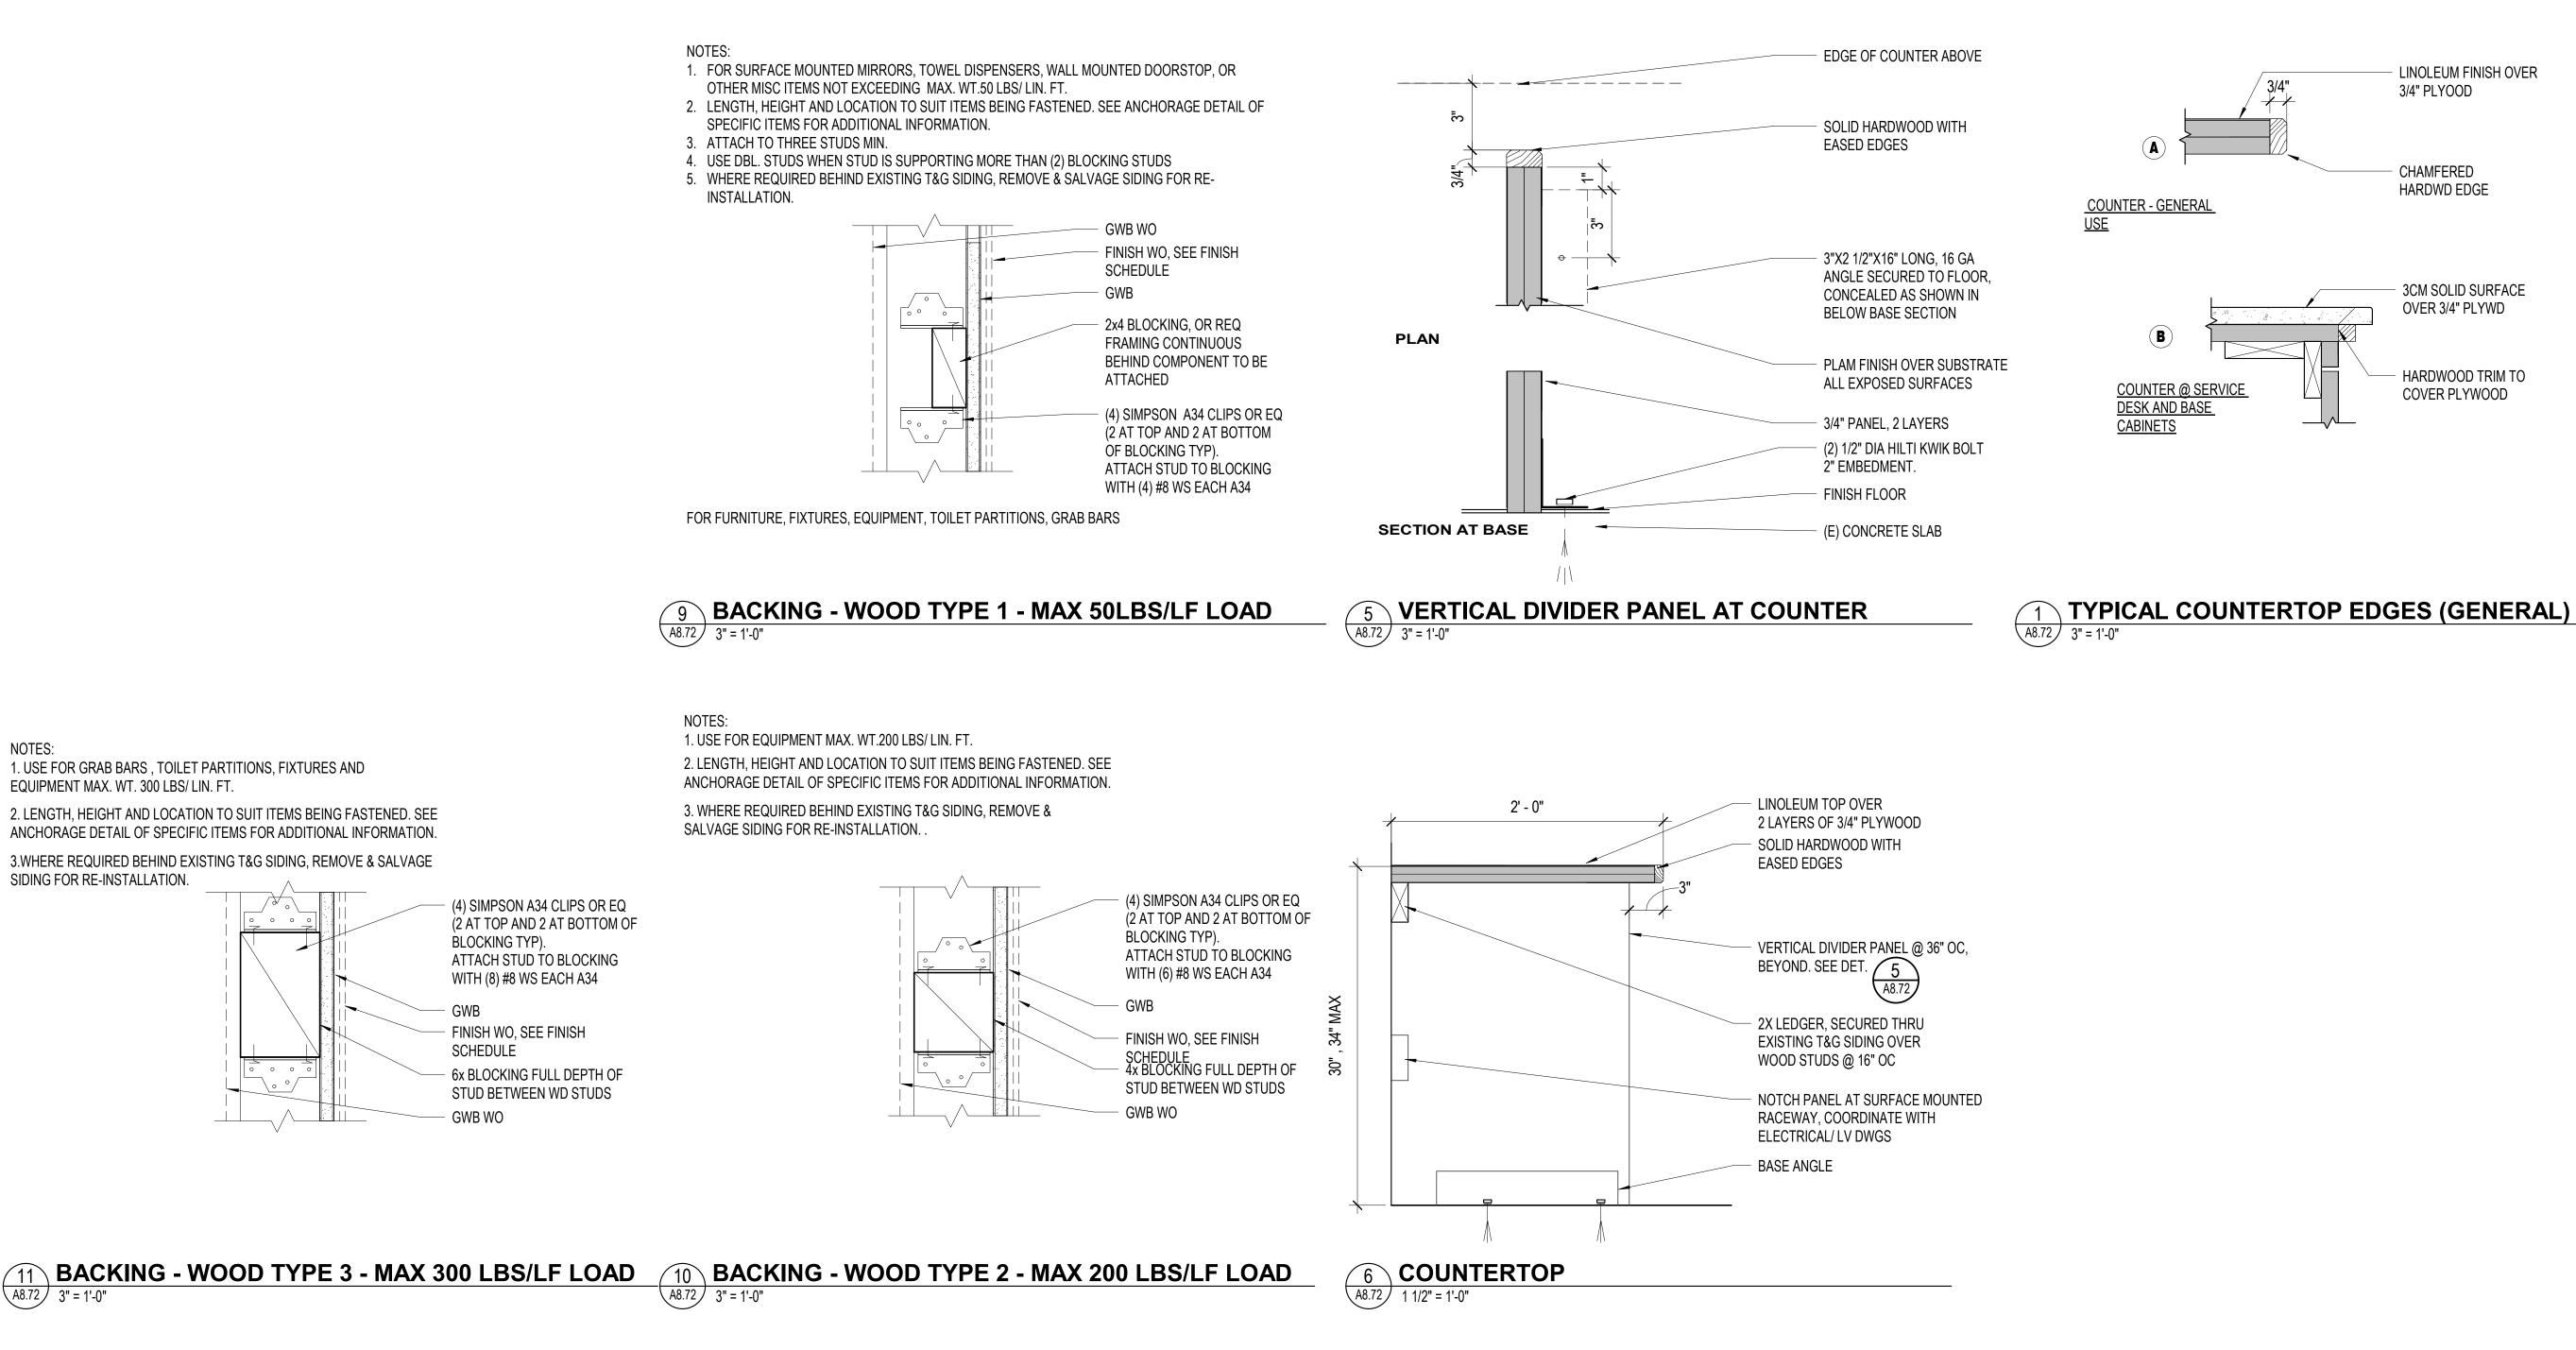

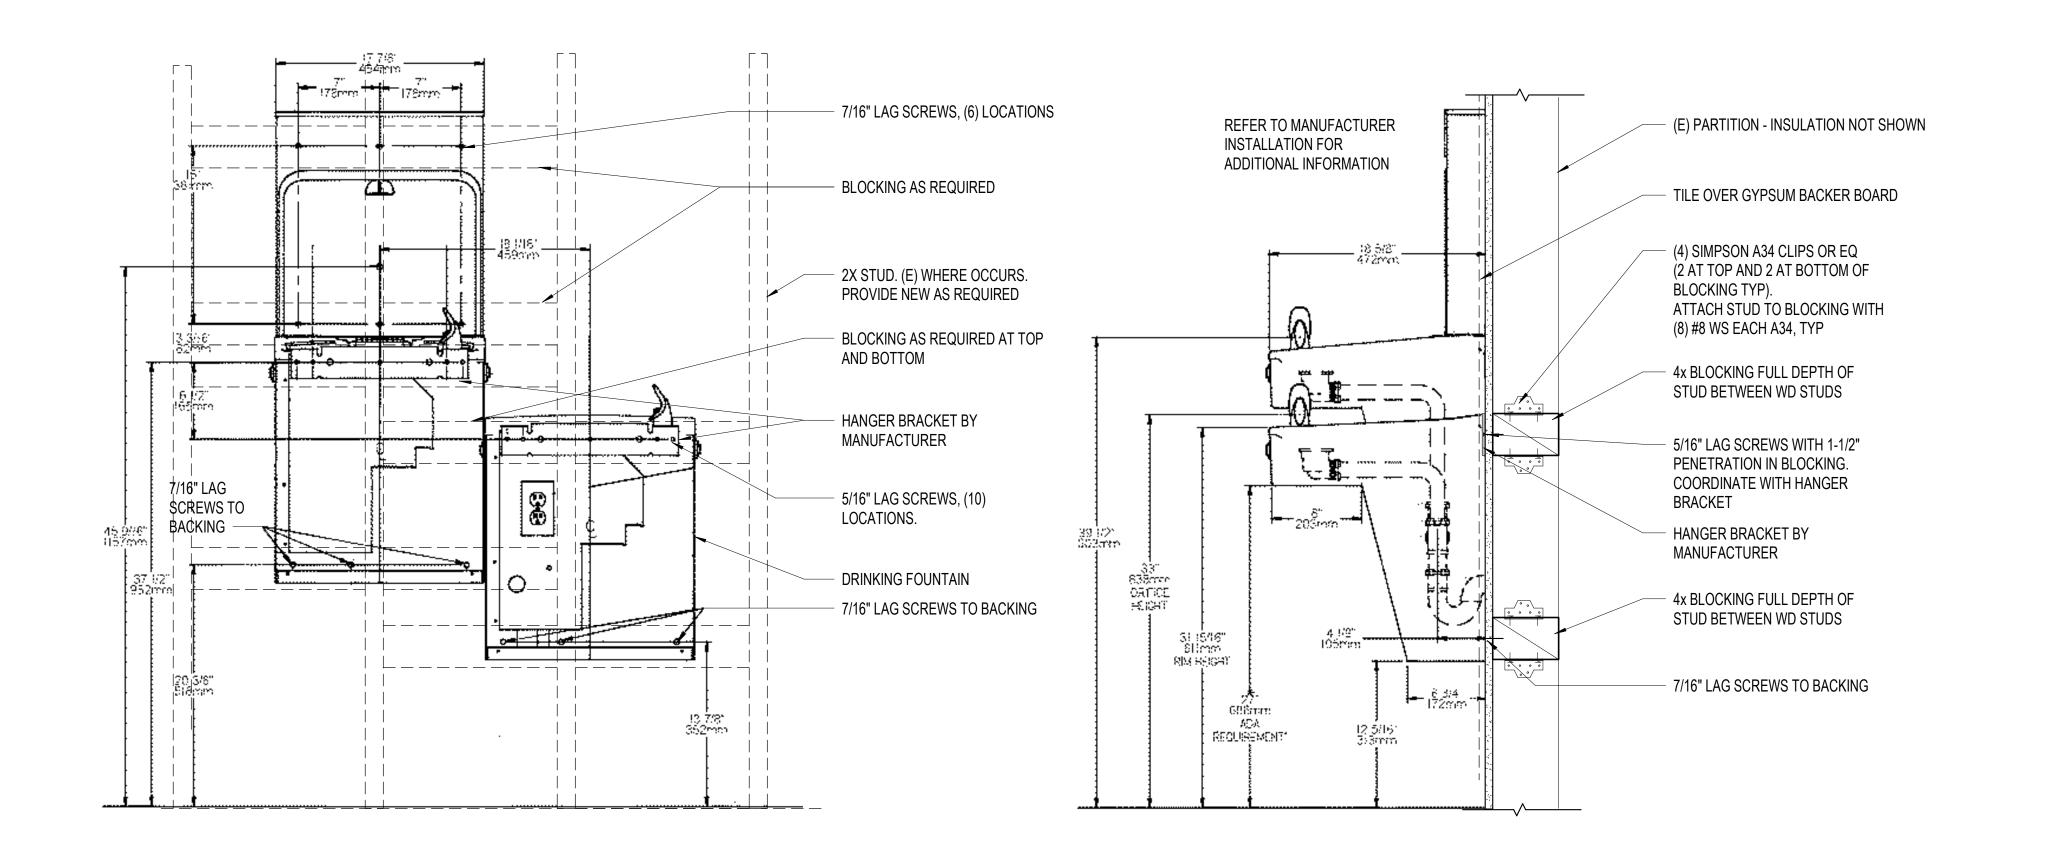

ARCHITECTS

LINOLEUM FINISH OVER

3/4" PLYOOD

- CHAMFERED

COUNTER - GENERAL USE

COUNTER @ SERVICE

DESK AND BASE

HARDWD EDGE


- 3CM SOLID SURFACE

HARDWOOD TRIM TO

COVER PLYWOOD

OVER 3/4" PLYWD

729 Heinz Avenue Berkeley, CA 94710 tel 510.542.2200 fax 510.542.2201

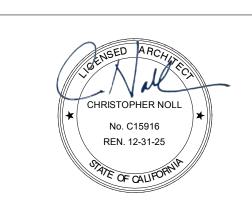

PROJECT TITLE

SONOMA COUNTY PETALUMA REGIONAL LIBRARY RENOVATION PROJECT NO.

100 FAIRGROUNDS DRIVE PETALUMA, CA 94952

PERMIT SET

ISSUE DATE N&T JOB NUMBER REVISIONS DESCRIPTION

> REVIEWED FOR CODE COMPLIANCE 05/03/2024

> > Shums Coda Associates

INTERIOR - CASEWORK AND MISC DETAILS

SHEET NUMBER

A8.72

APPROVALS

12 DRINKING FOUNTAIN

NOTES:

1. USE FOR GRAB BARS , TOILET PARTITIONS, FIXTURES AND

2. LENGTH, HEIGHT AND LOCATION TO SUIT ITEMS BEING FASTENED. SEE

ANCHORAGE DETAIL OF SPECIFIC ITEMS FOR ADDITIONAL INFORMATION.


3.WHERE REQUIRED BEHIND EXISTING T&G SIDING, REMOVE & SALVAGE

BLOCKING TYP).

SCHEDULE

EQUIPMENT MAX. WT. 300 LBS/ LIN. FT.

SIDING FOR RE-INSTALLATION.

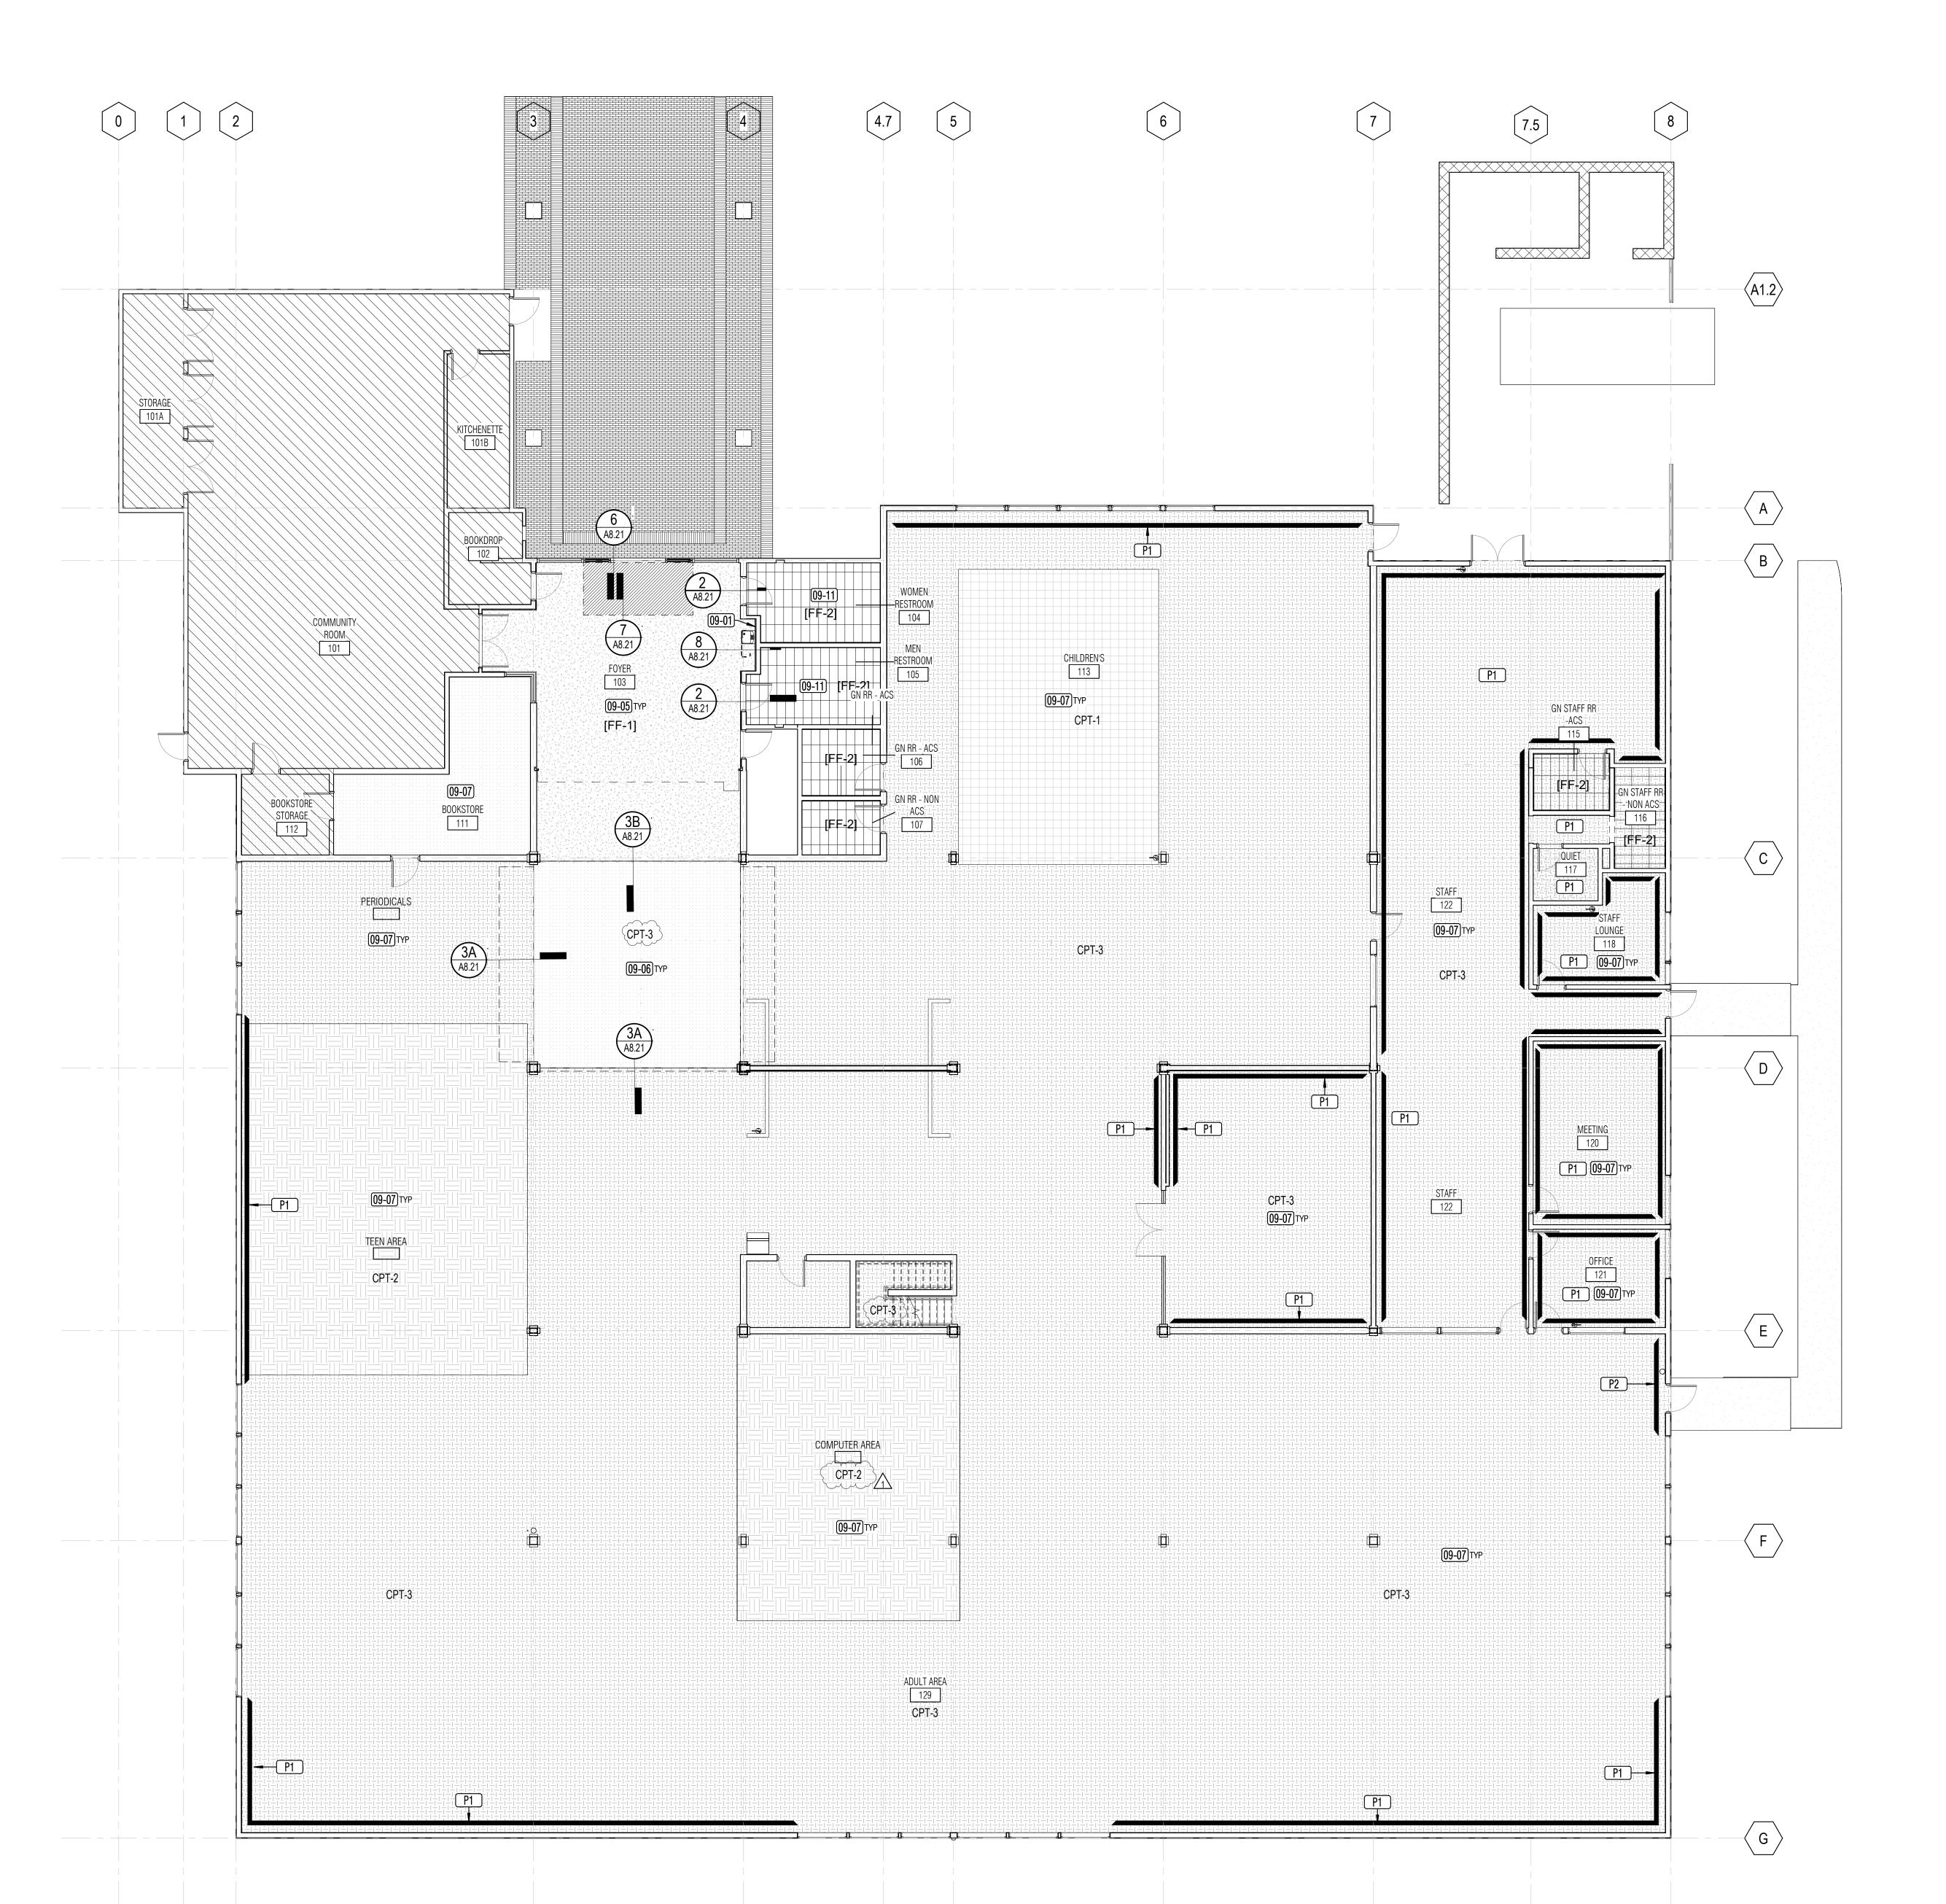



729 Heinz Avenue Berkeley, CA 94710 tel 510.542.2200 fax 510.542.2201

EAL



INTERIOR WALL PAINT KEY

DET. 7/A8.21

PAINT (E) GYP BD WALL AND NEW GYP BD WALL, WHERE OCCURS.

KEYNOTE LEGEND

PROVIDE CERAMIC TILE FINISH AT ALCOVE WALLS

FLOAT FLOORING AS REQUIRED.

Keynote Text

PROVIDE CONCRETE INFILL FLOOR TOPPING AT DEPRESSSED

PROVIDE CARPET FINISH OVER CONCRETE INFILL FLOOR TOPPING AT DEPRESSSED SLAB ,BETWEEN GRIDLINE 3&4, C&D.

PROVIDE CARPET TILE FINISH AND WOOD BASE- STAINED TO MATCH EXISTING T&G SIDING. FOR BASE, FIT TO EXISTING HEIGHT CONDITION. SEE FINISH PLAN FOR CARPET TYPE. SEE

PROVIDE CERAMIC TILE FLOORING. SEE FINISH SCHEDULE.

SLAB. GRIND AND POLISH CONCRETE FLOOR AND SEAL (BETWEEN GRIDLINE 3&4 AND B&C, INCLUDING ENTRY TO COMMUNITY ROOM).

T&G SIDING ON WALLS TO REMAIN - NO PAINT

NOTE:
1. IN RESTROOMS, PAINT EXISTING GYP BD FINISH ABOVE CERAMIC
WAINSCOT AND EXISTING AND NEW CEILINGS

2. PAINT EXISTING AND NEW GYP BD CEILINGS ON FIRST FLOOR EXISTING T&G CEILING AND EXPOSED STRUCTURE TO REMAIN - NO


3. REFER TO INTERIOR ELEVATION FOR ADDITIONAL INFORMATION.

4. PAINT EXPOSED FIRE SPRINKLER PIPING AND ASSOCIATED WALL AND CEILING BRACKETS. EXISTING FIRE SPRINKLER PIPING IN COMMUNITY ROOM TO REMAIN AS IS. COLOR TBD

5. PAINT EXPOSED DUCTWORK. COLOR TBD

6. ALLOW UP TO 5000 SF OF STAIN AND REFINISH TOUCHUP AT EXISTING WOOD FINISHES AT WALLS, CEILINGS AND DOORS. LOCATIONS TO BE DETERMINED IN FIELD WITH OWNER AND ARCHITECT.

FINISH PLAN LEGEND

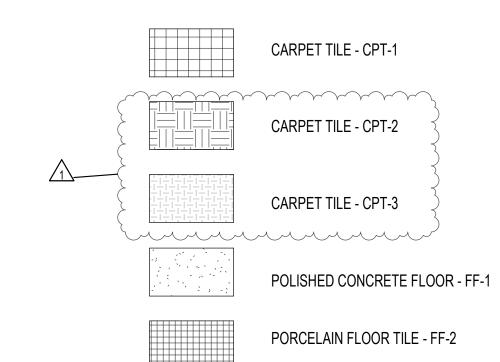

PROJECT TITLE

PETALUMA
REGIONAL
LIBRARY
RENOVATION
PROJECT NO.
10-19

100 FAIRGROUNDS DRIVE PETALUMA, CA 94952

DEDINT OF

| PERMIT SET | 11/20/2023 | N&T JOB NUMBER | 21824 |

REVISIONS

DATE DESCRIPTION

1 1/22/2024 RESUBMITTAL

REVIEWED FOR CODE COMPLIANCE

05/03/2024

Shums Coda Associates

SHEET TITLE

FINISH PLAN- 1ST FLOOR

SHEET NUMBER

A9.11

APPROVALS

2024 10:30:06 PM Autodesk Docs://Petaluma Library Refresh/PLR CENT

1 01 - FINISH PLAN - REFRESH

SECTION 06 41 00 - CASEWORK

HIGH PRESSURE LAMINATE:

WILSONART **PL-1:** MANUFACTURER: COLOR: **FUSION MAPLE** FINE VELVET FINISH:

SECTION 06 41 00 - COUNTERTOPS:

MANUFACTURER: QUARTZ PRODUCT: COLOR: SNOW FLURRY 3 CM THICKNESS:

SECTION 09 30 13 - CERAMIC/PORCELAIN TILING

CERAMIC WALL TILE:

STONE SOURCE **WT-1:** MANUFACTURER: STYLE: COLOR: LIGHT BLUE GLOSSY SIZE: 3" X 6" STACK BOND

CERAMIC WALL PANEL:

CROSSVILLE WT-2: MANUFACTURER: OSSIDO COLOR: VERDERAME 1M X 3M SIZE: THICKNESS: 3MM

PORCELAIN FLOOR TILE:

DALTILE **FF-2:** MANUFACTURER: STYLE: WANDERWISE COLOR: ROAM MATTE FINISH: 12" X 24" SIZE: PATTERN: **RUNNING BOND**

SECTION 09 68 00 - CARPETING

CHILDREN'S ACCENT CARPET:

CPT-1: MANUFACTURER: STYLE: **WOVEN GRADIENCE** COLOR: CARIBBEAN SIZE: 50CM X 50CM INSTALL: ASHLAR

TEEN AND COMPUTER AREA ACCENT CARPET:

CPT-2: MANUFACTURER: PATCRAFT STATIC NOISE STYLE: COLOR: JUNIPER SIZE: 9" X 36" INSTALL: BASKETWEAVE

_... **MAIN CARPET:** CPT-3:

MANUFACTURER: PATCRAFT STYLE: RUNNING STITCH COLOR: SHEER SIZE: 18" X 36"

BASKETWEAVE

09 84 13 - FIXED SOUND ABSORPTIVE PANELS

INSTALL:

AP-1: MANUFACTURER: **FSORB** COLOR: LIGHT BEIGE SIZE: 48" X 96" THICKNESS:

SECTION 09 90 00 - PAINTING AND COATING

TYPICAL INTERIOR PAINT FINISHES: CEILINGS & SOFFITS: EGGSHELL WALLS: EGGSHELL CORRIDOR WALLS: EGGSHELL TOILET ROOM, CUSTODIAL ROOM WALLS: SEMI-GLOSS PAINTED HM FRAMES: SEMI-GLOSS

INTERIOR PAINT COLORS:

P1: EGGSHELL- AT GYPSUM BD WALL - KELLY MOORE, CLOUD WHITE P2: SEMI-GLOSS - ABOVE CERAMIC TILE WAINSCOT AT RESTROOM P3: (NOT USED) P4: FLAT -AT GYPSUM CEILING

SECTION 10 21 13 - TOILET COMPARTMENTS

MANUFACTURER: BOBRICK DURALINE SERIES CGL, EXTENDED PRIVACY STYLE: FINISH: WILSONART, HIGHRISE

	ROOM FINISH SCHEDULE					
#	Name	Floor	Base	Wall	Ceiling	Comments
101	COMMUNITY ROOM	(E) TO REMAIN	(E) TO REMAIN	(E) TO REMAIN	(E) TO REMAIN	
101A	STORAGE	(E) TO REMAIN	(E) TO REMAIN	(E) TO REMAIN	(E) TO REMAIN	
101A 101B	KITCHENETTE	(E) TO REMAIN	(E) TO REMAIN	(E) TO REMAIN	(E) TO REMAIN	
1015	BOOKDROP	(E) TO REMAIN	(E) TO REMAIN	(E) TO REMAIN	(E) TO REMAIN	
103	FOYER	FF-1	WB-1	P1	(E) TO REMAIN	
104	WOMEN RESTROOM	FF-2	WT-1	WT-1 CERAMIC TILE		
104	WOWEN RESTROOM	ΓΓ- 2	VV 1 - 1	WAINSCOT, P2	(E) TO REMAIN, GB-1,P4	
105	MEN RESTROOM	FF-2	WT-1	WT-1 CERAMIC TILE WAINSCOT, P2	(E) TO REMAIN, GB-1,P4	
106	GN RR - ACS	FF-2	WT-1	WT-1 CERAMIC TILE WAINSCOT, P2	GB-1,P4	
107	GN RR - NON ACS	FF-2	WT-1	WT-1 CERAMIC TILE WAINSCOT, P2	GB-1,P4	
108	CUSTODIAL	(E) TO REMAIN	(E) TO REMAIN	(E) TO REMAIN	(E) TO REMAIN, GB-1,P4	REPAIR FINISHES IN KIND WHERE AFFECTED BY COILING DOOR WORK.
109A	MEDIA	CPT-#, SEE FINISH PLAN	WB-1	P1, (E) TO REMAIN AP-1	(E) TO REMAIN	
111	BOOKSTORE	CPT-#, SEE FINISH PLAN	(E) TO REMAIN	(E) TO REMAIN	(E) TO REMAIN	
112	BOOKSTORE STORAGE	(E) TO REMAIN	(E) TO REMAIN	(E) TO REMAIN	(E) TO REMAIN	
113	CHILDREN'S	CPT-#, SEE FINISH PLAN	WB-1	P1. (E) TO REMAIN, WD-1,	(E) TO REMAIN	REPAIR FINISHES IN KIND WHERE AFFECTED BY SKYLIGHT WORK
115	GN STAFF RR -ACS	FF-2	WT-1	WT -2 CERAMIC TILE WAINSCOT, P2	GB-1,P4	
116	GN STAFF RR - NON ACS	FF-2	WT-1	WT -2 CERAMIC TILE WAINSCOT, P2	GB-1,P4	
117	QUIET	CPT-#, SEE FINISH PLAN	WB-1	(E) TO REMAIN	(E) TO REMAIN, GB-1,P4	
118	STAFF LOUNGE	CPT-#, SEE FINISH PLAN	WB-1	P1	(E) TO REMAIN, GB-1,P4	
120	MEETING	CPT-#, SEE FINISH PLAN	WB-1	P1	(E) TO REMAIN, GB-1,P4	
121	OFFICE	CPT-#, SEE FINISH PLAN	WB-1	P1	(E) TO REMAIN, GB-1,P4	
122	STAFF	CPT-#, SEE FINISH PLAN	WB-1	P1	(E) TO REMAIN, GB-1,P4	
123	HISTORY ROOM	CPT-#, SEE FINISH PLAN	WB-1	P1	(E) TO REMAIN, GB-1,P4	
125	STORAGE	(E) TO REMAIN	(E) TO REMAIN	(E) TO REMAIN	(E) TO REMAIN, GB-1,P4	
126	STAIRWAY	(E) TO REMAIN	(E) TO REMAIN	(E) TO REMAIN	(E) TO REMAIN, WD-1	
127	SERVICE - REFERENCE	CPT-#, SEE FINISH PLAN	WB-1	P1, (E) TO REMAIN, AP-1	(E) TO REMAIN, GB-1,P4, WD-1	REPAIR FINISHES IN KIND WHERE AFFECTED BY SKYLIGHT WORK
128	TEEN AREA	CPT-#, SEE FINISH PLAN	WB-1	P1, (E) TO REMAIN, AP-1	(E) TO REMAIN, WD-1	REPAIR FINISHES IN KIND WHERE AFFECTED BY SKYLIGHT WORK
129	ADULT AREA	CPT-#, SEE FINISH PLAN	WB-1	P1, (E) TO REMAIN, AP-1	(E) TO REMAIN, WD-1	REPAIR FINISHES IN KIND WHERE AFFECTED BY SKYLIGHT WORK
130	ADULT AREA	CPT-#, SEE FINISH PLAN	WB-1	P1, (E) TO REMAIN	(E) TO REMAIN, WD-1	REPAIR FINISHES IN KIND WHERE AFFECTED BY SKYLIGHT WORK
131	COMPUTER AREA	CPT-#, SEE FINISH PLAN	WB-1	P1, (E) TO REMAIN	(E) TO REMAIN, WD-1	
132	DRINKING FOUNTAIN	FF-1	WT-2	WT-2	(E) TO REMAIN	

FINISH SCHEDULE LEGEND

DESCRIPTION

<u>TYPE</u>	
AP-1	WALL MOUNTED ACOUSTICAL PANEL
FF-1	POLISHED CONCRETE FLOOR -SEE SPEC SECTION 03 35 44.
	STATIC COEFFICIENT OF FRICTION TO ANSI/NFSI B101.1, DRY SURFACE: 0.80 AND WET: 0.74
FF-2	PORCELAIN FLOOR TILE -SEE SPEC SECTION
CPT-1	CARPET FLOOR TILE, COLOR 1 -SEE SPEC SECTION 09 68 13.
CPT-2	CARPET FLOOR TILE, COLOR 2 -SEE SPEC SECTION 09 68 13.
CPT-3	CARPET FLOOR TILE, COLOR 3 -SEE SPEC SECTION 09 68 13.
WB -1	WOOD BASE, 3" HIGH, FIT HEIGHT -WOOD SPECIES AND FINISH TO MATCH EXISTING
WT-1	CERAMIC WALL TILE WAINSCOT -SUBWAY TILE 3X6 -SEE SPEC SECTION 09 30 00.
WT-2	CERAMIC WALL PANEL - SEE SPEC SECTION 09 30 00.
P1	EGGSHELL -OVER WOOD SIDING -BELOW 10'-0"; SEE INTERIOR ELEVATION AND FINISH PLAN FOR LOCATION AND EXTENT
P2	EGGSHELL -OVER GYPSUM WALL -BELOW 10'-0"; SEE INTERIOR ELEVATION AND FINISH PLAN FOR LOCATION AND EXTENT
P3	SEMI-GLOSS -GYPSUM WALL -ABOVE CERAMIC TILE WAINSCOT
P4	FLAT -GYPSUM CEILING
GB-1	5/8" GYPSUM BOARD - LEVEL 4
WD-1	4" WIDE T&G WOOD SIDING - STAIN/SPECIES TO MATCH IF REPLACED WITH NEW SIDING DUE TO FIRE SPRINKLER WORK
	SALVAGE EXISTING T&G WOOD SIDING FOR RE- INSTALLATION AND REFINISH AS REQUIRED TO MATCH EXISTING
	ADJACENT. UNDER T&G SIDING, REPLACE THE BACKING GYP BD AND 2X STRIPPING.

1. WHERE EXISTING GYPSUM CEILING IS WATERSTAINED, REPLACE SECTION OF GYPSUM BOARD TO NEAREST BLOCKING LOCATION. FOR PEELING PAINT, PROVIDE REMOVAL AND PREP SUBSTRATE PRIOR TO PAINTING

2. REFER TO INTERIOR ELEVATION FOR ACOUSTICAL PANELS MOUNTED ON WALL OR CEILINGS 3. NEW INTERIOR FINISHES SHALL COMPLY WITH CBC SECTION 803 TABLE 803.11, CLASS C FOR ROOMS AND ENCLOSED SPACES.

4. SELECTED ACOUSTICAL WALL MATERIAL IS CLASS A. HAS FLAME SPREAD OF LESS THAN 25, ASTME E84, INCLUDING CORE AND


SELECTED FABRIC. MATERIAL PER TABLE 803.11 ALLOWS CLASS C.

5. WHERE EXISTING FINISHES ARE AFFECTED BY SCOPE OF WORK, REPAIR FINISHES IN KIND. 6. REFER TO FIRE SPRINKLER FOR SCOPE OF WORK. WALL AND CEILING FINISHES TO BE REPAIRED IN KIND. PROVIDE BLOCKING AS SHOWN ON FIRE SPRINKLER. CONTRACTOR TO COORDINATE AND REVIEW WITH ARCHITECT THE LOCATIONS OF KNEE BRACE AT WALLS. PRIOR TO INSTALLATION.

7. WHERE EXISTING EXTERIOR WOOD IS AFFECTED BY SCOPE, STAIN AND SEAL TO MATCH EXISTING.

ARCHITECTS

729 Heinz Avenue Berkeley, CA 94710 tel 510.542.2200 fax 510.542.2201

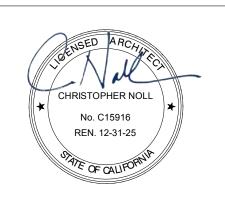

PROJECT TITLE

SONOMA COUNTY PETALUMA REGIONAL LIBRARY RENOVATION PROJECT NO.

100 FAIRGROUNDS DRIVE PETALUMA, CA 94952

PERMIT SET

ISSUE DATE 11/20/2023 N&T JOB NUMBER REVISIONS DESCRIPTION

1 1/22/2024 RESUBMITTAL

REVIEWED FOR CODE COMPLIANCE 05/03/2024


Shums Coda Associates


SHEET TITLE

FINISH SCHEDULE

SHEET NUMBER

A9.13

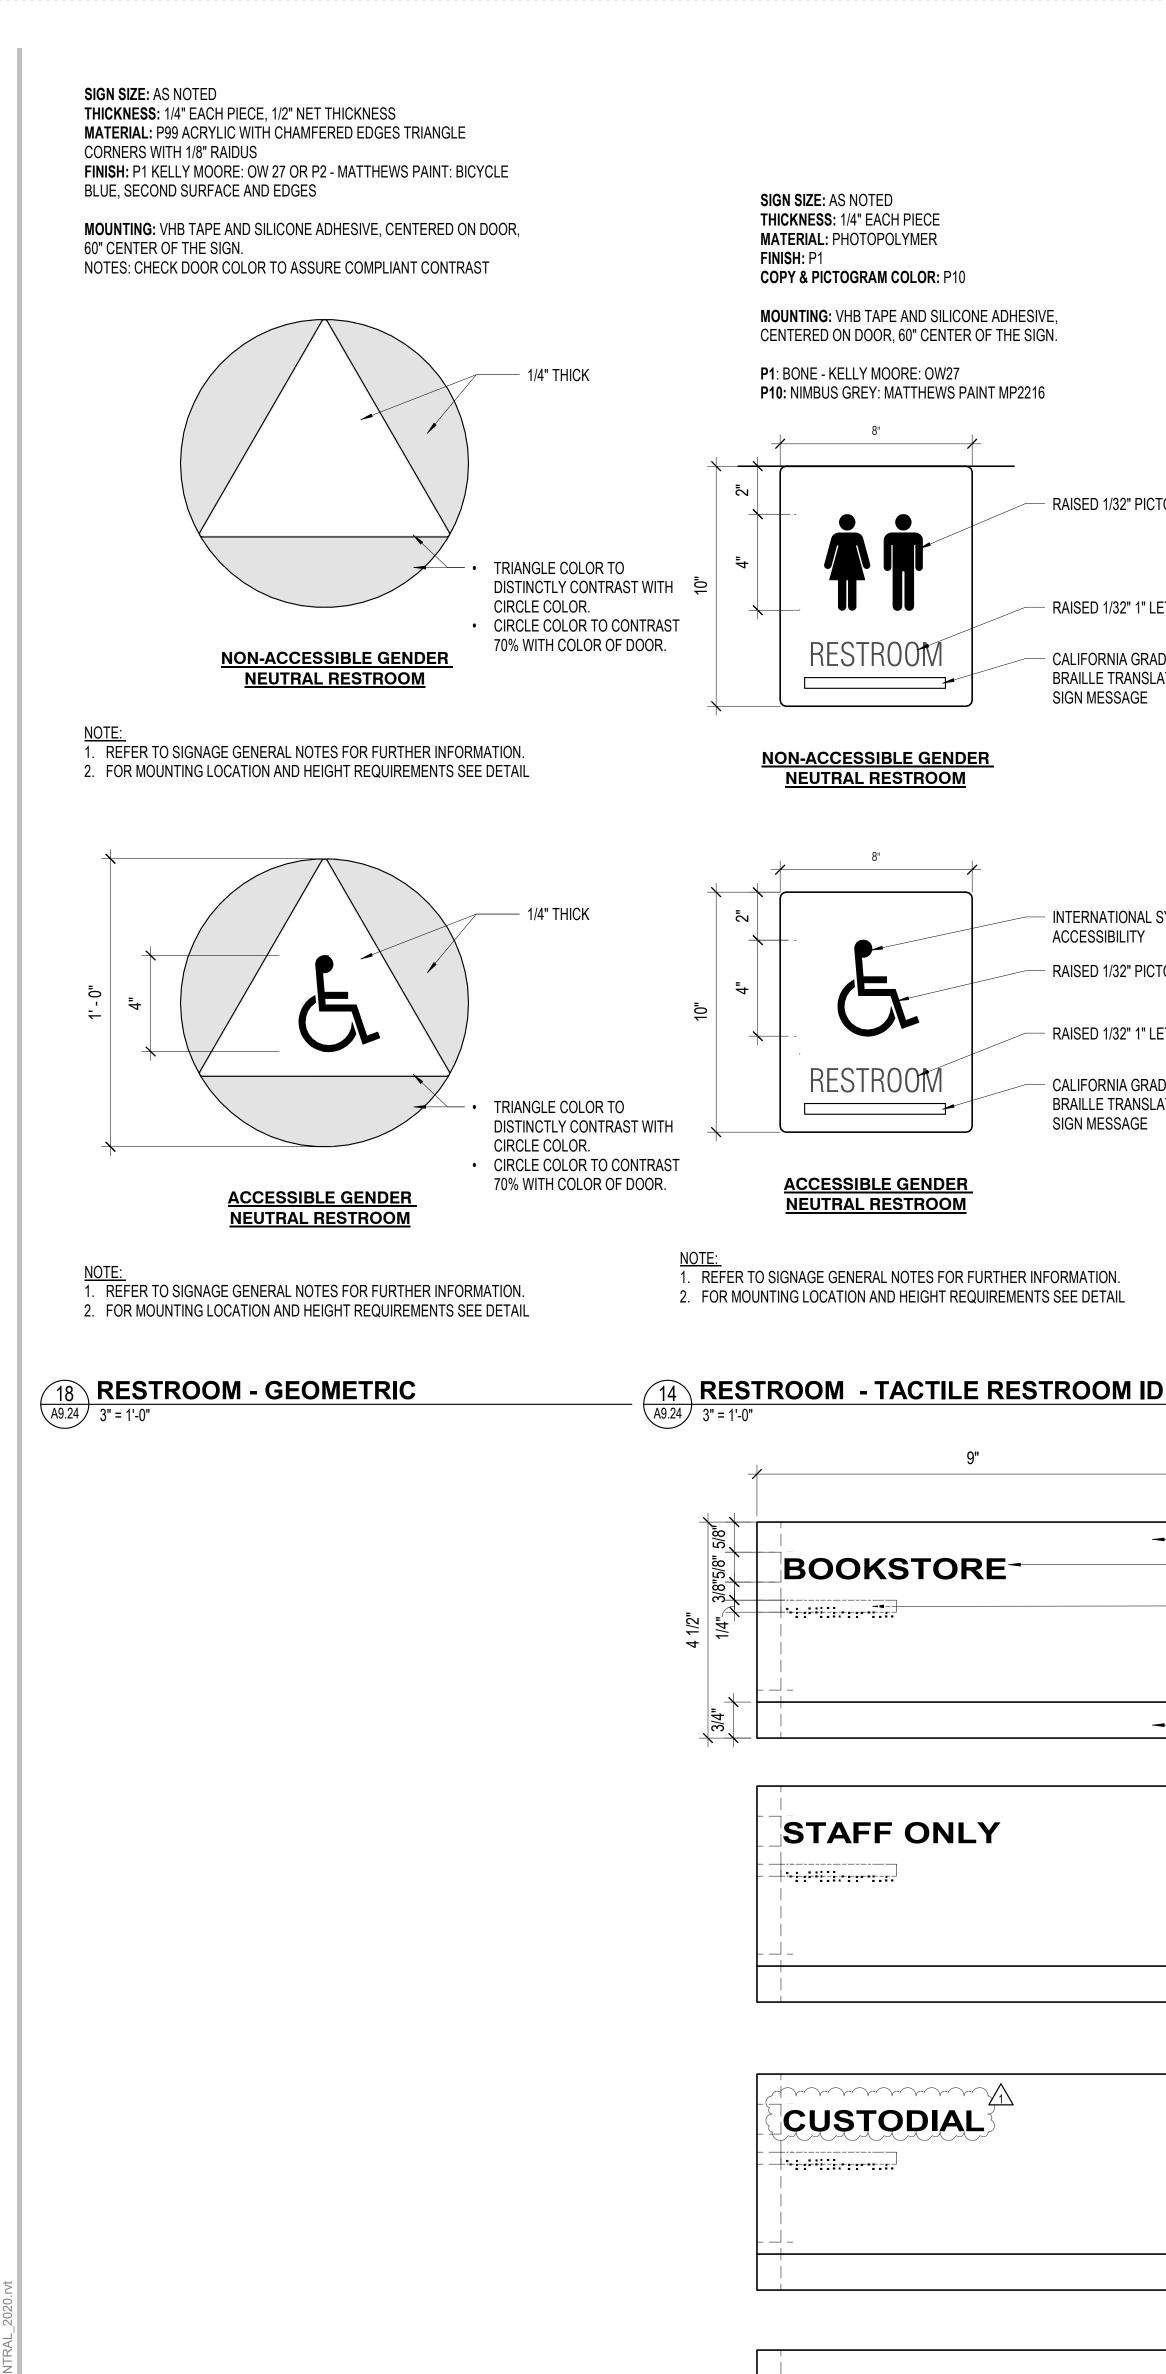

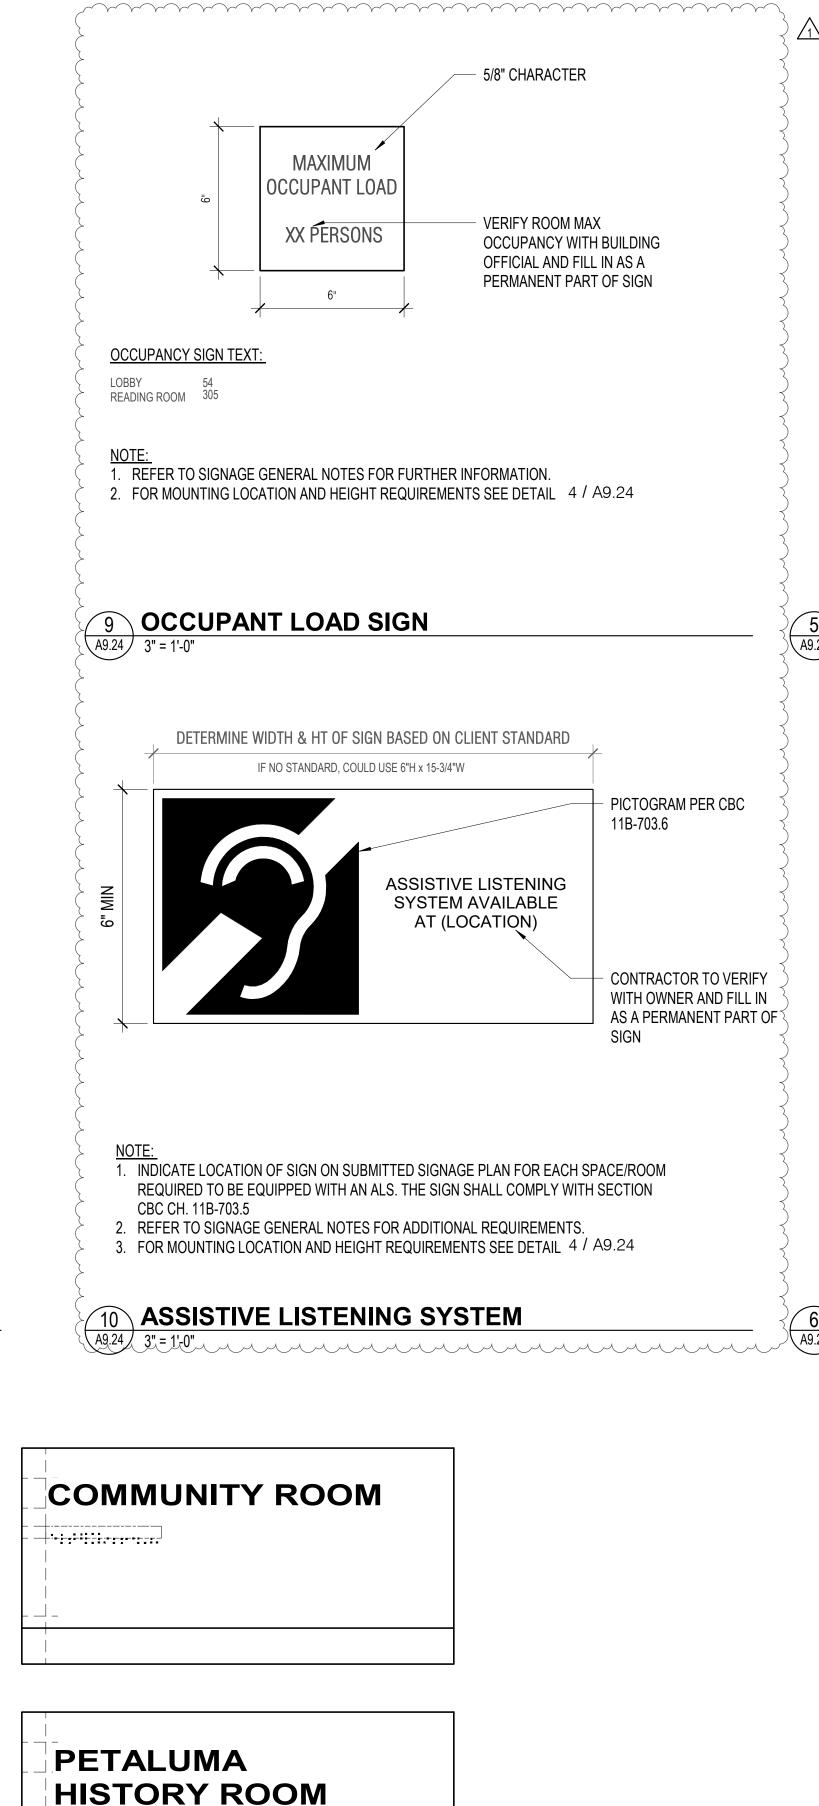

SIGN SIZE: 8" X 4"

THICKNESS: 1/8"

FONT SIZES: 3/4"

ADHESIVE

SURFACE AND EDGES

TACTILE COPY & BRAILLE:

MATERIAL: PHOTOPOLYMER

FINISH: KELLY MOORE - TBD ON FIRST

COPY COLOR: MATTHEWS PAINT - TBD

RAISED 1/32" PICTOGRAM

RAISED 1/32" 1" LETTERING

CALIFORNIA GRADE #2

SIGN MESSAGE

BRAILLE TRANSLATION OF

INTERNATIONAL SYMBOL OF

RAISED 1/32" PICTOGRAM

RAISED 1/32" 1" LETTERING

CALIFORNIA GRADE #2

SIGN MESSAGE

BRAILLE TRANSLATION OF

OF DOOR.

STUDY ROOM #


STAFF ROOM


MOUNT WITH VHB TAPE AND SILICONE ADHESIVE

60" AFF TO BOTTOM EDGE OF TACTILE LETTERING AND 6" FROM STRIKE SIDE

GLASS MOUNT: 3M VINYL ON FIRST SURFACE TO HIDE VHB TAPE AND ADHESIVE

ACCESSIBILITY

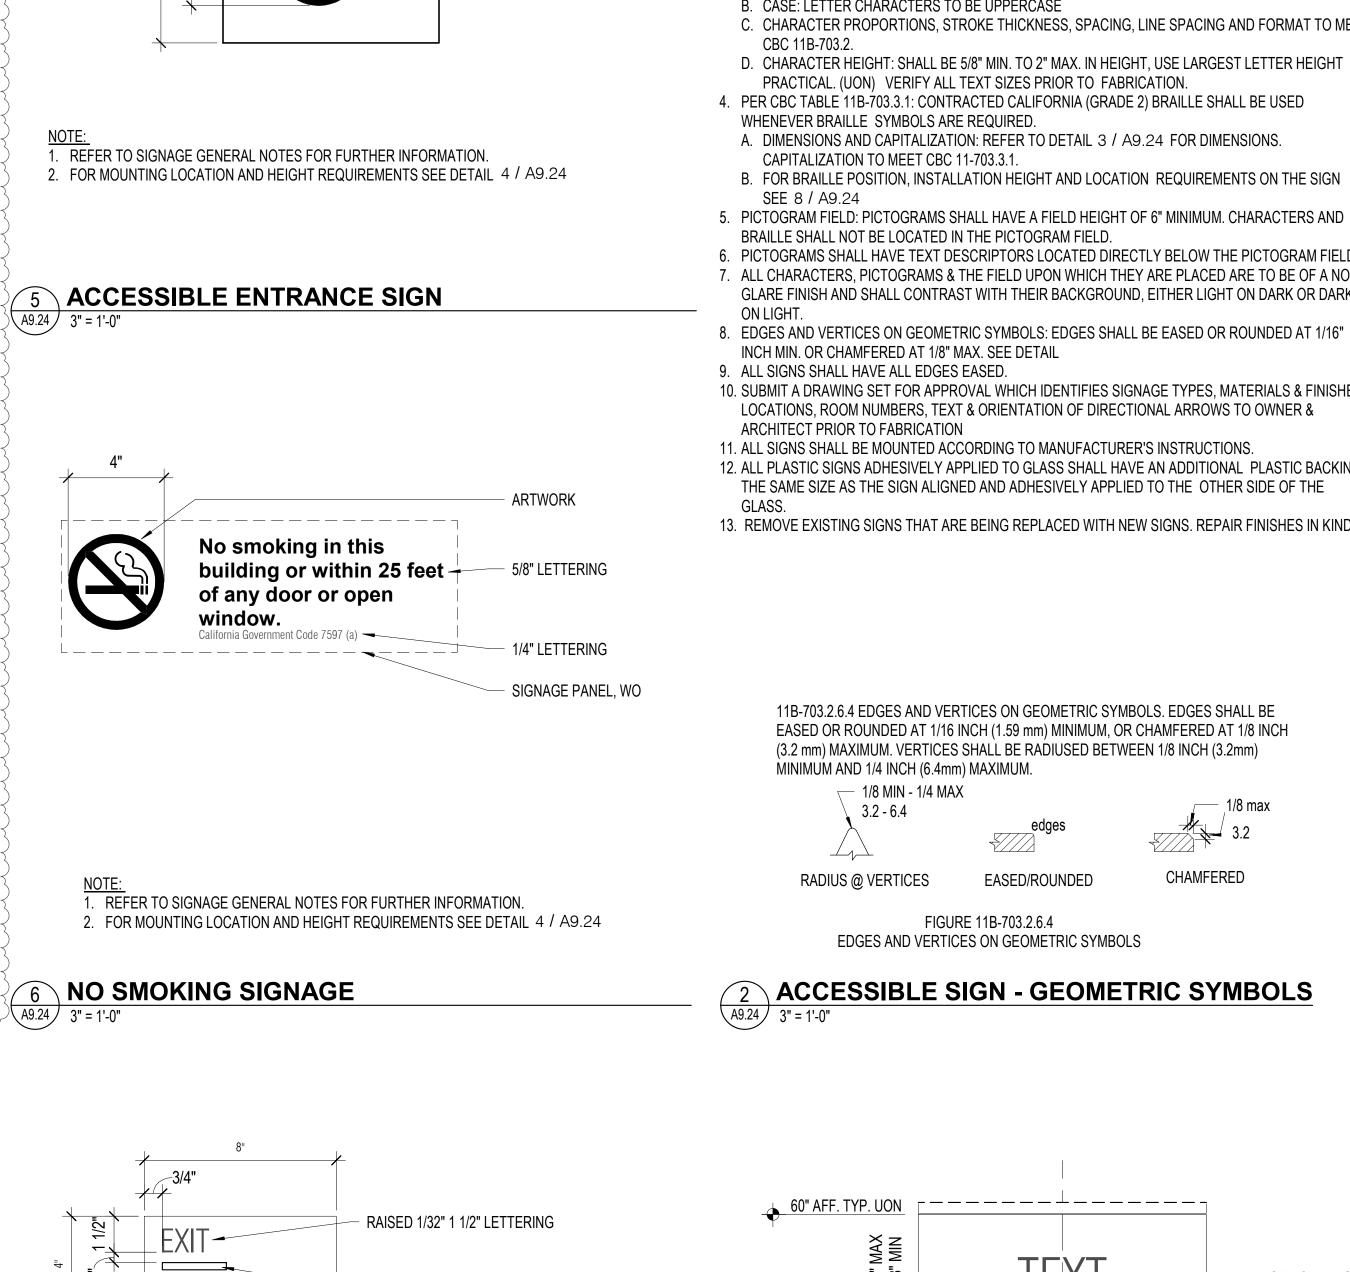

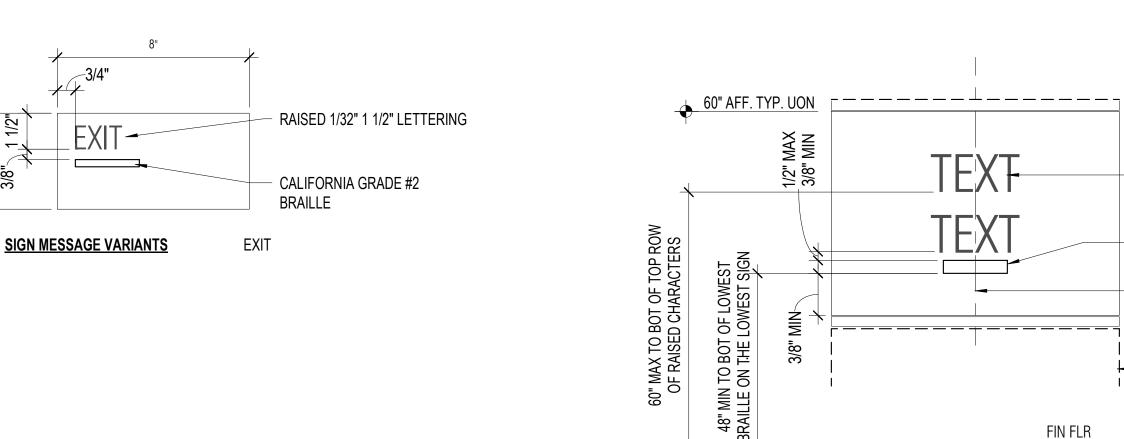

SIGNAGE GENERAL NOTES

PER DETAIL 3 / A9.24

A. DEPTH: RAISED 1/32"

CBC 11B-703.2.

11B-703.4.

ON LIGHT.

2. ALL INTERIOR SIGNS SHALL BE 1/8" THICK MINIMUM. (UON)

B. CASE: LETTER CHARACTERS TO BE UPPERCASE

WHENEVER BRAILLE SYMBOLS ARE REQUIRED.

CAPITALIZATION TO MEET CBC 11-703.3.1.

INCH MIN. OR CHAMFERED AT 1/8" MAX. SEE DETAIL

MINIMUM AND 1/4 INCH (6.4mm) MAXIMUM.

─ 1/8 MIN - 1/4 MAX

RADIUS @ VERTICES

ALL SIGNS SHALL HAVE ALL EDGES EASED.

ARCHITECT PRIOR TO FABRICATION

BRAILLE SHALL NOT BE LOCATED IN THE PICTOGRAM FIELD.

PICTOGRAM INTERNATIONAL

SYMBOL OF ACCESSIBLITY

PER CBC 11B-703.6

1. WHERE PERMANENT IDENTIFICATION IS PROVIDED FOR ROOMS AND SPACES. SIGNS SHALL BE

INSTALLED ON THE WALL ADJACENT TO THE LATCH SIDE OF THE DOOR. WHERE THERE IS NO WALL

SPACE TO THE LATCH SIDE OF THE DOOR, SIGNS SHALL BE PLACED ON THE NEAREST ADJACENT

WALL. WHERE A TACTILE SIGN IS PROVIDED AT DOUBLE DOORS WITH ONE ACTIVE LEAF THE SIGN

SHALL BE LOCATED ON THE INACTIVE LEAF. WHEN THERE ARE TWO ACTIVE LEAVES, THE SIGN SHALL

BE LOCATED TO THE RIGHT OF THE RIGHT-HAND DOOR. MOUNTING LOCATION FOR SUCH SIGNAGE

PROTRUDING OBJECTS OR STANDING WITHIN THE SWING OF A DOOR. MOUNTING HEIGHT SHALL BE

SHALL BE SO THAT A PERSON MAY APPROACH WITHIN 3" OF SIGNAGE WITHOUT ENCOUNTERING

3. RAISED CHARACTERS: ALL TACTILE SIGNS (SIGNS WHICH INCLUDE BRAILLE) SHALL HAVE THE SIGN

WITH CBC 11B-703.3. RAISED CHARACTERS SHALL BE INSTALLED IN ACCORDANCE WITH CBC

LETTERING THAT COMPLY WITH CBC 11B-703.2 AND SHALL BE DUPLICATED IN BRAILLE COMPLYING

C. CHARACTER PROPORTIONS, STROKE THICKNESS, SPACING, LINE SPACING AND FORMAT TO MEET

D. CHARACTER HEIGHT: SHALL BE 5/8" MIN. TO 2" MAX. IN HEIGHT, USE LARGEST LETTER HEIGHT

B. FOR BRAILLE POSITION, INSTALLATION HEIGHT AND LOCATION REQUIREMENTS ON THE SIGN

5. PICTOGRAM FIELD: PICTOGRAMS SHALL HAVE A FIELD HEIGHT OF 6" MINIMUM. CHARACTERS AND

6. PICTOGRAMS SHALL HAVE TEXT DESCRIPTORS LOCATED DIRECTLY BELOW THE PICTOGRAM FIELD.

7. ALL CHARACTERS, PICTOGRAMS & THE FIELD UPON WHICH THEY ARE PLACED ARE TO BE OF A NON-

GLARE FINISH AND SHALL CONTRAST WITH THEIR BACKGROUND, EITHER LIGHT ON DARK OR DARK

10. SUBMIT A DRAWING SET FOR APPROVAL WHICH IDENTIFIES SIGNAGE TYPES, MATERIALS & FINISHES,

12. ALL PLASTIC SIGNS ADHESIVELY APPLIED TO GLASS SHALL HAVE AN ADDITIONAL PLASTIC BACKING

THE SAME SIZE AS THE SIGN ALIGNED AND ADHESIVELY APPLIED TO THE OTHER SIDE OF THE

13. REMOVE EXISTING SIGNS THAT ARE BEING REPLACED WITH NEW SIGNS. REPAIR FINISHES IN KIND.

11B-703.2.6.4 EDGES AND VERTICES ON GEOMETRIC SYMBOLS. EDGES SHALL BE

(3.2 mm) MAXIMUM. VERTICES SHALL BE RADIUSED BETWEEN 1/8 INCH (3.2mm)

EASED OR ROUNDED AT 1/16 INCH (1.59 mm) MINIMUM, OR CHAMFERED AT 1/8 INCH

EASED/ROUNDED

ACCESSIBLE SIGN - GEOMETRIC SYMBOLS

REFER TO SIGNAGE GENERAL NOTES FOR ADDITIONAL INFO

CLEAR FLR

SPACE & TACTILE

TACTILE SIGNAGE MOUNTING HT

DOOR &

SYMBOL

FIGURE 11B-703.2.6.4 EDGES AND VERTICES ON GEOMETRIC SYMBOLS CHAMFERED

RAISED CHARACTERS

CENTER TEXT AND

BRAILLE ON SIGN

BRAILLE

CENTERED ON TACTILE

DOOR MOUNTED/TOILET RM ID

MENS- EQUILATERAL TRIANGLE

UNISEX-TRIANGLE ON CIRCLE

TACTILE ID SIGN (w/ PICTOGRAM

AT TOILET RM). FOR MOUNTING

WHEN MULTIPLE SIGNS OCCUR

ALIGN ALONG THE CENTER LINE.

CHARACTER MIN. & MAX. HEIGHT

PLACE ALL TACTILE SIGNS

WITHIN TACTILE & RAISED

HEIGHT REQUIREMENTS SEE 3 / A9.24

WOMENS- 12" DIA CIRCLE;

CHARACTERS

12" LONG EDGES;

SYMBOL:

LIMITS

LOCATIONS, ROOM NUMBERS, TEXT & ORIENTATION OF DIRECTIONAL ARROWS TO OWNER &

11. ALL SIGNS SHALL BE MOUNTED ACCORDING TO MANUFACTURER'S INSTRUCTIONS.


4. PER CBC TABLE 11B-703.3.1: CONTRACTED CALIFORNIA (GRADE 2) BRAILLE SHALL BE USED

A. DIMENSIONS AND CAPITALIZATION: REFER TO DETAIL 3 / A9.24 FOR DIMENSIONS.

PRACTICAL. (UON) VERIFY ALL TEXT SIZES PRIOR TO FABRICATION.

1. REFER TO SIGNAGE GENERAL NOTES FOR FURTHER INFORMATION. 4 / A9.24 2. FOR MOUNTING LOCATION AND HEIGHT REQUIREMENTS SEE DETAIL 3. FINAL TEXT TBD. FINAL REVIEW PRIOR TO FABRICATION.

SIGNAGE - TACTILE EXIT

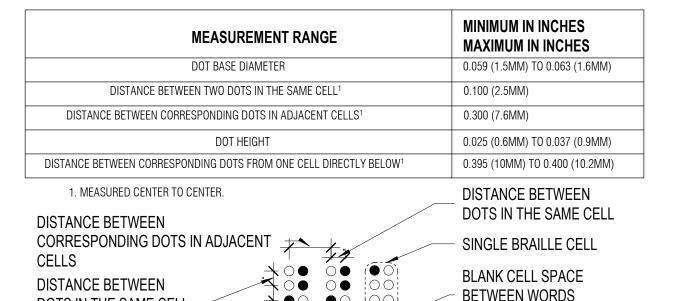

BRAILLE: CALIFORIA CONTRACTED GRADE 2 **BRAILLE COLOR:** KELLY MOORE - TBD DOTS IN THE SAME CELL **★●○ ●○ MOUNTING:** VHB TAPE AND SILICONE DISTANCE BETWEEN + 00 (00) 00/ CORRESPONDING DOTS FIGURE 11B-703.3.1 FROM ONE CELL DIRECTLY

BRAILLE MEASUREMENT

58' 60" **4 SIGNAGE AT DOORS** A9.24 3/8" = 1'-0"

ARCHITECTS

729 Heinz Avenue Berkeley, CA 94710 tel 510.542.2200 fax 510.542.2201

CHRISTOPHER NOLL No. C15916 REN. 12-31-25

PROJECT TITLE

SONOMA COUNTY PETALUMA REGIONAL LIBRARY RENOVATION PROJECT NO.

100 FAIRGROUNDS DRIVE PETALUMA, CA 94952

PERMIT SET

ISSUE DATE

N&T JOB NUMBER REVISIONS DESCRIPTION STACKED TACTILE SIGNS, VO 1 1/22/2024 RESUBMITTAL

> EVIEWED FOR CODE COMPLIANCE 05/03/2024 Shums Coda Associates

SHEET TITLE SIGNAGE DETAILS

SHEET NUMBER

APPROVALS

A9.24

BETWEEN WORDS RAISED DOT BASE DIAMETER

NO RAISED DOT

SIGNAGE - TACTILE ROOM ID

C. .25" GRADE II CONTRACTED BRAILLE

D. EXTERIOR GRADE PAINT, COLOR TBD


STORAGE

A. .25" EXTERIOR GRADE PHOTOPOLYMER WITH SURFACE 1 EXTERIOR-GRADE

B. TACTILE LETTERING WITH SILKSCREEN EXTERIOR - GRADE BLACK PAINT

WHITE PAINT.

ACCESSIBLE SIGN - BRAILLE DIMENSIONS

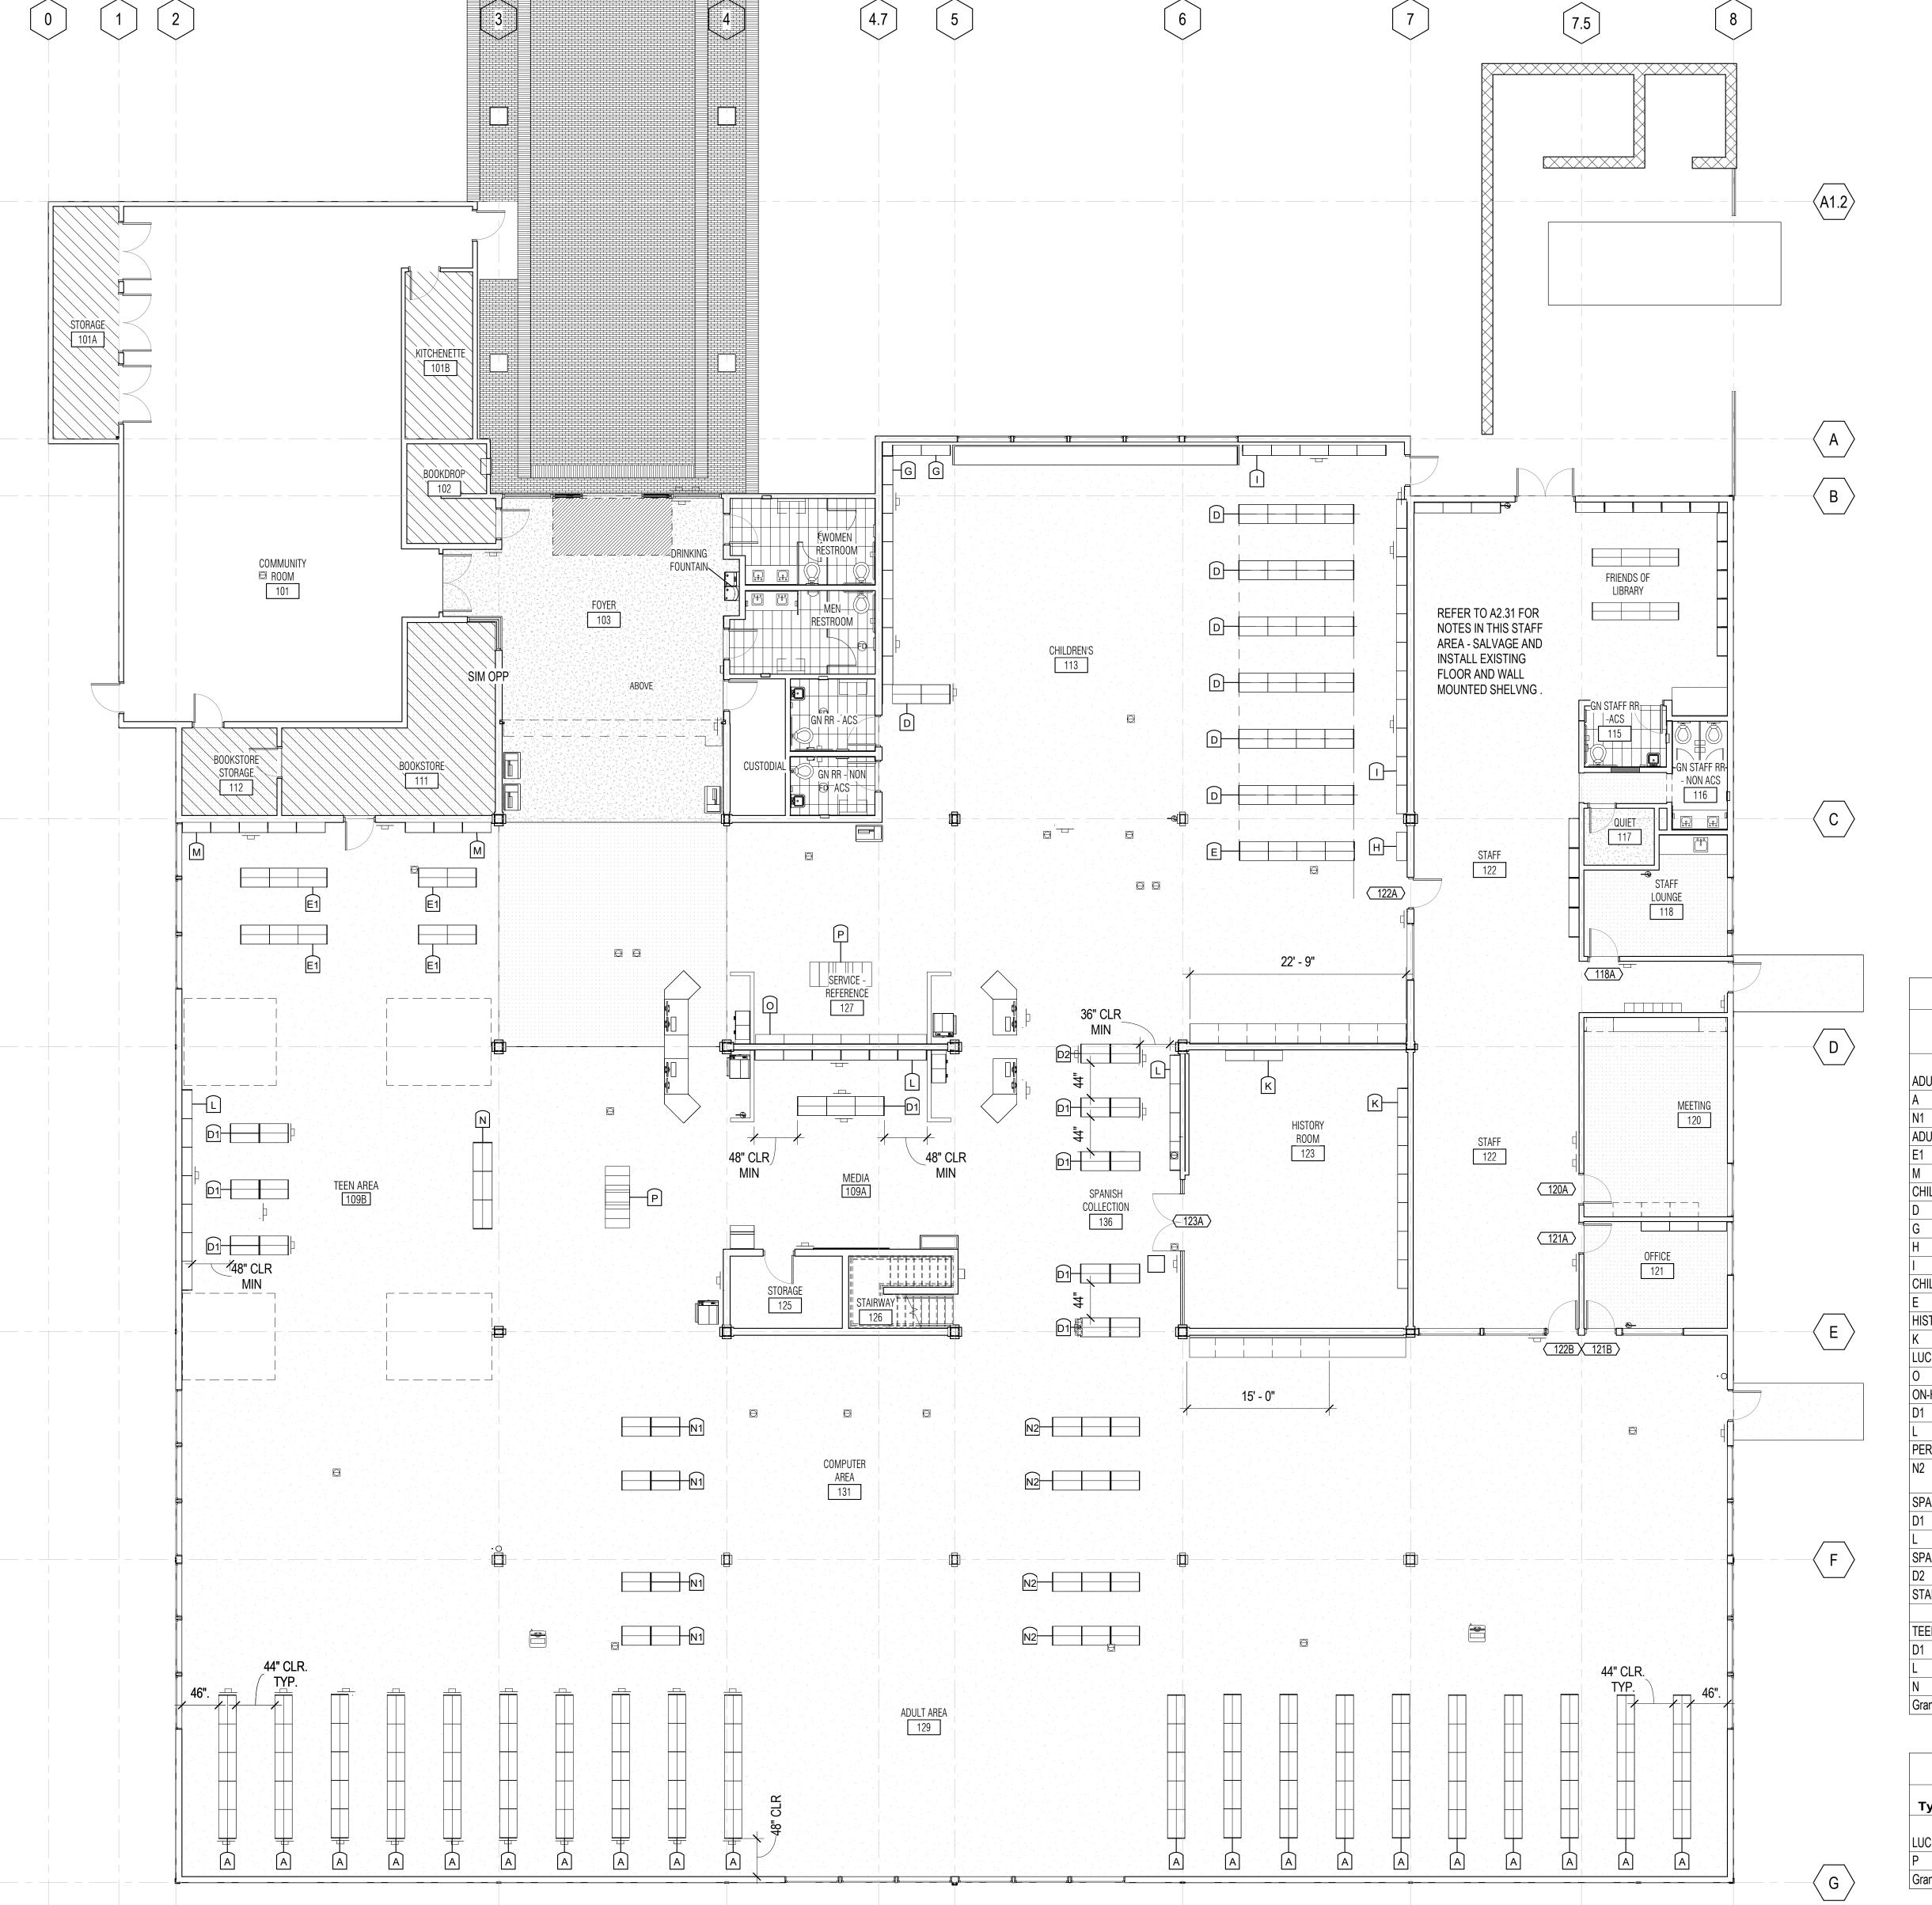

GENERAL NOTES

- 1. SHELVING TO BE BY SHELVING CONTRACTOR. COORDINATE WORK WITH
- CONTRACTOR.
- 2. SEE A9.42 FOR TYPICAL SHELVING DETAILS 3. SEE 11/G3.21 FOR TYPICAL SHELVING LAYOUT REQUIREMENTS.
- 4. LIBRARY WILL HAVE STAFF AT SERVICE DESK TO ASSIST PATRONS TO REACH MATERIALS ON HIGH SHELVES. 5. FOR DOUBLE FACE SHELVING UNITS - THE EXISTING SALVAGED WHITE PANELS
- IS TO BE RE-INSTALLED ONTO 90" SHELVING UNITS. QUANTITY TO BE VERIFIED BY SHELVING CONTRACTOR. 6. SHELVING TO BE ANCHORED TO FLOOR OR WALL U.O.N. UNITS WITH HEIGHTS
- BELOW 60" DO NOT NEED TO BE ANCHORED DOWN. 7. MOBILE UNITS NOT TO EXCEED 4 SHELVING UNIT HIGH.
- 8. PROVIDE PLAM END PANELS AND CANOPY TOP UNITS 42"-66" HIGH. CANOPY
- TOPS NOT REQUIRED FOR 90" UNITS. 9. WHERE SHELVING UNITS ARE INSTALLED ON WALL BETWEEN (E) COLUMNS, FIELD VERIFY LENGTHS

LEGEND

SHELVING TYPE ID

		LIB	RARY S	TACK S	YSTEM	- SHELVING	SPECIFICATIONS
wt	Qty	Shelf Count	Height	Width	Depth	Adjustable Shelf Depth	Type Comments
	'				1	1	
ADULT	400		- 1 011	01 011	41. 40"	01 4411	Daupi E
<u>A</u>	100	6	7' - 6"	3' - 0"	1' - 10"	0' - 11"	DOUBLE
N1	8	3	3' - 9"	3' - 0"	2' - 0"	0' - 11"	MOBILE
ADULT - ME		1_	41 011	0. 0.	0. 0.		
E1	10	5	4' - 6"	3' - 0"	2' - 0"	0' - 11"	DOUBLE - MOBILE- PULLOUT BROWSING BOX
М	8	7	7' - 6"	3' - 0"	1' - 1"	0' - 9"	SINGLE - PULLOUT BROWSNG BOX
CHILDREN'S		Τ.	Ι.	Ι.	T.	T	
D	26	4	4' - 6"	3' - 0"	2' - 0"	0' - 11"	DOUBLE
G	10	4	4' - 6"	3' - 0"	1' - 1"	0' - 9"	SINGLE
Н	1	3	5' - 6"	3' - 0"	1' - 1"	0' - 4"	SINGLE - PERIODICAL DISPLAY BACK SHELF
1	16	5	5' - 6"	3' - 0"	1' - 1"	0' - 9"	SINGLE
CHILDREN'S	S - MEDI	A					
E	4	4	4' - 6"	3' - 0"	2' - 0"	0' - 11"	DOUBLE - MOBILE- PULLOUT BROWSING BOX
HISTORY							
K	9	4	7' - 6"	3' - 0"	1' - 1"	0' - 9"	SINGLE
LUCKY DAY	DISPLA	Υ	1		1		
0	6		7' - 0"	3' - 0"	1' - 0"		SINGLE-SIDED
ON-HOLD		1	1	1	1	1	1
D1	3	4	5' - 0"	3' - 0"	2' - 0"	0' - 11"	DOUBLE - MOBILE
L	6	6	7' - 6"	3' - 0"	1' - 1"	0' - 9"	SINGLE
PERIODICA	LS		I	I	1		
N2	12	3	3' - 9"	3' - 0"	2' - 0"	0' - 11"	PERIODICAL DISPLAY BACK SHELF - DOUBLE MOBILE
SPANISH	'						
D1	8	4	5' - 0"	3' - 0"	2' - 0"	0' - 11"	DOUBLE - MOBILE
L	4	6	7' - 6"	3' - 0"	1' - 1"	0' - 9"	SINGLE
SPANISH - I	MEDIA	1	1	1	1	1	
D2	2	4	5' - 0"	3' - 0"	2' - 0"	0' - 11"	DOUBLE - MOBILE- PULLOUT BROWSING BOX
STAFF	1	1	1	1	1	1	1
	4	6	7' - 6"	3' - 0"	1' - 1"	0' - 9"	SINGLE
TEEN		I	_		1		1
D1	6	4	5' - 0"	3' - 0"	2' - 0"	0' - 11"	DOUBLE - MOBILE
<u>- · </u>	7	6	7' - 6"	3' - 0"	1' - 1"	0' - 9"	SINGLE
N	3	3	3' - 9"	3' - 0"	2' - 0"	0' - 11"	DOUBLE - MOBILE

				LIBRARY	MISCELLANEOUS	
Type ID	Qt y	Height	Depth	Width	Type Comments	
LUCKY DAY E)ISPL	AY				
)	2				MOBILE - TIER DISPLAY	
Grand total: 2						

ARCHITECTS

729 Heinz Avenue Berkeley, CA 94710 tel 510.542.2200 fax 510.542.2201



PROJECT TITLE

SONOMA COUNTY **PETALUMA REGIONAL LIBRARY RENOVATION** PROJECT NO.

100 FAIRGROUNDS DRIVE PETALUMA, CA 94952

PERMIT SET

ISSUE DATE N&T JOB NUMBER REVISIONS DATE DESCRIPTION


> REVIEWED FOR CODE COMPLIANCE 05/03/2024


> > Shums Coda Associates

SHELVING PLAN - 1ST **FLOOR**

SHEET NUMBER


A9.41

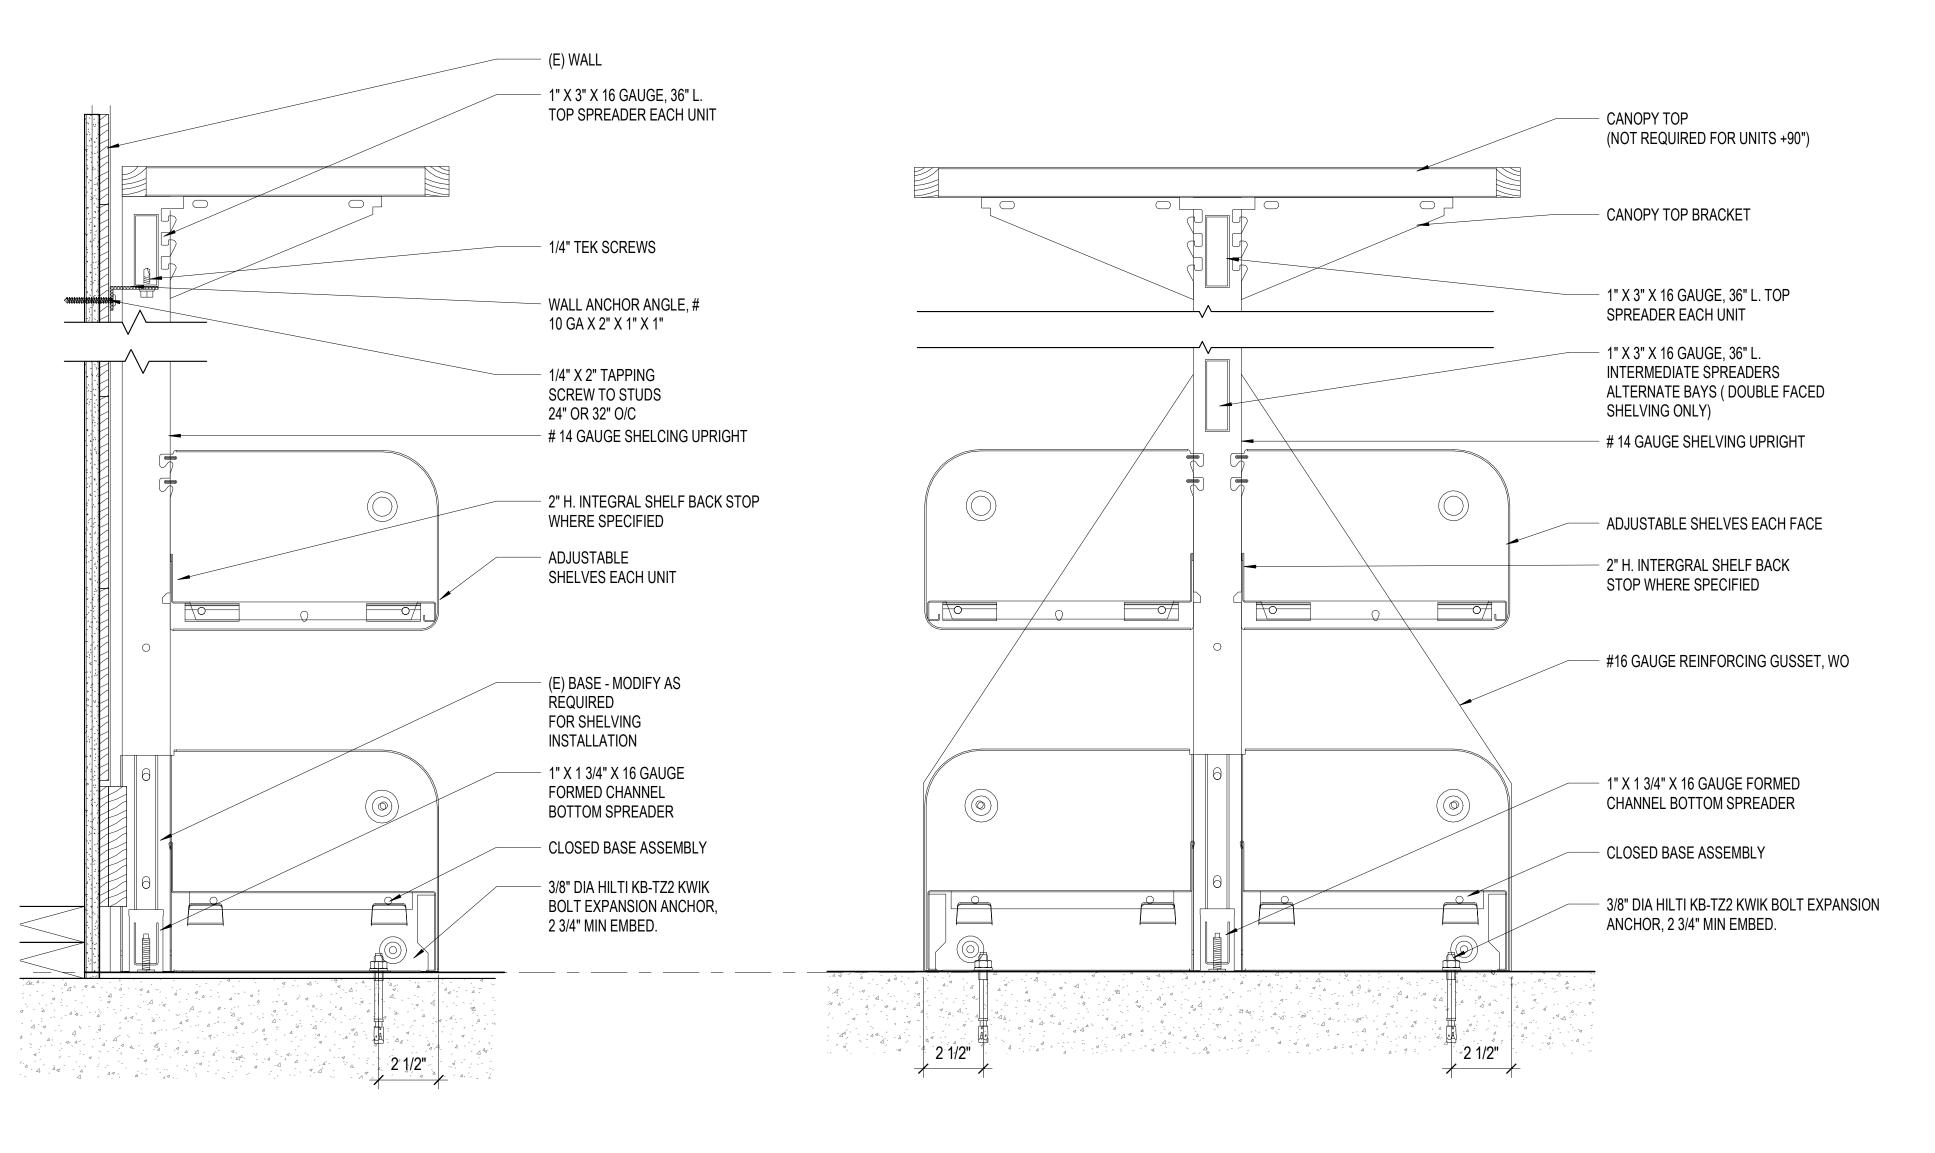

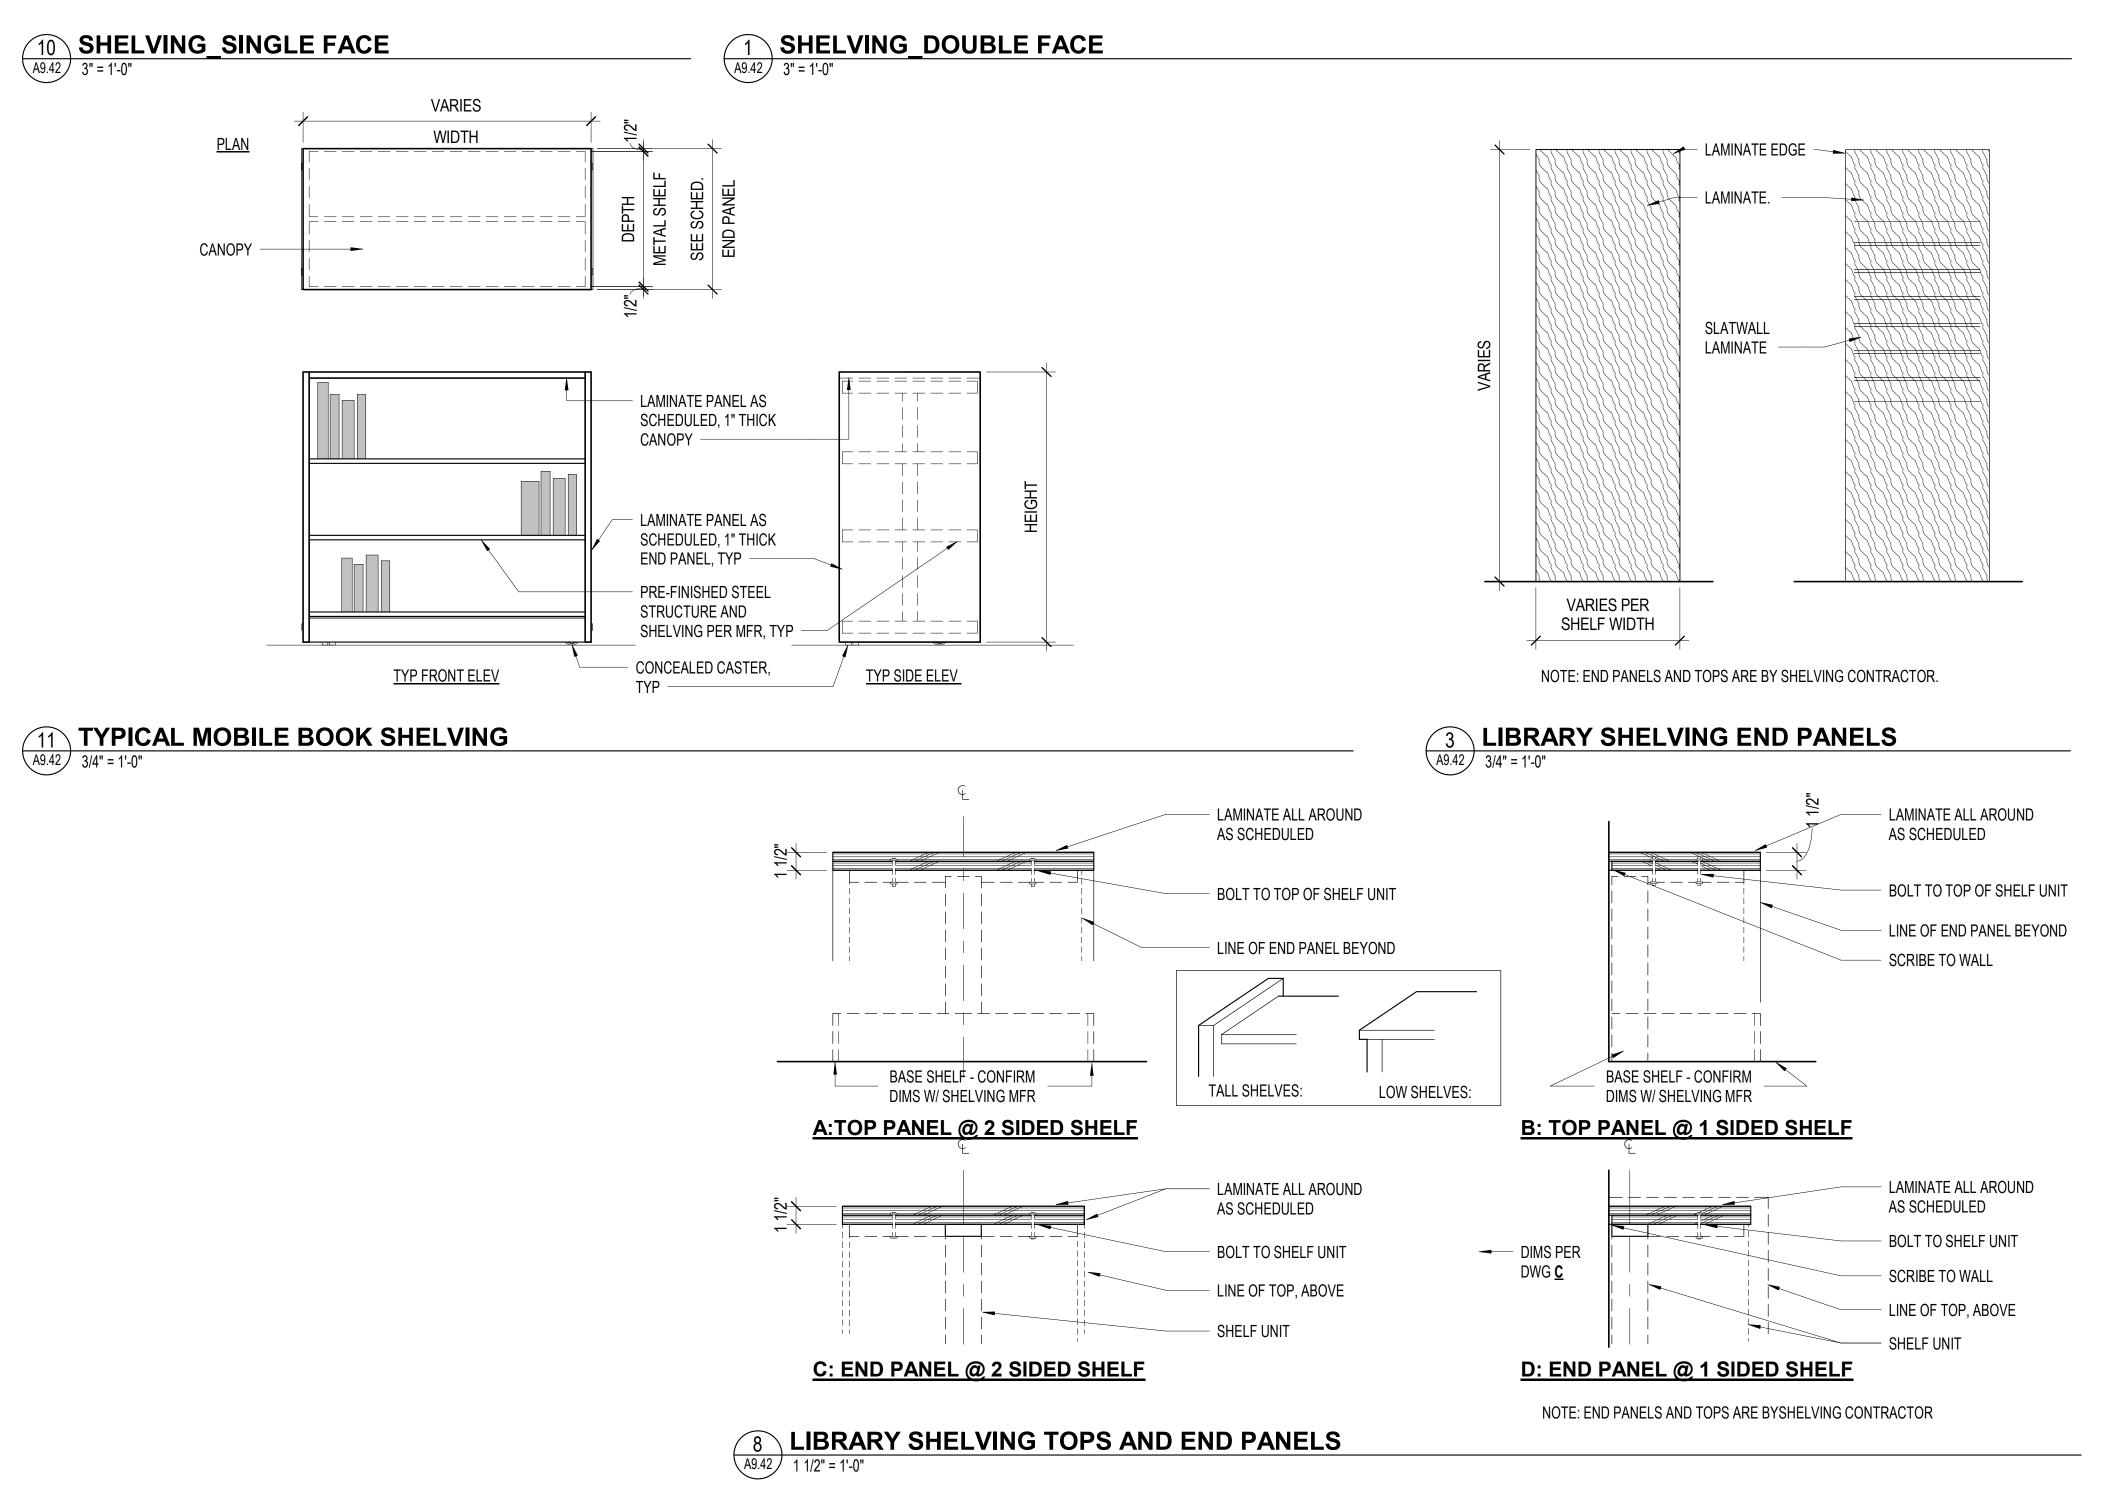

NOLL & TAM ARCHITECTS

> 729 Heinz Avenue Berkeley, CA 94710 tel 510.542.2200 fax 510.542.2201

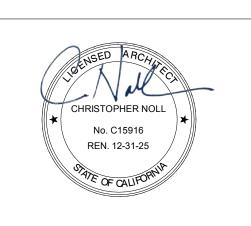

SEAL

PROJECT TITLE

PETALUMA
REGIONAL
LIBRARY
RENOVATION
PROJECT NO.
10-19

100 FAIRGROUNDS DRIVE PETALUMA, CA 94952

PERMIT SET

ISSUE DATE 11/27/202

N&T JOB NUMBER 2182

REVISIONS

DATE DESCRIPTION

REVIEWED FOR CODE COMPLIANCE


05/03/2024

Shums Coda Associates

SHEET TITLE
SHELVING DETAILS

SHEET NUMBER


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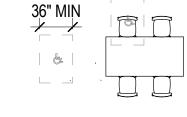


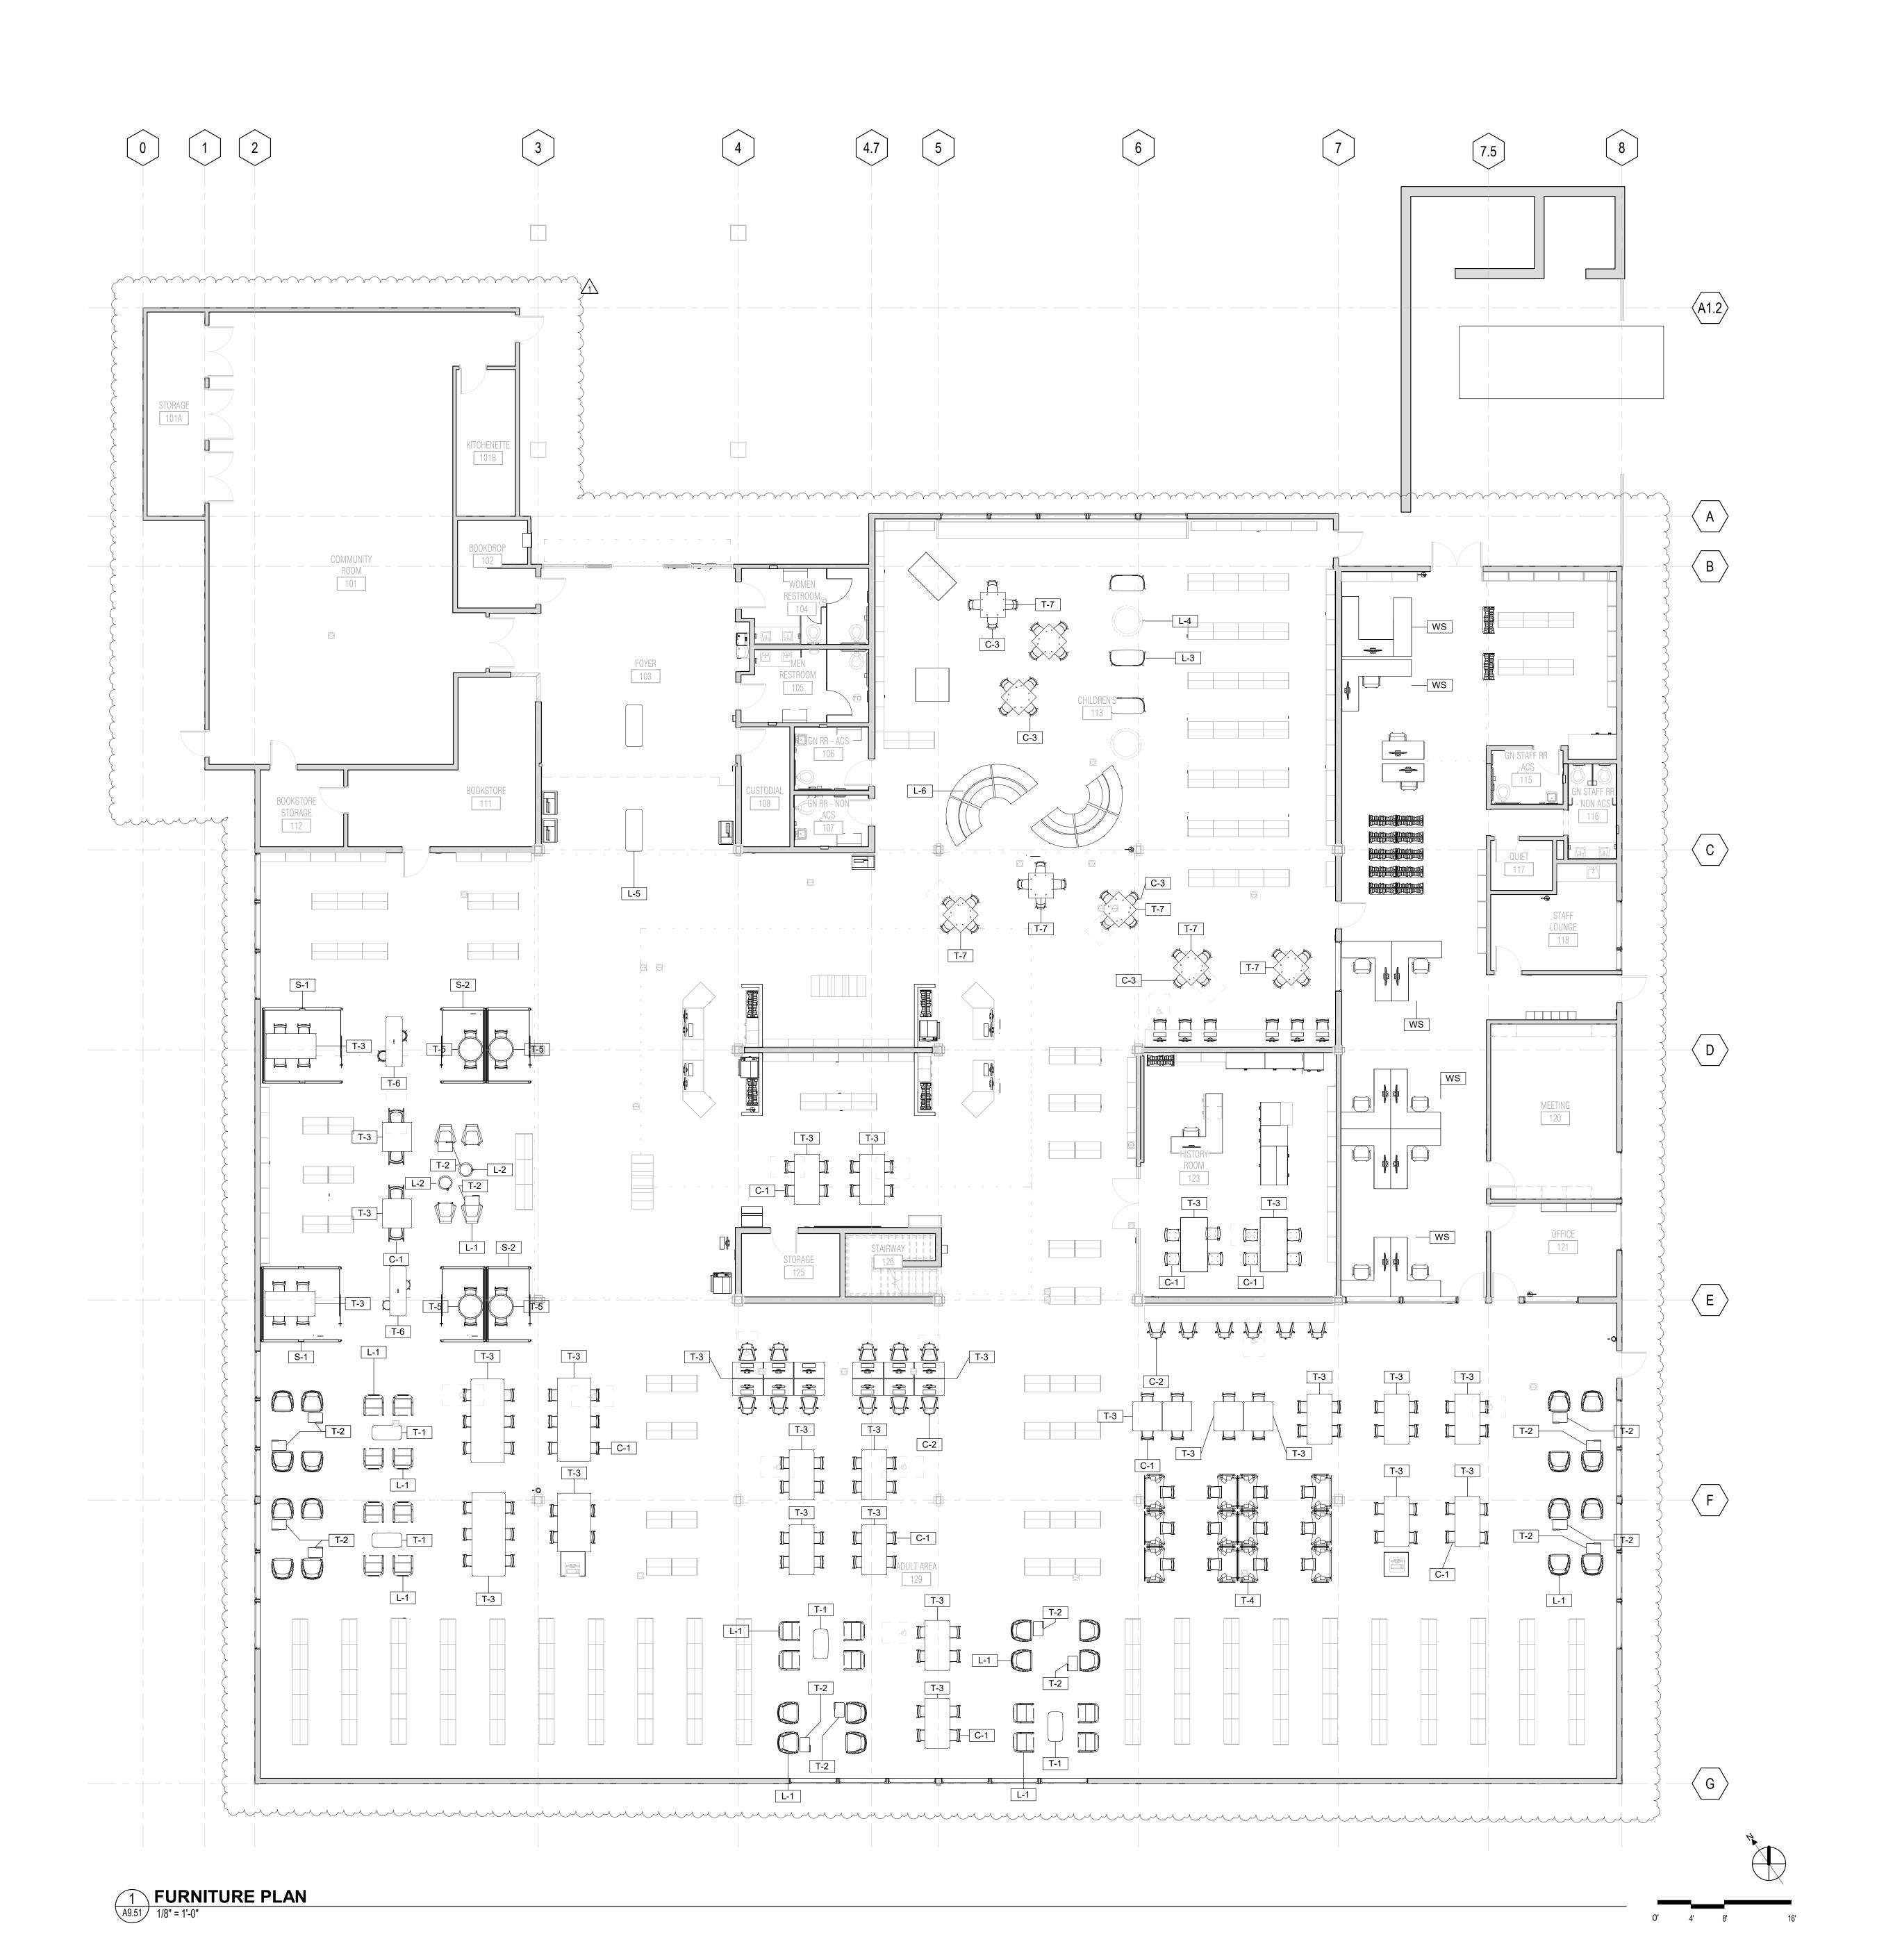GENERAL NOTES

1. FURNITURE PLAN PROVIDED FOR REFERENCE ONLY. FURNITURE BY FURNITURE CONTRACTOR.

2. ACCESSIBLE SEATING CLEARANCE ARE NOTED FOR REFERENCE ONLY. WORK SURFACES TO BE ACCESSIBLE PER CBC 11B



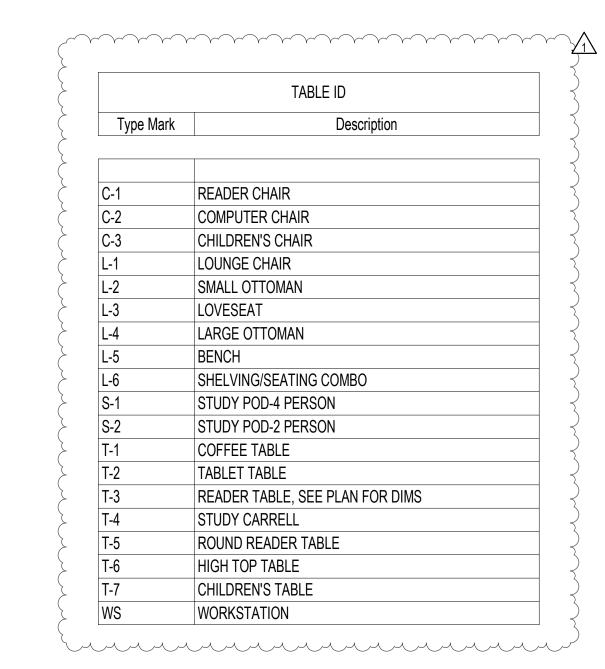

FRONT/REAR **ENTRY** PER CBC 11B-802.1.2 & 11B-802.1.3

2 ACCESSIBLE SYMBOLS - SEATING (REF)

1/8" = 1'-0"



ARCHITECTS



729 Heinz Avenue



PROJECT TITLE

SONOMA COUNTY **PETALUMA REGIONAL LIBRARY RENOVATION** PROJECT NO.

100 FAIRGROUNDS DRIVE PETALUMA, CA 94952

DESCRIPTION

PERMIT SET

ISSUE DATE N&T JOB NUMBER REVISIONS

DATE DES

1 1/22/2024 RESUBMITTAL

> REVIEWED FOR CODE COMPLIANC 05/03/2024

> > Shums Coda Associates

FURNITURE PLAN- 1ST FLOOR

SHEET NUMBER

A9.51

G STRUCTURAL SPECIFICATIONS

WOOD CONSTRUCTION (CARPENTRY)

1. EACH PIECE OF LUMBER SHALL BEAR THE STAMP OF THE WEST COAST LUMBER INSPECTION BUREAU (WCLIB) OR WESTERN WOOD PRODUCTS ASSOCIATION (WWPA) SHOWING GRADE MARK OR APPROVED EQUAL. BEAMS AND POSTS TO BE FREE OF HEART CENTER (FOHC). OTHER MATERIALS SHALL BE AS SHOWN BELOW:

THEE OF THE WAY SELVIER (I	Orio). Orrier will treat to	OI I/ (EE DI	_ 7.0 01 10 11	IV BELOW
SAWN LUMBER MEMBER	SPECIES AND MINIMUM GRADE, UNO	F _b (PSI)	F _v (PSI)	E (PSI)
6x POSTS	DOUGLAS FIR - #1	1200	170	1.6x10 ⁶
6x BEAMS	DOUGLAS FIR - #1	1350	170	1.6x10 ⁶
4x POSTS & BEAMS	DOUGLAS FIR - #1	1000	180	1.7x10 ⁶
2x JOISTS, RAFTERS	DOUGLAS FIR - #2	900	180	1.6x10 ⁶
P MATERIAL	DOUGLAS FIR - #2	900	180	1.6x10 ⁶
2x STUDS ≤ 10' HEIGHT	DOUGLAS FIR - STUD	700	180	1.4x10 ⁶
2x STUDS > 10' HEIGHT	DOUGLAS FIR - #2	900	180	1.6x10 ⁶

2. IT SHALL BE THE RESPONSIBILITY OF THE CONTRACTOR TO ENSURE THE MAXIMUM MOISTURE CONTENT OF WOOD AT THE TIME OF INSTALLATION SHALL BE NOT MORE THAN 19%.

3. NAILS TO BE OF COMMON WIRE AND OF FULL-ROUND HEADS WHERE NAILING IS SPECIFIED ON THE DRAWINGS. MACHINE-DRIVEN NAILS MEETING SIZE REQUIREMENTS ARE ACCEPTABLE. NAILS MUST NOT BE OVER-DRIVEN. PRE-DRILL NAIL HOLES WHERE WOOD TENDS TO SPLIT. NAILS AS SPECIFIED ON PLANS AND INCLUDING IN PTDF MATERIAL CONTAINING AMMONIA IN EXTERIOR APPLICATIONS SHALL BE TYPE 304 OR 316 STAINLESS STEEL. NAILS USED IN EXTERIOR APPLICATIONS OR IN INTERIOR PTDF SHALL BE HOT-DIPPED GALVANIZED PER ASTM A153.

	MINIMUM	MINIMUM	TYPICAL NAIL
WIRE NAIL	SHANK	NAIL	APPLICATION,
	DIAMETER	LENGTH UNO	UNO
16d COMMON	0.162"	3½"	FRAMING
16d SINKER	0.148"	31/4"	FRAMING
10d COMMON	0.148"	3"	FRAMING
10d COMMON	0.148"	PER <u>8/S1.2</u>	SHEATHING
8d COMMON	0.131"	PER <u>8/S1.2</u>	SHEATHING

- 4. IT SHALL BE THE RESPONSIBILITY OF THE CONTRACTOR TO ASSURE THAT THE METAL FRAMING CLIPS, HANGERS, ETC. ARE BY SIMPSON STRONG-TIE. NAILING SHALL BE IN ACCORDANCE WITH THE MANUFACTURER'S INSTRUCTIONS WITH A NAIL PROVIDED FOR EACH PUNCHED HOLE UNO. CONNECTORS AS SPECIFIED ON PLANS AND THOSE IN CONTACT WITH PTDF MATERIAL CONTAINING AMMONIA IN EXTERIOR APPLICATIONS SHALL BE TYPE 304 OR 316 STAINLESS STEEL. ALL OTHER CONNECTORS USED IN EXTERIOR APPLICATIONS OR INTERIOR PTDF SHALL BE HDG (MINIMUM 2.0 oz/SQ FT) OR ZMAX (MINIMUM 1.85 oz/SQ FT PER ASTM A653). IN APPLICATIONS WHERE NON-AMMONIA TREATED WOOD IS DRY WHEN INSTALLED AND WILL REMAIN DRY IN-SERVICE A COATING THICKNESS OF 0.9 oz/SQ FT MAY BE USED.
- 5. WOOD SCREWS SHALL CONFORM TO ANSI/ASME B18.6.1. PROVIDE PILOT HOLE 70% OF DIAMETER OF SCREW SHANK WHERE FASTENING HARDWOOD TIMBER SPECIES OR WHERE WOOD TENDS TO SPLIT. MINIMUM PENETRATION IS (10) DIAMETERS,
- 6. BOLTS SHALL BE UNFINISHED MACHINE BOLTS PER ASTM A307. NUTS SHALL BE PER ASTM A563 AND OF STANDARD SIZE UNLESS NOTED OTHERWISE. LENGTH OF BOLTS SHALL BE SUCH THAT THE BOLT PROJECTION IS NOT LESS THAN ½6" NOR MORE THAN ½" PAST END OF NUT. BOLT HOLES IN WOOD SHALL BE ½2" LARGER THAN BOLT SIZES (UNO). PROVIDE STANDARD CUT WASHERS UNDER HEAD AND NUT WHERE BOLT HEADS WOULD BEAR ON WOOD. USE MALLEABLE IRON WASHERS WHERE EXPOSED TO VIEW OR NOTED. NUTS SHALL BE TIGHTENED WHEN PLACED AND RETIGHTENED BEFORE CLOSING IN OF WALLS OR OTHER CONSTRUCTION. DO NOT CRUSH WOOD WHEN TIGHTENING. BOLTS AS SPECIFIED ON PLANS AND THOSE IN CONTACT WITH PTDF MATERIAL CONTAINING AMMONIA IN EXTERIOR APPLICATIONS SHALL BE TYPE 304 OR 316 STAINLESS STEEL. ALL OTHER BOLTS USED IN EXTERIOR APPLICATIONS SHALL BE HOT-DIPPED GALVANIZED PER ASTM A153.
- 7. WOOD AGAINST CMU OR CONCRETE SHALL BE PRESSURE TREATED DOUGLAS FIR (PTDF) PER AWPA STANDARD U1. "USE CATEGORY" UC2 AT INTERIOR. "USE CATEGORY" UC3B AT EXTERIOR (NO GROUND CONTACT). CUT FACES SHALL BE BRUSH TREATED WITH EQUIVALENT PRESERVATIVE PRIOR TO INSTALLATION.
- 8. DECKING MATERIAL AND FRAMING EXPOSED TO WEATHER TO BE PTDF AWPA "USE CATEGORY" UC3B OR REDWOOD, SAD.
- 9. WOOD ADHESIVE SHALL BE WATER-PROOF, CARTRIDGE DISPENSED, MEETING APA PRODUCT SPECIFICATION AFG-01 OR ASTM D3498. LOCTITE "PL PREMIUM" OR EQUAL. FOR USE AT SUBFLOOR SHEATHING AND WHERE SPECIFICALLY NOTED FOR USE ON DRAWINGS.
- PLYWOOD/ORIENTED STRAND BOARD (OSB) SHEATHING

 1. STRUCTURAL SHEATHING SHALL CONFORM TO PRODUCT STANDARD PS-1 OR PS-2. ALL PANELS SHALL HAVE AN EXTERIOR EXPOSURE RATING AND BEAR THE TRADEMARK OF THE ENGINEERED WOOD ASSOCIATION (APA) OR OTHER QUALIFIED AGENCY. SHEATHING SHEETS SHALL BE SPLICED ALONG CENTERLINE OF FRAMING MEMBER WITH NAILING SPACED NOT LESS THAN %" FROM EDGE OF SHEETS. MACHINE-PLACED NAILING AND NAILS TO BE APPROVED BY THE ENGINEER PRIOR TO USE. SHEATHING NAILS OF COMMON WIRE WITH FULL ROUND HEADS ARE REQUIRED.
- 2. OSB WITH EQUIVALENT THICKNESS AND SPAN RATING MAY BE USED IN LIEU OF PLYWOOD CALLED OUT. ALL OSB SHALL CONFORM TO PS-2.

PARALLEL STRAND LUMBER (PSL)

1. PSL SHALL CONFORM TO THE FOLLOWING MINIMUM PROPERTIES: E = 2.0x10⁶ PSI

 $F_b = 2,900 \text{ PSI}$ $F_c = 2,900 \text{ PSI} \text{ (PARALLEL)}$ $F_v = 290 \text{ PSI}$

LAMINATED VENEER LUMBER AND LAMINATED STRAND LUMBER (LVL AND LSL)

1. ALL LAMINATED VENEER LUMBER USED FOR BEAMS OR JOISTS SHALL BE 1.9E, F_b =2,600 PSI MINIMUM WITH MINIMUM WIDTH OF $1\frac{3}{4}$ " AND DEPTH TO MATCH JOISTS UNO. ALL LAMINATED STRAND LUMBER USED FOR RIMS OR BLOCKING SHALL BE 1.3E, F_b =1,700 PSI MINIMUM WITH MINIMUM WIDTH OF $1\frac{1}{2}$ " AND DEPTH TO MATCH JOISTS.

CONCRETE CONSTRUCTION

CONCRETE SHALL BE HARD ROCK CONCRETE AND MEET THE FOLLOWING

BEOLUBEMENTS:

MIN 28-DAY AGGREGATE MAX WATER TO LOCATION STRENGTH (PSI) SIZE CEMENT RATIO	MATERIAL PI
LOCATION STRENGTH (PSI) SIZE CEMENT RATIO	
200: CONTROL OF THE OFFICE OFFICE OFFICE OFFICE OF THE OFFICE OFFICE OFFICE OFFICE OFFICE OFFICE OFFICE OFFICE OFF	CUBIC YARI
<u>STRUCTURAL</u>	
3,000 INTERIOR SLAB (DESIGNED 1"x#4 0.45 ON GRADE ³ FOR 2.500)	6.1

MIN SACKS

- 2. CONCRETE MIX DESIGN AND TESTING SHALL MEET THE REQUIREMENTS OF CBC SECTIONS 1705 AND 1903, ACI 318 CHAPTER 19 & 26, ACI 301, AND THESE SPECIFICATIONS. CEMENT TO BE IN ACCORDANCE WITH ASTM C150 TYPE II. AGGREGATE TO MEET ASTM C33. FLY ASH TO MEET ASTM C618 CLASS F. SUBMIT MIX DESIGN AND SUPPORTING DOCUMENTATION IN ACCORDANCE WITH ACI 301 AND ACI 318 FOR REVIEW PRIOR TO PLACEMENT.
- 3. CONCRETE MIX DESIGN FOR INTERIOR SLABS ON GRADE TO HAVE 25% TO 35% CLASS F FLY ASH SUBSTITUTED FOR CEMENT AT A POUND-FOR-POUND RATE. REPLACE 200 POUNDS OF SAND WITH 200 POUNDS % "(-) AGGREGATE TO REDUCE
- 4. UNDER SLAB VAPOR RETARDER TO BE ASTM E1745 CLASS A; 15 MILS MINIMUM THICKNESS; 0.01 U.S. PERMS MAXIMUM PERMEANCE. INSTALL PER ASTM E1643 AND MANUFACTURER'S RECOMMENDATIONS. PROVIDE "STEGO WRAP VAPOR BARRIER (15MIL)" OR APPROVED EQUIVALENT. RETARDER SHALL EXTEND TO FOOTINGS BUT NOT TO BOTTOM OF FOOTING OR INTO A COLD JOINT.
- 5. REINFORCING STEEL SHALL CONFORM TO ASTM A615 GRADE 60 OR A706 GRADE 60. BARS #3 AND SMALLER MAY BE ASTM A615 GRADE 40. STEEL SHALL BE KEPT CLEAN AND FREE OF RUST. SECURELY TIE REBAR IN PLACE PRIOR TO CONCRETE PLACEMENT. SUBMIT SHOP DRAWINGS FOR REVIEW PRIOR TO INSTALLATION.

STRUCTURAL STEEL

TOTAL SAND.

1.	STEEL GRADES:	
	SQUARE AND RECTANGULAR HSS	ASTM A500 GRADE C F _y =50KSI
	MACHINE BOLTS (MB)	ASTM A307 OR F1554 GRADE 36
	MACHINE BOLT NUTS	
	MACHINE BOLT WASHERS	ASTM F844
	ANCHOR RODS	ASTM F1554 GRADE 36 OR A307 UNO
	ANCHOR ROD NUTS	ASTM A563 GRADE A
		(GRADE DH AT GRADE 105 ROD)
	ANCHOR ROD WASHERS	ASTM F436 TYPE 1
	WELDED HEADED/THREADED STUDS	ASTM A108 F _y =51KSI

- 2. WORKMANSHIP AND DETAILS SHALL CONFORM TO THE AISC SPECIFICATIONS AND THE CBC UNLESS NOTED OTHERWISE.
- 3. BOLT HOLES SHALL BE $\frac{1}{16}$ " LARGER IN DIAMETER THAN THE BOLT. ANCHOR BOLT HOLES SHALL BE $\frac{1}{16}$ " LARGER IN DIAMETER THAN THE ANCHOR BOLT.
- 4. WELDING ELECTRODES SHALL MEET AWS REQUIREMENTS AND ELECTRODES SHALL BE E70XX FOR SHIELDED METAL ARC, F7XX-EXXX FOR SUBMERGED ARC (SHOP WELDS ONLY), ER70S-X FOR GAS METAL ARC AND E7XT-XX FOR FLUX CORE (UNLESS NOTED OTHERWISE).
- 5. ALL STRUCTURAL WELDS SHALL BE INSPECTED AND CERTIFIED BY A QUALIFIED TESTING AGENCY. CERTIFICATION SHALL BE SUBMITTED TO THE ARCHITECT AND THE BUILDING DEPARTMENT.
- 6. TEMPORARY SHORING AND BRACING SHALL BE USED AND SHALL BE ADEQUATE FOR ALL LOADS TO WHICH IT MAY BE SUBJECTED. LEAVE TEMPORARY BRACING AND SHORING IN PLACE AS LONG AS MAY BE REQUIRED FOR SAFETY, AND UNTIL FINAL FRAMING CONSTRUCTION IS COMPLETED.
- 7. HIGH STRENGTH GROUT: ASTM C1107, NON-SHRINK, NON-METALLIC AGGREGATE TYPE, CAPABLE OF DEVELOPING MINIMUM COMPRESSIVE STRENGTH OF 7,000 PSI AT 28 DAYS WHEN PLACED IN A FLUID STATE. PROVIDE "MASTERFLOW 928" MANUFACTURED BY BASF.
- 8. WELDING OF THREADED STUDS, HEADED STUDS, AND DEFORMED BAR ANCHORS SHALL BE FULL-FUSION ARC WELDS CONFORMING TO AWS D1.1.

EXISTING CONSTRUCTION NOTES

- 1. IN PREPARING THE PROJECT PLANS, THE SOURCE OF INFORMATION WAS BASED ON THE EXISTING BUILDING PLANS PREPARED BY, BELAND, GIANELLI & ASSOCIATES (ARCHITECTS AND PLANNERS), BUTZBACH, BARDIN & DAGAN (STRUCTURAL ENGINEERS), DATED 11 NOV. 1974. THE CONTRACTOR SHALL VERIFY ALL EXISTING JOB CONDITIONS, REVIEW THE PLANS AND VERIFY ALL DIMENSIONS PRIOR TO CONSTRUCTION. THE CONTRACTOR SHALL NOTIFY THE ARCHITECT/ENGINEER OF ALL DISCREPANCIES AND EXCEPTIONS BEFORE PROCEEDING WITH ANY WORK. DRAWINGS FOR THE EXISTING CONSTRUCTION ARE AVAILABLE FOR REVIEW.
- 2. ALL WORK NOT INDICATED AS EXISTING (E) SHALL BE ASSUMED TO BE NEW (N).
- 3. ANY REMOVAL, CUTTING, DRILLING, ETC OF EXISTING WORK SHALL BE PERFORMED WITH GREAT CARE. SMALL TOOLS SHALL BE USED IN ORDER NOT TO JEOPARDIZE THE STRUCTURAL INTEGRITY OF THE STRUCTURE. IF STRUCTURAL MEMBERS OR MECHANICAL, ELECTRICAL, OR ARCHITECTURAL ELEMENTS NOT INDICATED FOR REMOVAL INTERFERE WITH THE NEW WORK, THE ARCHITECT/ENGINEER SHALL BE IMMEDIATELY NOTIFIED AND PRIOR APPROVAL SHALL BE OBTAINED BEFORE REMOVAL OF THE MEMBERS.
- 4. DO NOT OVER CUT EXISTING WOOD, CONCRETE, MASONRY OR OTHER WORK TO REMAIN. CUTS SHALL BE MADE NEATLY TO A CORNER, THEN ALTERNATE MEANS SHALL BE USED TO REMOVE REMAINING MATERIAL. CONTRACTOR IS RESPONSIBLE FOR REPAIR/REPLACEMENT OF OVER CUT MATERIAL AS DIRECTED BY THE ARCHITECT AND/OR ENGINEER.
- 5. EXISTING DAMAGED STRUCTURAL MEMBERS WHICH ARE UNCOVERED SHALL BE REPORTED TO THE ARCHITECT/ENGINEER FOR REVIEW AND REPAIR.
- 6. EXISTING CONCRETE SURFACE ABUTTING NEW CONCRETE SHALL BE ROUGHENED TO 1/4" AMPLITUDE AND THOROUGHLY CLEANED OF DUST, LOOSE AGGREGATE, LAITANCE, ETC.
- CONDITIONS WHICH MAY NOT BE VERIFIABLE WITHOUT DESTROYING OTHERWISE ADEQUATE OR SERVICEABLE PORTIONS OF THE STRUCTURE. THIS ANALYSIS DOES NOT MAKE ANY GUARANTEE TO THE ADEQUACY OF THE STRUCTURAL DESIGN OF THE EXISTING BUILDING NOT SPECIFICALLY ADDRESSED IN THE STRUCTURAL CALCULATIONS. ZFA SHALL NOT BE RESPONSIBLE FOR UNSATISFACTORY PERFORMANCE OF EXISTING PORTIONS OF THE STRUCTURE NOT SPECIFICALLY ADDRESSED IN THE CONSTRUCTION DOCUMENTS.

ABBREVIATIONS

BLDG BLK/BLKG

ABOVE
AIR CONDITIONING
ADJACENT
ADDITIONAL
ALTERNATE
ALUMINUM
ARCHITECT

BLOCK/BLOCKING

AMERICAN STANDARD

CERTIFIED GLUED LUMBER | JT

CONCRETE MASONRY UNIT | LVL

DOUBLE
DEMAND CRITICAL WELD
DOUGLAS FIR
DIAMETER
DIAGONAL
DIMENSION
DOWEL JOINT
DEAD LOAD
DOWN
DITTO
DRAWING
DOWEL
EACH
EACH END
EACH FACE
ELECTRICAL
ELEVATOR/ELEVATION
EMBEDMENT

E) EXISTING
EXPANSION
EXTERIOR
FOUNDATION
FINISH
FINISH GRADE
FERRULE LOOP INSERT
FLOOR
FACE NAIL
FACE OF CONCRETE
FACE OF MASONRY
FACE OF STUD
FRAMING
FAR SIDE
FOOTING
GAGE or GAUGE
GALVANIZED

ELEVATORYELE
EMBEDMENT
EQUAL
EQUIPMENT
EACH SIDE
EACH WAY
(E) EXISTING

MC
MECH
MEZZ
MF
MFR
MIN
MISC
MIW
MTL
(N)
NIC
NO or #
NS
NSG
NTS
O/

CANTILEVER

COLUMN COLLECTOR CONCRETE

CONNECTION CONTINUOUS COORDINATE/

CARRIAGE BOLT

CONTROL JOINT CENTERLINE

REMODELING REQUIRES ASSUMPTIONS BE MADE REGARDING EXISTING

DESIGN CRITERIA

<u>DESIGN CRITERIA</u>: <u>FLOOR LIVE LOAD</u>: <u>ROOF LIVE LOAD</u>:

2022 CALIFORNIA CODE OF REGULATIONS, TITLE 24, PART 2 (CBC) 60 PSF (REDUCIBLE) + 15 PSF PARTITION 20 PSF (REDUCIBLE)

RISK CATEGORY: SCOPE:

THE MAIN STRUCTURAL SCOPE OF THE PETALUMA LIBRARY REFRESH PROJECT IS TO ADD NEW SKYLIGHTS TO THE EXISTING WOOD FRAMED ROOF. NEW BEAMS ARE REQUIRED TO FRAME OUT THE NEW OPENINGS AS WELL AS NEW CEILING FRAMING BELOW ONE OF THE SKYLIGHTS. NEW FRAMING IS ALSO PROVIDED AT A NEW ROLLUP DOOR. IN ADDITION, NEW FIRE SPRINKLERS ARE BEING INSTALLED THROUGHOUT THE LIBRARY.



- 1. REFER TO SHEETS <u>S1.1</u> AND <u>S1.2</u> FOR STANDARD DETAILS OF CONSTRUCTION. REFER TO THE PROJECT SPECIFICATIONS FOR MATERIALS AND METHODS.
- 2. BUILDING DIMENSIONS SHOWN ARE FOR GENERAL REFERENCE ONLY. SEE ARCHITECTURAL DRAWINGS (SAD) FOR ALL ACTUAL BUILDING DIMENSIONS. ANY DISCREPANCIES ARE TO BE BROUGHT TO THE ATTENTION OF THE ARCHITECT/ENGINEER SO CLARIFICATION CAN BE MADE PRIOR TO COMMENCING WORK.
- 3. STRUCTURAL DRAWINGS SHALL NOT BE SCALED. ALL DIMENSIONS AND FIT SHALL BE DETERMINED AND VERIFIED BY THE CONTRACTOR PRIOR TO COMMENCING WORK
- 4. DETAILS NOT FULLY OR SPECIFICALLY SHOWN SHALL BE OF SAME NATURE AS OTHER SIMILAR CONDITIONS.
- 5. SHORING AND BRACING DESIGN, MATERIALS AND INSTALLATION SHALL BE PROVIDED BY THE GENERAL CONTRACTOR, AND SHALL BE ADEQUATE FOR ALL LOADS. LEAVE IN PLACE AS LONG AS MAY BE REQUIRED FOR SAFETY AND UNTIL FINAL STRUCTURAL CONSTRUCTION IS COMPLETED.
- 6. SPECIAL INSPECTIONS ARE REQUIRED PER <u>C/S0.1</u>AND THE TESTING AND INSPECTION FORM.
- 7. STRUCTURAL OBSERVATION PER CBC SECTION 1704.6 IS NOT REQUIRED. NOTIFY ZFA FOR GENERAL REVIEW OF:
- STRUCTURAL WOOD FRAMING.
- NOTIFY ZFA FOR REVIEW PRIOR TO COVERING ABOVE LISTED WORK. PROVIDE 2 WORKING DAYS MINIMUM SCHEDULING NOTICE PRIOR TO REVIEW DATE.
- 8. SUBMIT ENGINEERING FOR DEFERRED APPROVAL ITEMS TO ARCHITECT/ENGINEER FOR REVIEW AND SUBMITTAL TO THE BUILDING DEPARTMENT FOR APPROVAL PRIOR TO FABRICATION. DEFERRED APPROVAL ITEMS SHALL BE DESIGNED AND DETAILED BY MANUFACTURER TO ACCOMMODATE HORIZONTAL AND VERTICAL MOVEMENTS AS NOTED IN STRUCTURAL DRAWINGS. GENERAL CONTRACTOR SHALL REVIEW AND APPROVE DIMENSIONS AND DETAILS SHOWN ON THE SHOP DRAWINGS PRIOR TO SUBMITTAL. MANUFACTURER TO PROVIDE DRAWINGS AND CALCULATIONS DESIGNED IN ACCORDANCE WITH THE CBC AND SPECIFICATIONS, PREPARED AND SIGNED BY A CALIFORNIA LICENSED CIVIL OR STRUCTURAL ENGINEER FOR THE FOLLOWING ITEMS, UNLESS NOTED OTHERWISE:
- A. SKYLIGHT SYSTEMS: INCLUDING ATTACHMENTS TO STRUCTURE.

SPECIAL INSPECTION BY OWNERS TESTING AGENCY

SPECIAL INSPECTIONS AND TESTING SHALL BE PERFORMED BY AN APPROVED AGENCY IN ACCORDANCE WITH CBC CHAPTER 17 AND THE STATEMENT OF SPECIAL INSPECTIONS AS REQUIRED BY CBC SECTIONS 1704.2.3 AND 1704.3 FOR BUILDING STRUCTURAL ELEMENTS SUMMARIZED AS FOLLOWS:

- STRUCTURAL STEEL CONSTRUCTION PER CBC SECTIONS 1705.2, 1705.12.1, 1705.13.1, AND TABLE 1705.2.3 INCLUDING MATERIAL IDENTIFICATION, SHOP AND FIELD WELDING, AND INSTALLATION OF HIGH-STRENGTH BOLTS.
- 2. WOOD CONSTRUCTION PER CBC SECTIONS 1705.5, 1705.11.1, AND 1705.12.2 INCLUDING NAILING, BOLTING, AND ANCHORING OF ALL DRAG STRUTS; TOP PLATE SPLICES, LEDGER SPLICES, SIMPSON HARDWARE, BRACES, AND HOLDOWNS; AND NAILING, BOLTING, AND ANCHORING OF ALL SHEAR WALLS, SHEAR PANELS, AND DIAPHRAGMS WHERE THE FASTENER SPACING OF THE SHEATHING IS 4" APART OR LESS.
- 3. SPECIAL CASES PER CBC SECTION 1705.1.1 AND PRODUCT ICC REPORTS FOR ALL STRUCTURAL MATERIALS AND SYSTEMS REQUIRED TO BE INSTALLED IN ACCORDANCE WITH ADDITIONAL MANUFACTURER'S INSTRUCTIONS THAT PRESCRIBE REQUIREMENTS NOT CONTAINED IN THE CBC OR REFERENCED STANDARDS INCLUDING POST-INSTALLED ANCHOR BOLTS IN CONCRETE AND CMU, AND PRE-MANUFACTURED SHEAR PANELS AND BRACED FRAMES.

WOOD FRAMING NOTES

PRESSURE TREATED
DOUGLAS FIR

RAFTER REFERENCE

REINFORCING REQUIRED RETAINING REVISION

OLID BLOCK

SCD SCHED SED SEOR

TU TYP UNO VERT VIF VSH W RADIUS REDUCED BEAM SECTION

AMERICAN STANDARD BEAL

SLIP CRITICAL SPECIAL CONCENTRIC

SCHEDULE SEE ELECTRICAL DRAWINGS

STRUCTURAL ENGINEER OI

SEISMIC FORCE RESISTING

SPECIAL MOMENT FRAME

SEE PLUMBING DRAWINGS

SHEET METAL SCREW

SLAB ON GRADE

STANDARD STIFFENER STEEL STRUCTURAL

STRUCTURAL
SHEAR WALL
SYMMETRICAL
TOP AND BOTTOM
TONGUE AND GROOVE
THICK
THREADED
THROUGH
TOTAL LOAD
TOE NAIL
TOP OF CONCRETE
TOP OF EPAMING

TOP OF PLYWOOD TOP OF STEEL

VERTICAL VERIFY IN FIELD

TOTAL
TILT UP
TYPICAL
UNLESS NOTED OTHERWISE

VERTICAL SLOTTED HOLE WIDE FLANGE STEEL BEAM

WITH
WITHOUT
WOOD
WELDED HEADED STUD
WELDED
WORK POINT/WATERPROOF

WELDED THREADED STUD WELDED WIRE REINFORCEMENT

BRACED FRAME SEE CIVIL DRAWINGS

GLUE LAMINATED BEAM

HOLD DOWN HOT-DIP GALVANIZED

HIGH STRENGTH HIGH STRENGTH BOLT

HIGH STRENGTH GROUT HORIZONTAL SLOTTED

HOLLOW STRUCTURAL

INSIDE DIAMETER

INTERIOR

KING POST STEEL ANGLE

LOCATION LAG SCREW

METAL BUILDING MANUFACTURER

NUMBER NEAR SIDE NON-SHRINK GROUT

OUTSIDE DIAMETER
OPPOSITE HAND
OPENING
OPPOSITE
OVERSIZED
OTHERWISE
OPEN WEB TRUSS
PLATE OF PROPERTY LINE

POWDER DRIVEN PINS
PANEL EDGE NAIL
PERPENDICULAR
PANEL EDGE SCREWS
PARTIAL JOINT PENETRATION
POUNDS PER LINEAR FOOT
POUNDS PER SQUARE FOOT
POUNDS PER SQUARE INCH
PARALLEL STRAND LUMBER
PANEL TIE BAR

POUND(s) LIGHT GAGE METAL

LIGHT GAGE METAL

FRAMING CONTRACTOR

LAMINATED VENEER LUMBER SS

MANUFACTURER
MISCELLANEOUS CHANNEL
MECHANICAL
MEZZANINE
MOMENT FRAME
MANUFACTURER
MINIMUM
MISCELLANEOUS
MALLEABLE IRON WASHER
METAL
NEW
NOT IN CONTRACT
NUMBER

STRUCT
SW
SYM
MY
SYM
T&B
T&B
T**B
T**B
THK
THRD
THRU
TL
TN
TN
TOC

LONG LEG HORIZONTAL

LONG LEG VERTICAL

I SHAPED WOOD BUILT

HANGER HOOK HORIZONTAL

- ALL BEAMS AND JOISTS (EXCLUDING I JOISTS) SHALL BE SEAT CUT FOR FULL UNIFORM BEARING AT SUPPORTS, INCLUDING BEAM SEATS AND COLUMN CAPS.
- 2. SEE <u>8/S1.2</u> FOR SHEATHING NAILING REQUIREMENTS. ALL NAILING NOT NOTED OR DETAILED OTHERWISE SHALL BE PER <u>7/S1.2</u>. NAIL LENGTH TO BE SUFFICIENT TO MEET CBC PENETRATION REQUIREMENTS.
- ALL MECHANICAL SUPPLY AND RETURN OPENINGS TO BE BETWEEN FRAMING UNO.
 JOISTS AND RAFTERS ARE PER PLAN. UNLESS NOTED OTHERWISE, PROVIDE "LU" HANGER AT FLUSH FRAMING AND "HU" HANGER WHERE HANGER IS SHOWN SKEWED PER PLAN AND/OR HANGER SEAT IS INDICATED TO BE SLOPED. HANGER
- FOR PANELIZED ROOF CONSTRUCTION ARE PER PLAN.

 5. ROUND HOLES IN STEEL PLATES TO BE 1/16" OVERSIZE. SLOTTED HOLES IN STEEL PLATES SHALL BE 1/16" WIDER THAN THE BOLT DIAMETER AND HAVE A LENGTH OF 2 TIMES THE BOLT DIAMETER. THE DIRECTION OF THE SLOTTED LENGTH IS INDICATED ON THE DETAILS (VSH OR HSH). INSTALL BOLT AT THE CENTER LINE OF THE HOLE. BOLT HOLES IN WOOD SHALL BE ROUND AND 1/32" OVERSIZE. CUT OFF BOLT THREADED END FLUSH WITH NUT WHEN REQUIRED BY FINISHES AND 1"

MAXIMUM FROM NUT OTHERWISE. PROVIDE STANDARD CUT WASHERS UNDER

SIZE TO BE CORRECT FULL SIZE FOR JOIST SIZE (I.E. LU210 FOR 2x10). HANGERS

- HEAD AND NUT WHERE BOLT BEARS ON WOOD. USE PLATE OR MALLEABLE IRON WASHERS AT EXPOSED CONDITIONS OR AS INDICATED.
 6. ALL BOLTED OR NAILED STRAP CONNECTIONS SHALL HAVE AN EQUAL NUMBER OF BOLTS OR NAILS EACH SIDE OF THE SPLICE JOINT. THE FIRST BOLT OR NAIL FROM EACH SIDE OF THE SPLICED OR STRAPPED MEMBER SHALL BE EQUIDISTANT FROM THE SPLICE. STRAPS USING 16d NAILS ON 2x MATERIAL TO BE INSTALLED ON THE 1½" EDGE OF THE MEMBER.
- 7. THE CONTRACTOR SHALL VERIFY THAT THE MOISTURE CONTENT OF ALL FRAMING LUMBER AND SHEATHING MEET THE REQUIREMENTS OF THE SPECIFICATIONS AT THE TIME OF INSTALLATION AND AT CLOSE-IN. THE CONTRACTOR SHALL PROVIDE ALLOWANCE FOR DIFFERENTIAL SHRINKAGE BETWEEN FLOORS, ETC.
- 8. VENTING IS REQUIRED IN ENCLOSED FRAMING AREAS, SAD. DRILL BLOCKING AND LEDGERS AND PROVIDE SKIP BLOCKING AS DETAILED.
- SAD FOR CEILING INFO. WHERE REQUIRED PROVIDE CEILING JOISTS PER PLAN AND DETAILS, UNO.
- 10. EXISTING ROOF SHEATHING, AS REQUIRED REPLACE IN KIND WITH: 19/32" APA RATED SHEATHING (32/16) EXP 1 WITH 10d @ 4" oc EDGES (PEN) AND 12" oc FIELD UNO ON PLANS. NO PANELS LESS THAN 24" WIDE SHALL BE USED. EDGES OF PLYWOOD SHEETS NOT NAILED TO JOISTS SHALL BE NAILED TO 2X4 FLAT
- 11. CEILING FINISH TO BE MINIMUM %" GYPSUM W/ No 6 TYPE S OR W DRYWALL SCREWS 11/4" LONG @ 8"oc PEN AND 12"oc FIELD.

		SHEET INDEX
	S0.1	GENERAL NOTES AND SPECIFICATIONS
	S1.1	TYPICAL CONCRETE DETAILS
	S1.2	TYPICAL WOOD DETAILS
	S2.1	FOUNDATION PLAN
	S2.2	ROOF FRAMING PLAN
_	S2.2A	ROOF FRAMING PLAN - DEDUCT ALTERNATE 1
<u>/2</u> \	S2.2B	ROOF FRAMING PLAN - DEDUCT ALTERNATE 2
	S2.3	PARTIAL ROOF FRAMING PLANS
\wedge	S2.4	PARTIAL CEILING FRAMING PLAN AND ELEVATIONS
<u>/2</u> \	(S2.4A)	PARTIAL CEILING FRAMING PLAN - DEDUCT ALTERNATE 1
	S4.1	DETAILS
	S4.2	FALL PROTECTION DETAILS

NOLL & TAM

> 729 Heinz Avenue Berkeley, CA 94710 tel 510.542.2200 fax 510.542.2201

REVIN G. ZUCCO

No. 4861

STRUCTURAL

■ SIROCIONAL EINGIINEE montgomery street | suite 1450 zfa.co francisco ca 94111 415.243.408 ob no. 18533 copyright © 20%

PROJECT TITLE

PETALUMA
REGIONAL
LIBRARY
RENOVATION
PROJECT NO.
10-19

100 FAIRGROUNDS DRIVE PETALUMA, CA 94952

PERMIT SET

SSUE DATE 11/20

N&T JOB NUMBER 2'

REVISIONS

A DATE DESCRIPTION

DEDUCT ALTERNATES

REVIEWED FOR CODE COMPLIANCE

Shums Coda Associates

SHEET TITLE

4/24/24


GENERAL NOTES AND SPECIFICATIONS

SHEET NUMBER

S0.1

......PPROVALS

C:\revit_local\18533_Petaluma Labrary_

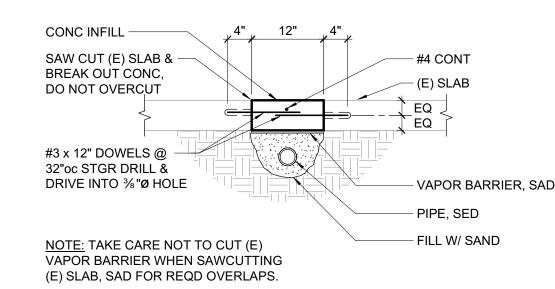


1 NEW PIPE AT EXISTING SLAB
3/4" = 1'-0"

	SCRE	EW ANCHO	R IN 2500	PSI MIN	ONCRE	ETE	
ANCHOR TYPE	ANCHOR AND PILOT HOLE DIA	MINIMUM EMBEDMENT H _{nom}	MINIMUM EDGE DIST C _{min}	MINIMUM SPCG S _{min}	MINIMUM CONCRETE THICKNESS H _{min}		MAXIMU INSTAL TORQU (FT-LB
	1/4"	1%"	1½"	1½"	31/4"	10	24
OIMPOON	3/8"	2½"	1¾"	3"	4"	10	50
SIMPSON TITEN HD	1/2"	31/4"	1¾"	3"	5"	10	65
(ICC-ESR	5/8"	4"	13/4"	3"	6"	10	100
2713)	3/4"	5½"	1¾"	3"	8¾"	20	150
	1/4"	15/8"	2"	1½"	31/4"	10	18
HILTI	3/8"	2½"	1½"	3"	4"	10	40
KH-EZ	1/2"	3"	13/4"	3"	4¾"	10	45
(ICC-ESR	5/8"	31/4"	13/4"	4"	5"	10	85
3027)	3/4"	4"	13/4"	4"	6"	20	95

1. INSTALL SCREW ANCHORS PER MANUFACTURER'S INFORMATION AND ICC REPORT

- IN ACCORDANCE W/ SCHEDULE PRIOR TO INSTALLING ANCHOR.
- 4. THE SPECIAL INSPECTOR MUST BE ON THE JOBSITE PERIODICALLY DURING ANCHOR INSTALLATION TO VERIFY ANCHOR TYPE, ANCHOR DIMENSIONS, HOLE CLEANLINESS, EMBEDMENT DEPTH, CONCRETE TYPE, CONCRETE COMPRESSIVE STRENGTH, DRILL BIT DIAMETER, HOLE DEPTH, EDGE DISTANCE(S), ANCHOR SPACING(S), CONCRETE THICKNESS, AND TIGHTENING TORQUE.


				MINI			
ADHESIVE	ANCHOR		PILOT	MIN EMBED	MIN EDGE	MIN	MIN CON
TYPE	THRD	REBAR	HOLE	UNO	DISTANCE	SPCG	DEPTH
	ROD	T(LB) (IT		H_{ef}	C_{min}	S_{min}	H_{min}
	¾" ø	#3	½ "Ø	3"	1¾"	3"	5"
	½"Ø	#4	5⁄8 "Ø	4"	1¾"	3"	6½"
SIMPSON SET-XP	%" ø	#5	¾ "Ø	5"	1¾"	3"	81/4"
(ICC-ESR	¾ "Ø	#6	7∕8 "∅	6"	1¾"	3"	9¾"
2508)	7∕8 "Ø	#7	1"Ø	7"	1¾"	3"	11½"
ŕ	1"Ø	#8	11/8 "Ø	8"	1¾"	3"	13"
	1¼"ø	#10	1%"ø	10"	2¾"	6"	161/4"
	3/8 "Ø	N/A	7∕ ₁₆ "Ø	3"	1¾"	1%"	41/4"
	N/A	#3	½ "Ø	3"	1¾"	1%"	41/4"
HILTI HIT-	½"ø	N/A	%16 "Ø	4"	1¾"	2½"	51/4"
HY 200R	N/A	#4	5⁄8 "Ø	4"	1¾"	2½"	51/4"
(ICC-ESR	%" ø	#5	³⁄₄ "Ø	5"	1¾"	31/8"	6½"
3187)	¾ "Ø	#6	% "∅	6"	1¾"	3¾"	7¾"
	7∕8 "ø	#7	1"Ø	7"	1¾"	43/8"	9"
	1"Ø	#8	11/8 "Ø	8"	1¾"	5"	101/4"
	N/A	#9	1% "ø	9"	1¾"	5%"	11¾"
	1¼"ø	N/A	1% "Ø	10"	1¾"	61/4"	12¾"
	N/A	#10	1½"Ø	10"	1¾"	61/4"	13"

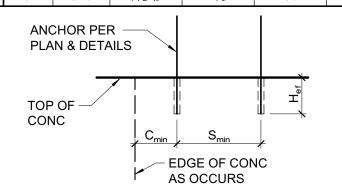


1. INSTALL ADHESIVE ANCHORS PER MANUFACTURER'S INFORMATION AND ICC REPORT.

- 2. CONTRACTOR TO VERIFY MINIMUM EDGE DISTANCES, SPACING, AND THICKNESS ARE IN ACCORDANCE W/ SCHEDULE PRIOR TO INSTALLING ANCHOR.
- ADHESIVE ANCHOR IN CONCRETE

 3/4" = 1'-0"

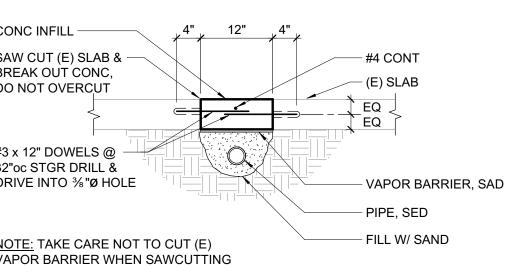


	SCRE	EW ANCHO	R IN 2500	PSI MIN	N CONCRE	ETE	
ANCHOR TYPE	ANCHOR AND PILOT HOLE DIA	MINIMUM EMBEDMENT H _{nom}	MINIMUM EDGE DIST C _{min}	MINIMUM SPCG S _{min}	MINIMUM CONCRETE THICKNESS H _{min}		MAXIMU INSTAL TORQU (FT-LB
	1/4"	1%"	1½"	1½"	31/4"	10	24
OIMPOON	3/8"	2½"	1¾"	3"	4"	10	50
SIMPSON TITEN HD	1/2"	31/4"	1¾"	3"	5"	10	65
(ICC-ESR	5/8"	4"	1¾"	3"	6"	10	100
2713)	3/4"	5½"	1¾"	3"	8¾"	20	150
	1/4"	1%"	2"	1½"	3¼"	10	18
HILTI	3/8"	2½"	1½"	3"	4"	10	40
KH-EZ	1/2"	3"	13/4"	3"	4¾"	10	45
(ICC-ESR	5/8"	31/4"	13/4"	4"	5"	10	85
3027)	3/ !!	/ "	13/."	4"	6"	20	05

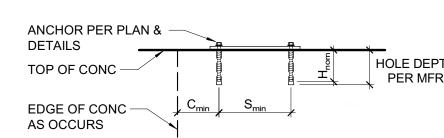


INSTRUCTIONS. SPECIAL INSPECTION IS REQUIRED PER SECTION 1705 OF THE CBC AND THE REQUIREMENTS OF THE ICC REPORTS. INSTALLED ANCHORS SHALL BRING CONNECTED PLIES INTO FIRM CONTACT, MEETING THE INSTALL TORQUE BUT NOT EXCEEDING THE MAXIMUM INSTALL TORQUE.

- 2. CONTRACTOR TO VERIFY MINIMUM EDGE DISTANCES, SPACING AND THICKNESS ARE
- 3. HOLES TO BE DRILLED W/ ROTARY DRILL ONLY. WHEN INSTALLING DRILLED-IN ANCHORS IN EXISTING REINFORCED CONCRETE, USE CARE AND CAUTION TO AVOID CUTTING OR DAMAGING THE EXISTING REINFORCING BARS. MAINTAIN A REASONABLE CLEARANCE BETWEEN REINFORCEMENT AND THE DRILLED-IN ANCHOR. FILL ABANDONED HOLES W/ HIGH STRENGTH GROUT.

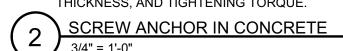

	אחוב2	IVEAN			MIN CON	CKEIE	,
ADHESIVE	ANC	ANCHOR		MIN EMBED	MIN EDGE	MIN	MIN CO
TYPE	THRD ROD	REBAR	PILOT HOLE	UNO H _{ef}	DISTANCE C _{min}	SPCG S _{min}	DEPTH H _{min}
	3% " Ø	#3	½ "ø	3"	13/4"	3"	5"
	½"ø	#4	5% "Ø	4"	1¾"	3"	6½"
SIMPSON	5⁄8 "Ø	#5	3/4 "Ø	5"	13/4"	3"	81/4"
SET-XP (ICC-ESR	3/4 "Ø	#6	7∕8 "Ø	6"	1¾"	3"	9¾"
2508)	7∕8 "Ø	#7	1"Ø	7"	1¾"	3"	11½"
,	1"Ø	#8	11/8 "Ø	8"	1¾"	3"	13"
	1¼"ø	#10	1% "Ø	10"	2¾"	6"	161/4"
	3% "Ø	N/A	⅓6 "Ø	3"	1¾"	1%"	41/4"
	N/A	#3	½ "Ø	3"	1¾"	1%"	41/4"
HILTI HIT-	½" ø	N/A	%16 "Ø	4"	1¾"	2½"	51/4"
HY 200R	N/A	#4	5⁄8 "Ø	4"	1¾"	2½"	51/4"
(ICC-ESR	%" ø	#5	3/4 "Ø	5"	1¾"	31/8"	6½"
3187)	3⁄4 "Ø	#6	7∕8 "∅	6"	1¾"	3¾"	7¾"
	7∕8 "Ø	#7	1"Ø	7"	1¾"	43/8"	9"
	1"Ø	#8	11/8 "Ø	8"	1¾"	5"	101/4"
	N/A	#9	1%"Ø	9"	1¾"	5%"	11¾"
	1¼"ø	N/A	1%"Ø	10"	1¾"	61/4"	12¾"
	N/A	#10	1½"Ø	10"	13/4"	61/4"	13"

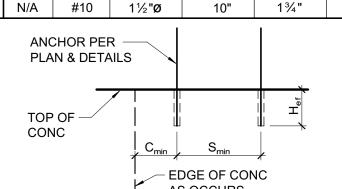

- 3. HOLES TO BE DRILLED W/ ROTARY DRILL ONLY. WHEN DRILLING HOLES IN EXISTING CONCRETE, USE CARE AND CAUTION TO AVOID CUTTING OR DAMAGING THE EXISTING REINFORCING BARS. MAINTAIN A REASONABLE CLEARANCE BETWEEN


REINFORCEMENT AND THE DRILLED-IN ANCHOR. FILL ABANDONED HOLES W/ HIGH

- 4. SPECIAL INSPECTION IS REQUIRED PER SECTION 1705 AND THE REQUIREMENTS OF THE ICC REPORTS. THE SPECIAL INSPECTOR MUST BE ON THE JOB SITE PERIODICALLY DURING ANCHOR INSTALLATION TO VERIFY ANCHOR TYPE. ANCHOR DIMENSIONS, HOLE CLEANLINESS, EMBEDMENT DEPTH, CONCRETE TYPE, CONCRETE COMPRESSIVE STRENGTH, DRILL BIT DIAMETER, HOLE DEPTH, EDGE DISTANCE(S), ANCHOR SPACING(S), CONCRETE THICKNESS, AND ADHESIVE

STRENGTH GROUT.

ARCHITECTS 729 Heinz Avenue

Berkeley, CA 94710 tel 510.542.2200 fax 510.542.2201

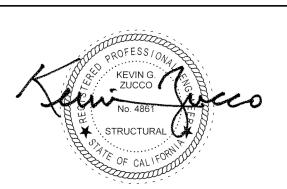

PROJECT TITLE

SONOMA COUNTY PETALUMA

100 FAIRGROUNDS DRIVE PETALUMA, CA 94952

PERMIT SET

ISSUE DATE N&T JOB NUMBER DESCRIPTION




SHEET TITLE

TYPICAL CONCRETE DETAILS

SHEET NUMBER

			MIN.		CHEDULE K. NAIL SPACI EE NOTES #1 & #2		MIN. END
	MARK	STRAP	NAILING ES OF ◆	CASE 1		SE 2	LENGTH (EL)
	(A)	CS16	(10) 10d	10d @ 4"oc STGR	FILL ALL NAIL HOLES	10d @ 4"oc STGR	12"
	B	CS14	(13) 10d	10d @ 4"oc STGR	FILL ALL NAIL HOLES	10d @ 4"oc STGR	16"
	© (C)	CMSTC16	, ,	10d @ 3"oc STGR 10d @ 3½"oc	FILL ALL NAIL HOLES FILL ALL NAIL	10d @ 3"oc STGR 10d @	24"
	(E)	CMST14	(33) 10d (43) 10d	STGR 10d @	HOLES FILL ALL NAIL	3½"oc STGR 10d @ 3½"oc	32" 48"
				3½"oc STGR END LENGTH (EL) IS NOTED	STGR ON PLANS. W	
			,	ED, SEE CASE 2		LIT I ENOTH	
	EQ	CUT LENG	EQ	END L	ENGTH (EL)	UT LENGTH REMAINDER	LENGTH (F
₹ <u>©. </u>	. °. °. °.	• • • • •			•	• • • • • • • • •	0,0000
		CASE	<u>1</u>			CASE 2	
		REQUIRED, H SIDE OF		CLOSER NAIL S	PACING TO M	MEET MINIMUM	1 NAILING
				HEATHING AND			FLAT 2x6
	·		,	RE NO FRAMING ENGTHS, LOCA			
	4. OLL	TEANSTO	IN OTHALL	LIVOTTIO, LOUA	THONG AND D	LIAILO, ONO.	
10)	TIE S		CHEDULI	<u> </u>			
					(6	6) 10d MIN TO E	BLK CLINCI
			IJ		T'	Ϋ́P	
					IJ	BLKG	
		(6) 100	I MIN ——/		2	x4 BLK ES OF	IJ
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		В					
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CHC	RDS & V	WEB AT —					
BLK	3 PNL T] >	BLKG	
AS I		(B)		1.	IJ		
	<u> </u>	JOIST BI	OCKING	3			
			IJ —	< T/T			
			(s	OLID BLKG	
3½"	MIN WII	DE WEB FII	LLER —			0d TN @ 6"oc E	ES
	_	S AT SB			S	TGR (4 MIN)	
		A)				
			IJ —				
					/	B: ½" MIN LVL/LS	SL AT JOIST
		A) /		D 3	EPTH ≤ 24" ⅓" MIN GLB O	R SOLID
						VL/LSL AT JOIS	ST DEPTH
	S	OLID BL	OCKING				
		JE	<u> </u>				
	~	·	1715 -				
11)	1-JOIS 3/4" = 1	ST BLOC '-0"	KING				
_				LOAD	1		
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						VII.10 =: 5 · · ·	
					SI SI	NUG TIGHT	
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			•				
		<u>(</u>	CONCEN OR PERPE	TRATED TO	P CHORD FLANGE HAN	LOADING NGER)	
		`					
		ILLER WID	TH AS —			Ξ	
FACI	E MOUN	ATTACHME			/	LLER AND FAS	STENERS F
REC	OMMEN	DATIONS				MFR	
		SNUG	TIGHT —			<u> </u>	
				A R	☑ EARING SUP	PORT/LOAD	
		ETOM O	HORD BE	₩			ADING
	R∩	() \/ ' *	1 11	_, ., .,, ,, ∪ ∪ (\ \ \	I I U L I I I		
~				EARING OR DE FLANGE HAN	NGER)		
12)-		ST WEB I		CE FLANGE HAN	NGER)		
12)	I-JOIS	ST WEB I		CE FLANGE HAN	NGER)		

9 CEILING JOIST SCHEDULE
3/4" = 1'-0"

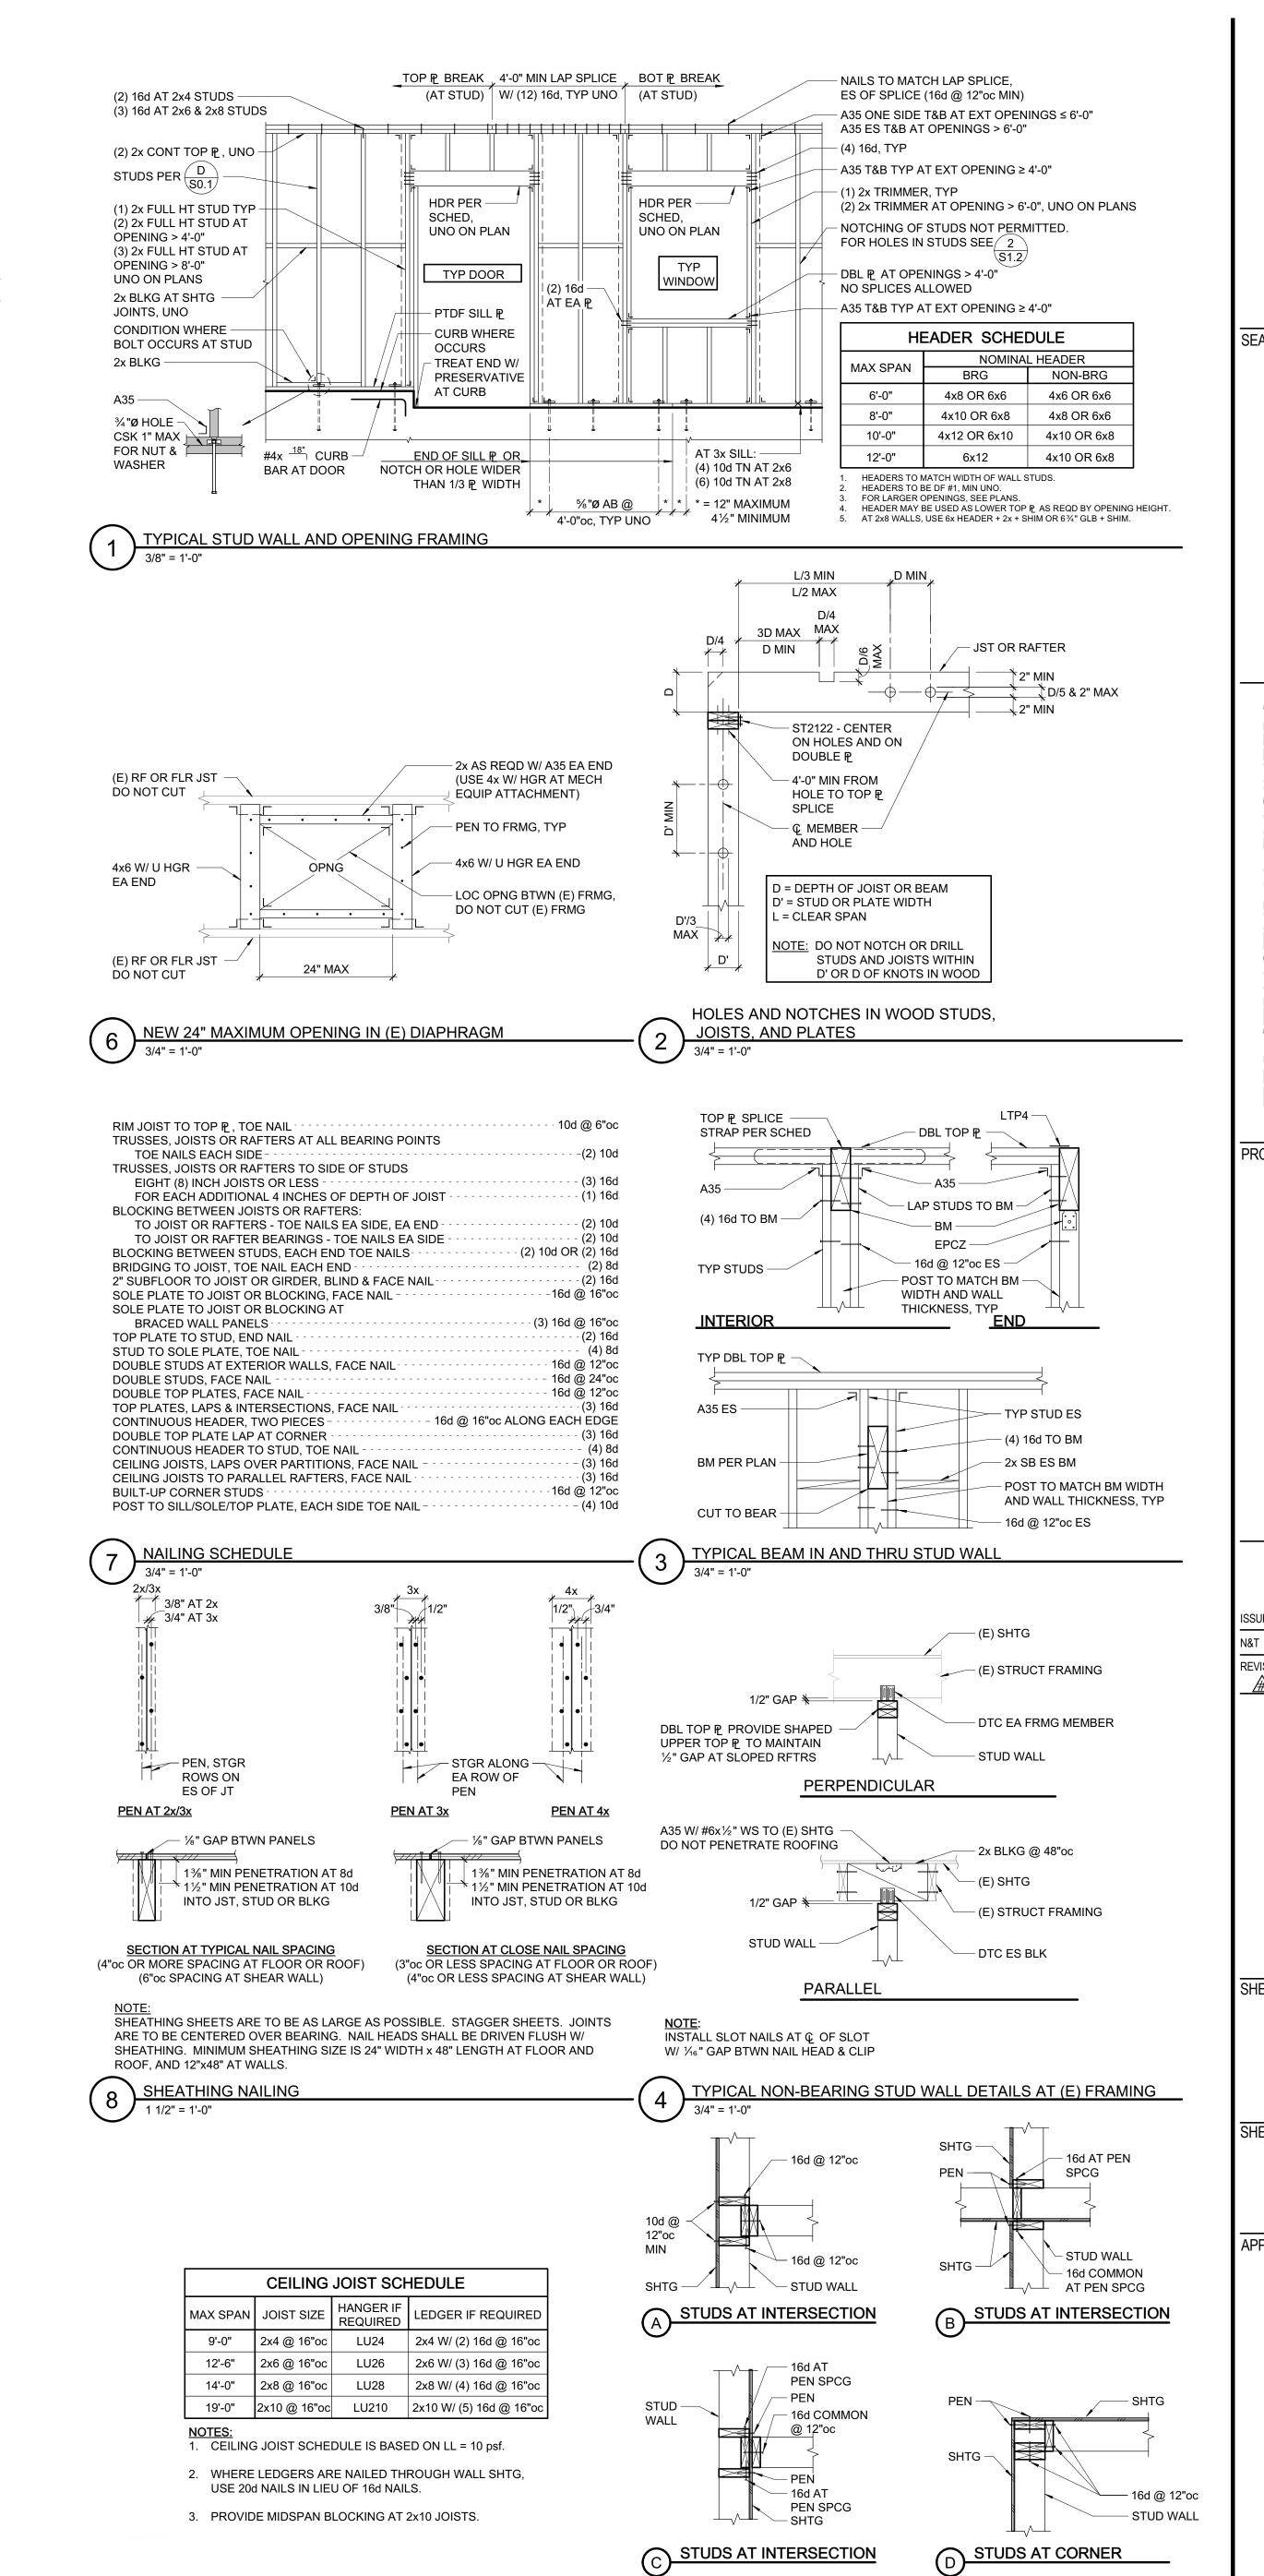


5 TYPICAL PLAN VIEW OF STUD WALL INTERSECTIONS

3/4" = 1'-0"

ARCHITECTS

729 Heinz Avenue Berkeley, CA 94710 tel 510.542.2200 fax 510.542.2201

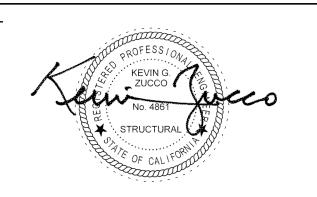

PROJECT TITLE

SONOMA COUNTY PETALUMA REGIONAL RENOVATION PROJECT NO

100 FAIRGROUNDS DRIVE PETALUMA, CA 94952

PERMIT SET

ISSUE DATE 11/27/2023 N&T JOB NUMBER

DESCRIPTION


> REVIEWED FOR CODE COMPLIANCE 05/03/2024 Shums Coda Associates

SHEET TITLE

TYPICAL WOOD DETAILS

SHEET NUMBER

S1.2

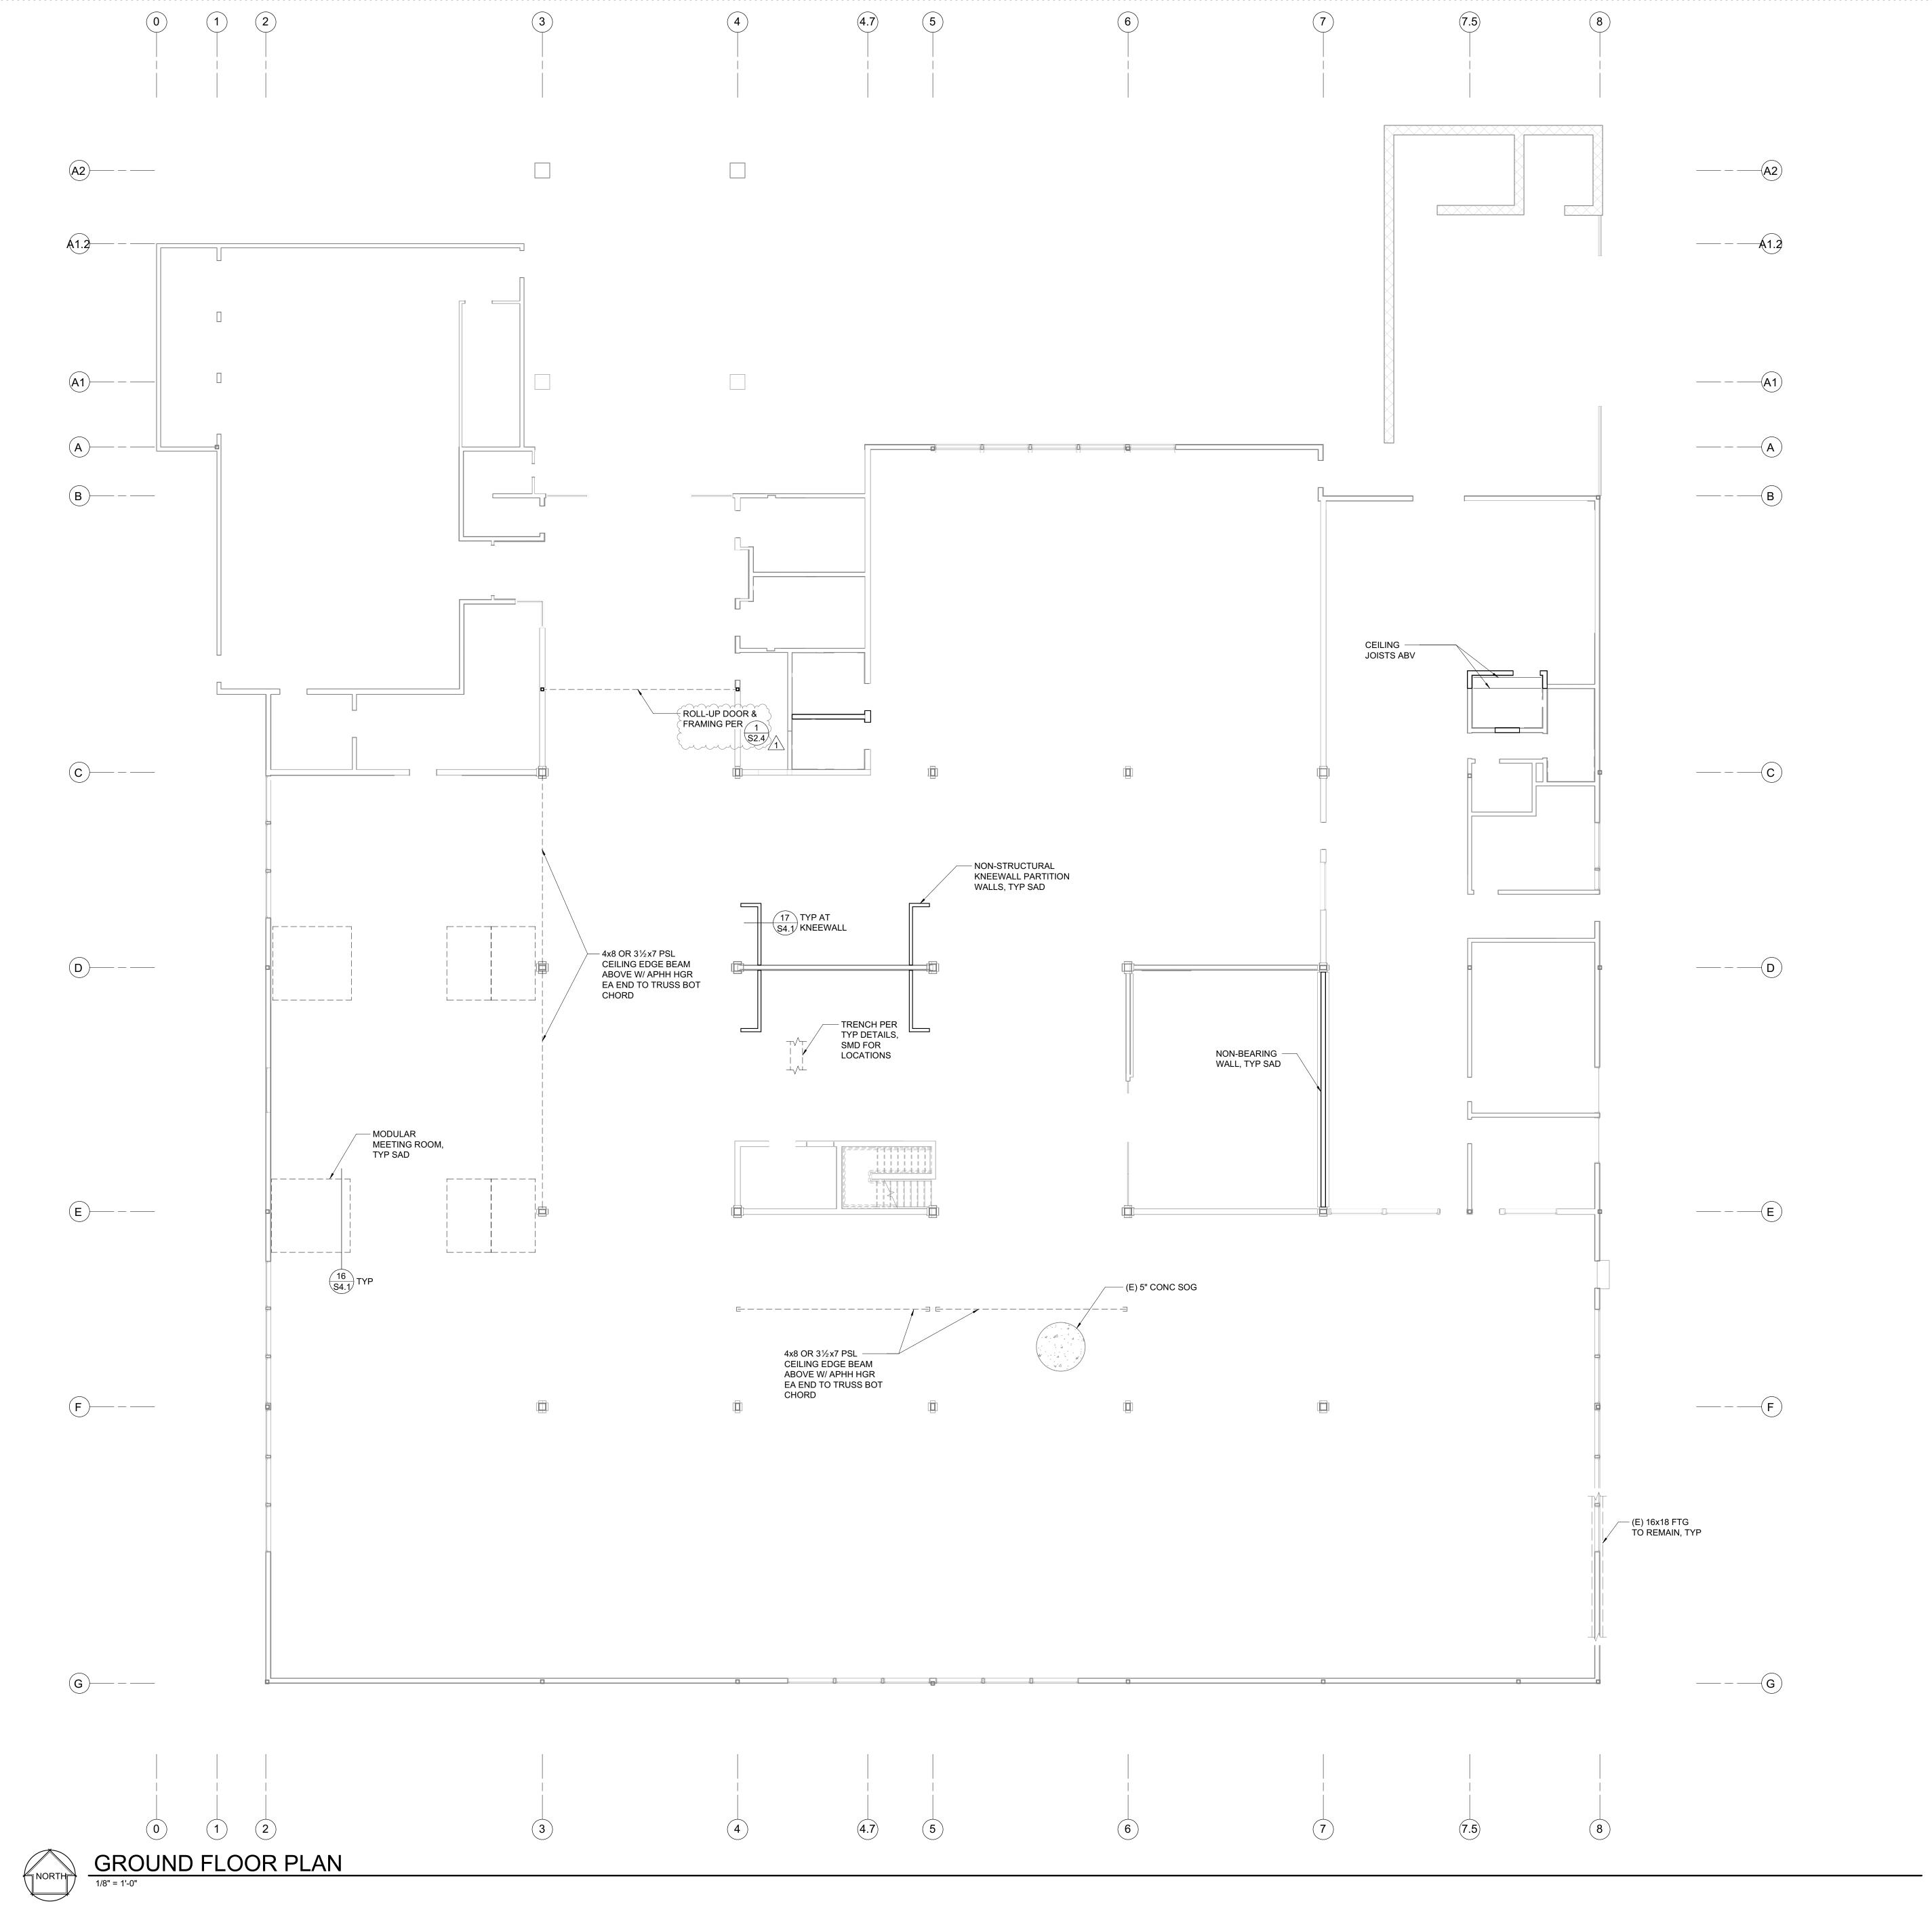

FOUNDATION PLAN NOTES:

- REFER TO SHEETS <u>S0.1</u> THROUGH <u>S1.2</u> FOR GENERAL NOTES AND TYPICAL DETAILS. THE FOLLOWING DETAIL REFERENCES ARE PROVIDED FOR THE CONTRACTOR'S CONVENIENCE ONLY. ALL GENERAL NOTES AND TYPICAL DETAIL SHEETS NOTED ABOVE ARE APPLICABLE AND SHALL BE FOLLOWED.
- DIMENSIONS ARE TO FACE OF STUD UNLESS NOTED OTHERWISE. COORDINATE ALL DIMENSIONS WITH ARCHITECTURAL DRAWINGS PRIOR TO CONSTRUCTION. NOTIFY ARCHITECT/ENGINEER OF ANY DISCREPANCIES.
- 3. ELEVATION OF THE TOP OF FINISHED SLAB = 0'-0", UNLESS NOTED OTHERWISE.


	PLAN LEGEND	
SYMBOL	REFERENCE DETAIL	DESCRIPTION
	<u>1/S1.2</u>	INDICATES NON-STRUCTURAL WALL.
	<u>D/S0.1</u>	INDICATES (E) WOOD POST.
0, □, ፲		INDICATES STEEL COLUMN.
88		INDICATES GRIDLINE.
		INDICATES EXISTING FRAMING.



729 Heinz Avenue

Berkeley, CA 94710 tel 510.542.2200

fax 510.542.2201

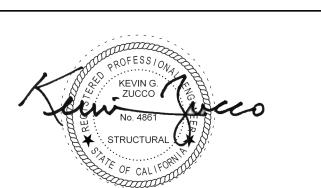

PROJECT TITLE

PETALUMA
REGIONAL
LIBRARY
RENOVATION
PROJECT NO.
10-19

100 FAIRGROUNDS DRIVE PETALUMA, CA 94952

PERMIT SET

ISSUE DATE

N&T JOB NUMBER

REVISIONS

DATE

DESCRIPTION

1 1/23/2024 PLAN CHECK RESPONSE

REVIEWED FOR CODE COMPLIANCE

05/03/2024


Shums Coda Associates

HEET TITLE


FOUNDATION PLAN

SHEET NUMBER


S2.1

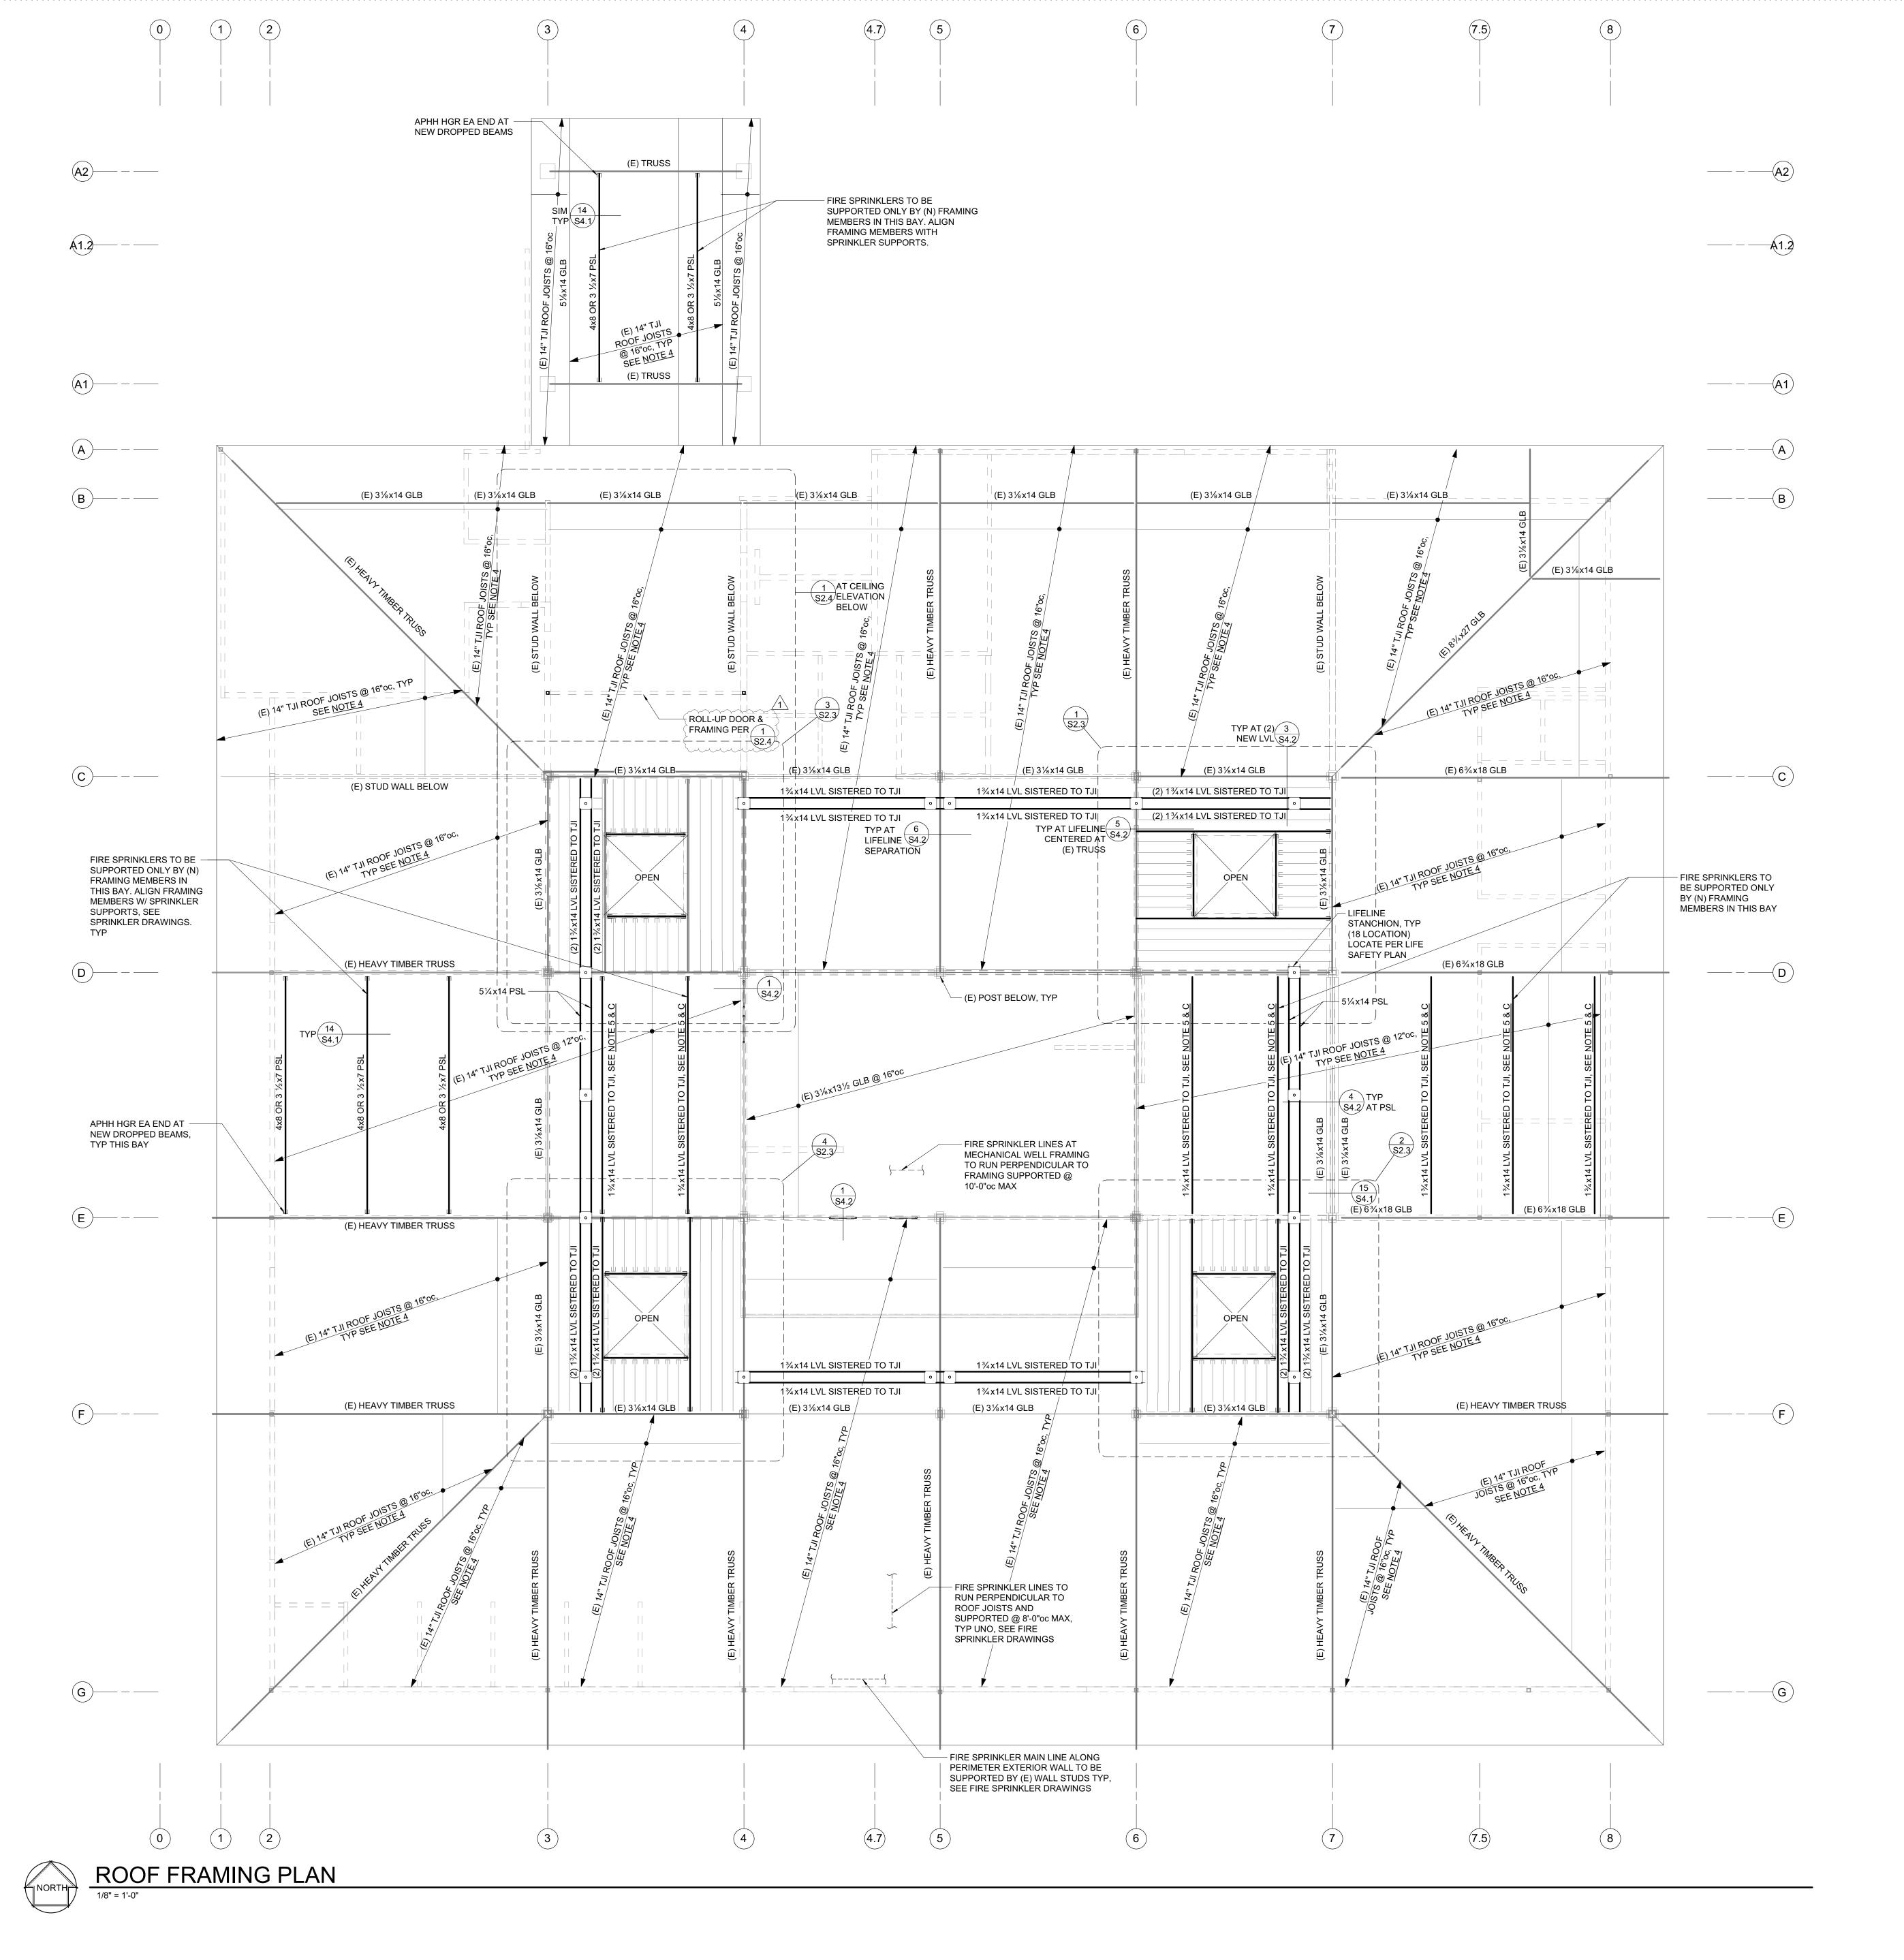

- REFER TO SHEETS <u>\$0.1</u> THROUGH <u>\$1.2</u> FOR GENERAL NOTES AND TYPICAL DETAILS. ALL GENERAL NOTES AND TYPICAL DETAIL SHEETS NOTED ABOVE ARE APPLICABLE AND SHALL BE FOLLOWED.
- 2. DIMENSIONS ARE TO FACE OF STUD UNLESS NOTED OTHERWISE. COORDINATE ALL DIMENSIONS WITH ARCHITECTURAL DRAWINGS PRIOR TO CONSTRUCTION. NOTIFY ARCHITECT/ENGINEER OF ANY DISCREPANCIES.
- 3. EXISTING FRAMING ONLY SHOWN AT AREAS OF CONSTRUCTION.
- 4. 14" TJI ASSUMED GEOMETRY SHOWN BELOW. CONTRACTOR TO VERIFY DIMENSIONS AND GRADE, IN FIELD PRIOR TO START OF INSTALLATION OF FIRE SPRINKLERS. REPORT FINDINGS TO SEOR FOR REVIEW AND APPROVAL.

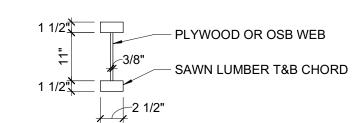

5. FOR LVL SISTERED TO TJI CONNECTION SEE BELOW:

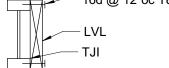


PLAN LEGEND						
SYMBOL	REFERENCE DETAIL	DESCRIPTION				
====		INDICATES (E) WALL BELOW.				
\boxtimes	<u>D/S0.1</u>	INDICATES (E) WOOD POST.				
====		INDICATES WALL BELOW.				
0, □, ፲		INDICATES STEEL COLUMN.				
<u></u>	<u>8/S1.2</u>	INDICATES PANEL EDGE NAILING ALONG FULL LENGTH OF MEMBER.				
	<u>D/S0.1</u>	INDICATES HANGER.				
88		INDICATES GRIDLINE.				
		INDICATES STEP IN ELEVATION, SEE ARCHITECTURAL DRAWINGS.				
A 4'-0"	<u>10/S1.2</u>	INDICATES TIE STRAP. SEE SCHEDULE FOR STRAP, NAILING AND LENGTH.				

FIRE SPRINKLER NOTES:

- A. PRIOR TO INSTALLATION OF FIRE SPRINKLER PIPING SUPPORTS, CONTRACTOR TO VERIFY FRAMING MEMBER SIZES AND ORIENTATION ARE AS SHOWN. SEE ALSO FRAMING PLAN NOTES, NOTE 4.
- B. REFER TO FIRE SPRINKLER DESIGN DRAWINGS FOR LAYOUT AND SIZE OF FIRE SPRINKLERS AND SUPPORTS, CONNECTIONS TO STRUCTURE, AND BRACING
- C. AT LVL FRAMING, DO NOT CONNECT FIRE SPRINKLER SUPPORT TO NARROW EDGE OF MEMBER.
- D. FIRE SPRINKLER PIPING TO BE SUPPORTED BY EXISTING FRAMING THAT RUNS PERPENDICULAR TO PIPING EXCEPT AT THE MEZZANINE FLOOR FRAMING OR UNLESS NOTED OTHERWISE.
- E. MAXIMUM SPRINKLER LINE SIZE ATTACHED TO EXISTING ROOF FRAMING=11/4" Ø. ALL LARGER SPRINKLER PIPES SHALL BE SUPPORTED FROM WALL FRAMING (OR AT MEZZANINE FLOOR FRAMING, SEE NOTE F).
- F. AT MEZZANINE FLOOR, SPRINKLER PIPES OF ANY SIZE UP TO 4" MAY RUN PARALLEL OR PERPENDICULAR TO EXISTING FLOOR FRAMING MEMBERS WITH MAX SUPPORT SPACING AT 10'-0"oc.
- G. DIAGONAL SEISMIC BRACING OF SPRINKLER PIPES SHALL ONLY CONNECT TO EXISTING GLULAM GIRDERS OR HEAVY TIMBER TRUSSES.

729 Heinz Avenue Berkeley, CA 94710 tel 510.542.2200 fax 510.542.2201

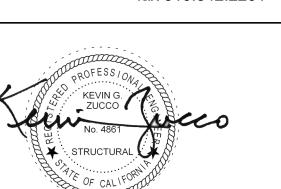

PROJECT TITLE

SONOMA COUNTY PETALUMA REGIONAL LIBRARY RENOVATION PROJECT NO.

100 FAIRGROUNDS DRIVE PETALUMA, CA 94952

PERMIT SET


ISSUE DATE N&T JOB NUMBER DESCRIPTION 1 1/23/2024 PLAN CHECK RESPONSE

> REVIEWED FOR CODE COMPLIANCE 05/03/2024 Shums Coda Associates


ROOF FRAMING PLAN

SHEET NUMBER

S2.2

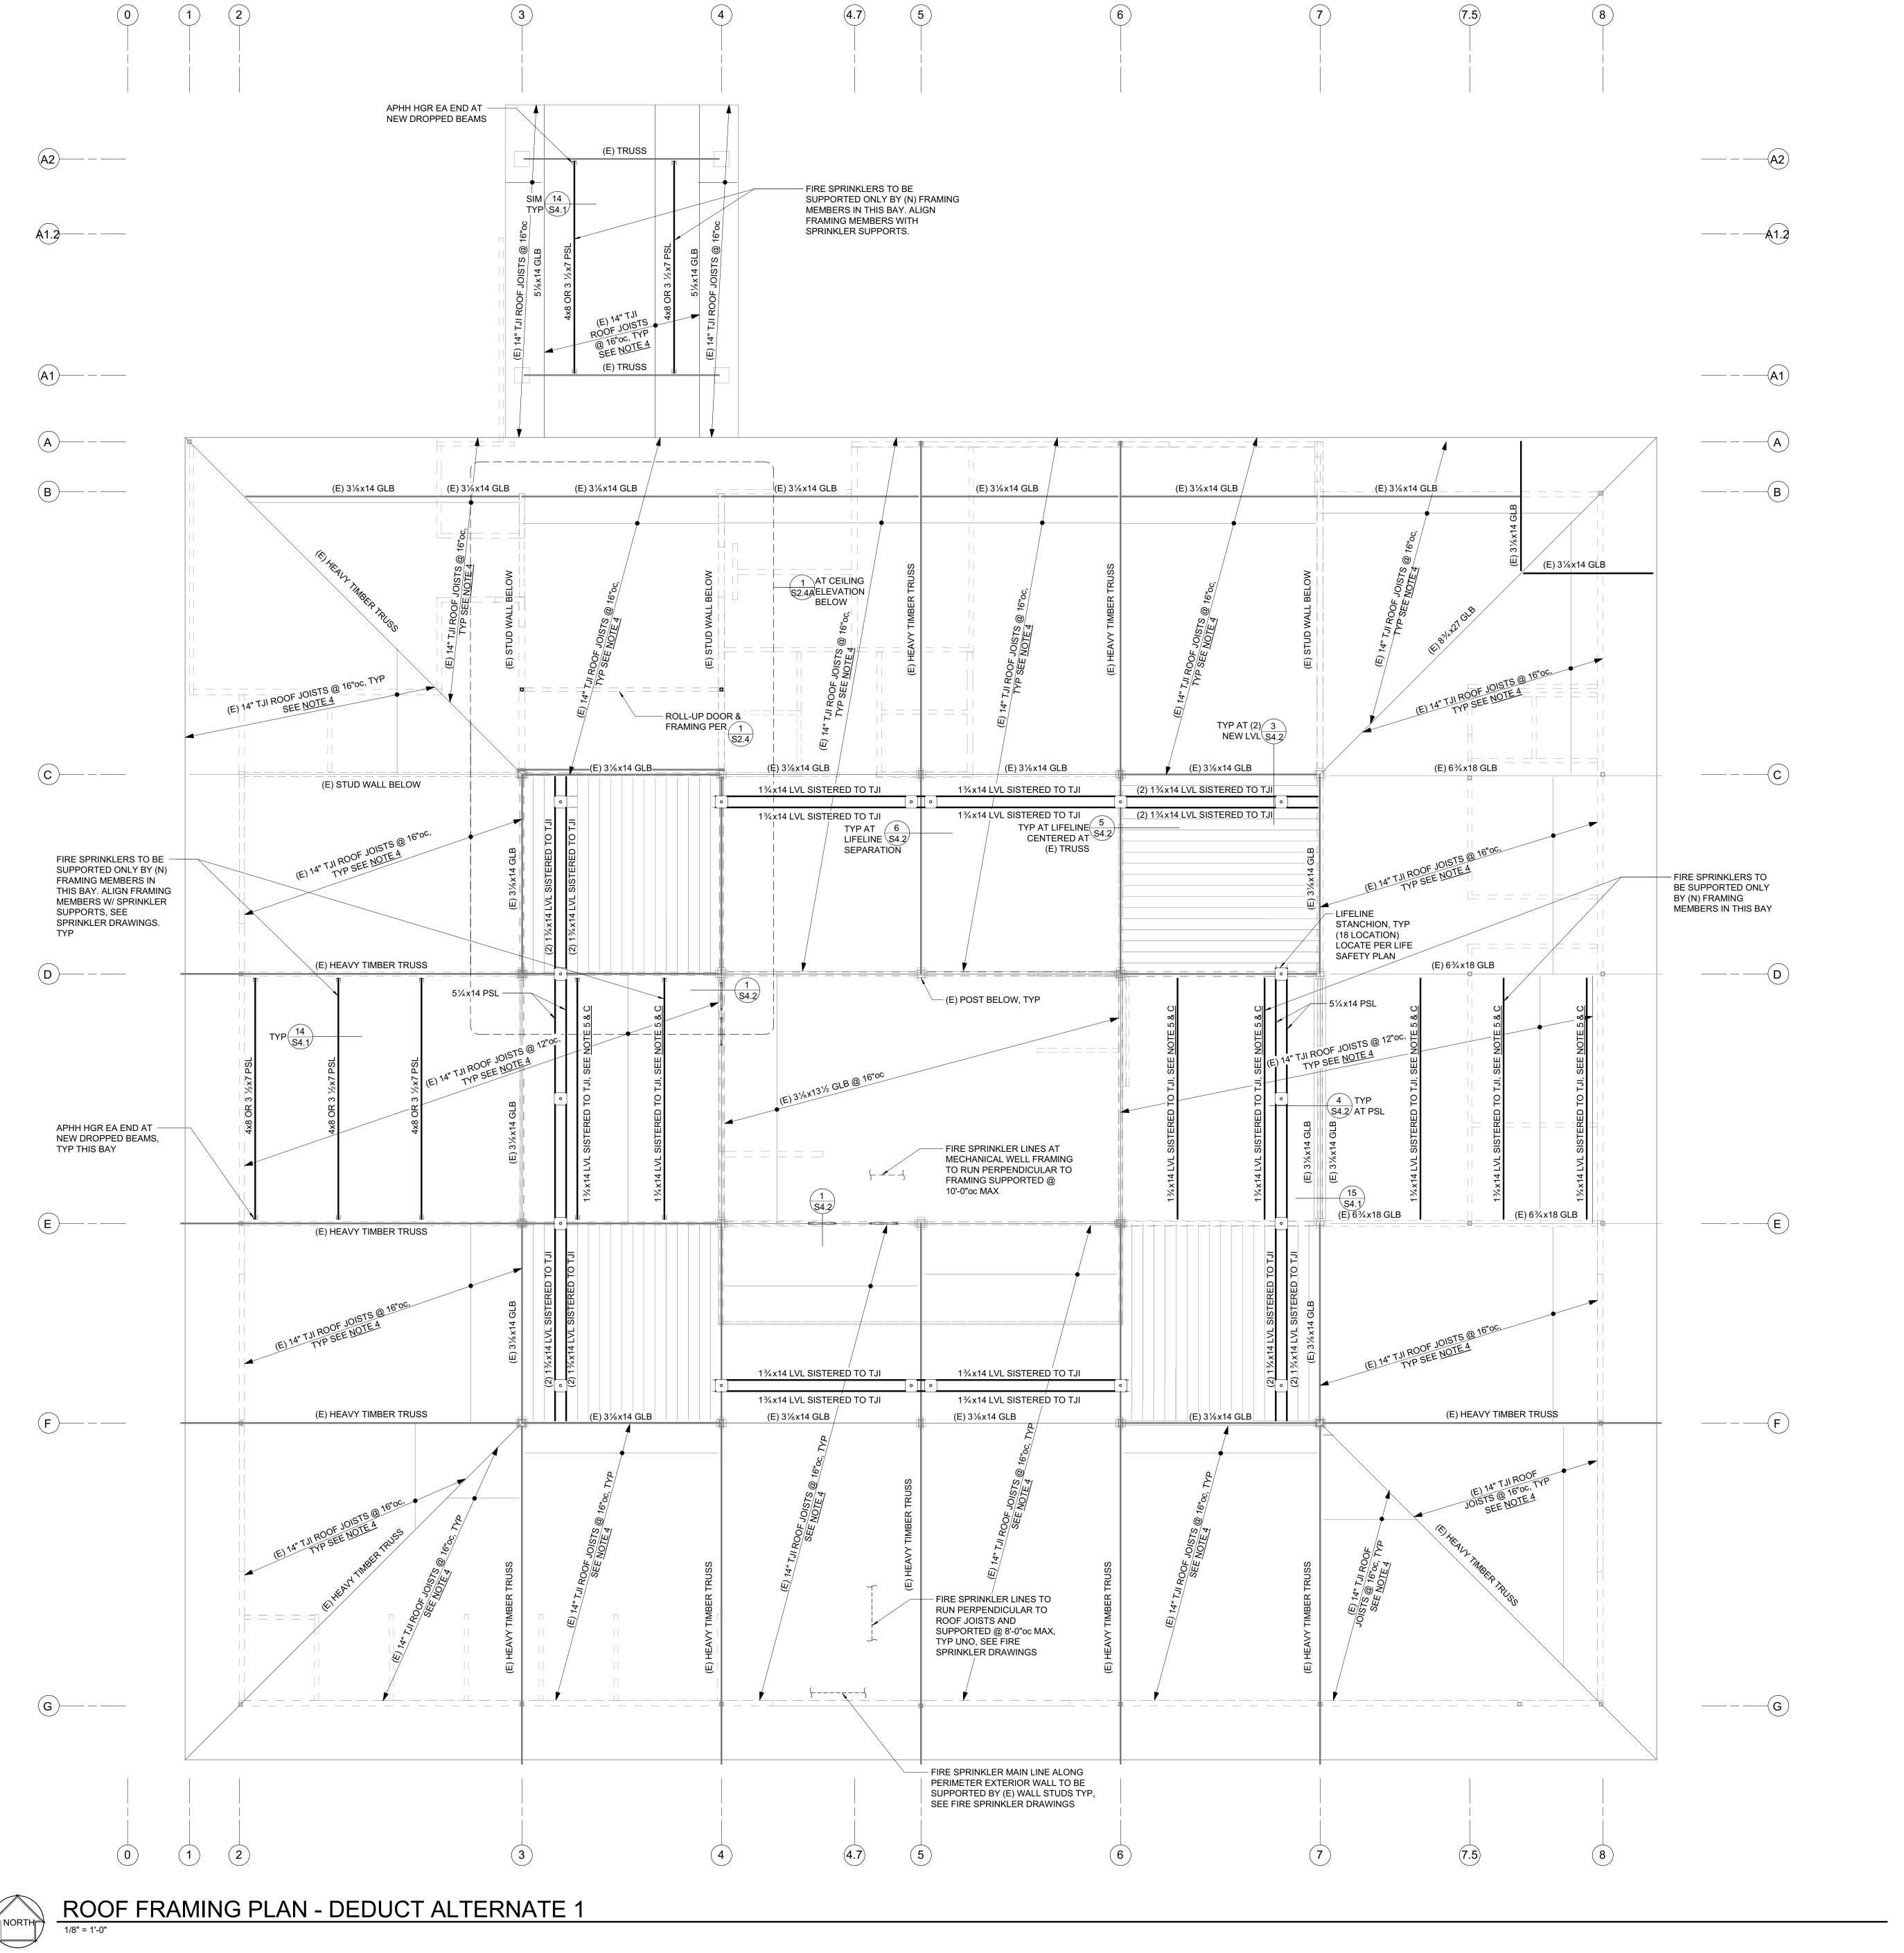

- REFER TO SHEETS <u>S0.1</u> THROUGH <u>S1.2</u> FOR GENERAL NOTES AND TYPICAL DETAILS. ALL GENERAL NOTES AND TYPICAL DETAIL SHEETS NOTED ABOVE ARE APPLICABLE AND SHALL BE FOLLOWED.
- DIMENSIONS ARE TO FACE OF STUD UNLESS NOTED OTHERWISE. COORDINATE ALL DIMENSIONS WITH ARCHITECTURAL DRAWINGS PRIOR TO CONSTRUCTION. NOTIFY ARCHITECT/ENGINEER OF ANY DISCREPANCIES.
- 3. EXISTING FRAMING ONLY SHOWN AT AREAS OF CONSTRUCTION.
- 14" TJI ASSUMED GEOMETRY SHOWN BELOW. CONTRACTOR TO VERIFY DIMENSIONS AND GRADE, IN FIELD PRIOR TO START OF INSTALLATION OF FIRE SPRINKLERS. REPORT FINDINGS TO SEOR FOR REVIEW AND APPROVAL.

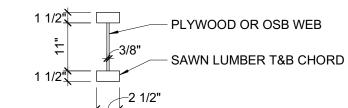

5. FOR LVL SISTERED TO TJI CONNECTION SEE BELOW:

LVL TJI

		PLAN LEGEND
SYMBOL	REFERENCE DETAIL	DESCRIPTION
		INDICATES (E) WALL BELOW.
\boxtimes	<u>D/S0.1</u>	INDICATES (E) WOOD POST.
1111		INDICATES WALL BELOW.
0, 🗆 , 📘		INDICATES STEEL COLUMN.
<u></u>	<u>8/S1.2</u>	INDICATES PANEL EDGE NAILING ALONG FULL LENGTH OF MEMBER.
E	<u>D/S0.1</u>	INDICATES HANGER.
88—		INDICATES GRIDLINE.
		INDICATES STEP IN ELEVATION, SEE ARCHITECTURAL DRAWINGS.
A 4'-0"	<u>10/S1.2</u>	INDICATES TIE STRAP. SEE SCHEDULE FOR STRAP, NAILING AND LENGTH.

FIRE SPRINKLER NOTES:

- A. PRIOR TO INSTALLATION OF FIRE SPRINKLER PIPING SUPPORTS, CONTRACTOR TO VERIFY FRAMING MEMBER SIZES AND ORIENTATION ARE AS SHOWN. SEE ALSO FRAMING PLAN NOTES, NOTE 4.
- B. REFER TO FIRE SPRINKLER DESIGN DRAWINGS FOR LAYOUT AND SIZE OF FIRE SPRINKLERS AND SUPPORTS, CONNECTIONS TO STRUCTURE, AND BRACING INFORMATION.
- C. AT LVL FRAMING, DO NOT CONNECT FIRE SPRINKLER SUPPORT TO NARROW EDGE OF MEMBER.
- D. FIRE SPRINKLER PIPING TO BE SUPPORTED BY EXISTING FRAMING THAT RUNS PERPENDICULAR TO PIPING EXCEPT AT THE MEZZANINE FLOOR FRAMING OR UNLESS NOTED OTHERWISE.
- E. MAXIMUM SPRINKLER LINE SIZE ATTACHED TO EXISTING ROOF FRAMING=1¼" Ø. ALL LARGER SPRINKLER PIPES SHALL BE SUPPORTED FROM WALL FRAMING (OR AT MEZZANINE FLOOR FRAMING, SEE NOTE F).
- F. AT MEZZANINE FLOOR, SPRINKLER PIPES OF ANY SIZE UP TO 4" MAY RUN PARALLEL OR PERPENDICULAR TO EXISTING FLOOR FRAMING MEMBERS WITH MAX SUPPORT SPACING AT 10'-0"oc.
- G. DIAGONAL SEISMIC BRACING OF SPRINKLER PIPES SHALL ONLY CONNECT TO EXISTING GLULAM GIRDERS OR HEAVY TIMBER TRUSSES.

NULL & TAM

> 729 Heinz Avenue Berkeley, CA 94710

tel 510.542.2200 fax 510.542.2201



PROJECT TITLE

PETALUMA
REGIONAL
LIBRARY
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10-19

100 FAIRGROUNDS DRIVE PETALUMA, CA 94952

PERMIT SET

ISSUE DATE 11/20
N&T JOB NUMBER 2

2 4/24/24 DEDUCT ALTERNATES

REVIEWED FOR CODE COMPLIANCE

05/03/2024


Shums Coda Associates

SHEET TITLE


ROOF FRAMING PLAN -DEDUCT ALTERNATE 1

SHEET NUMBER

S2.2A

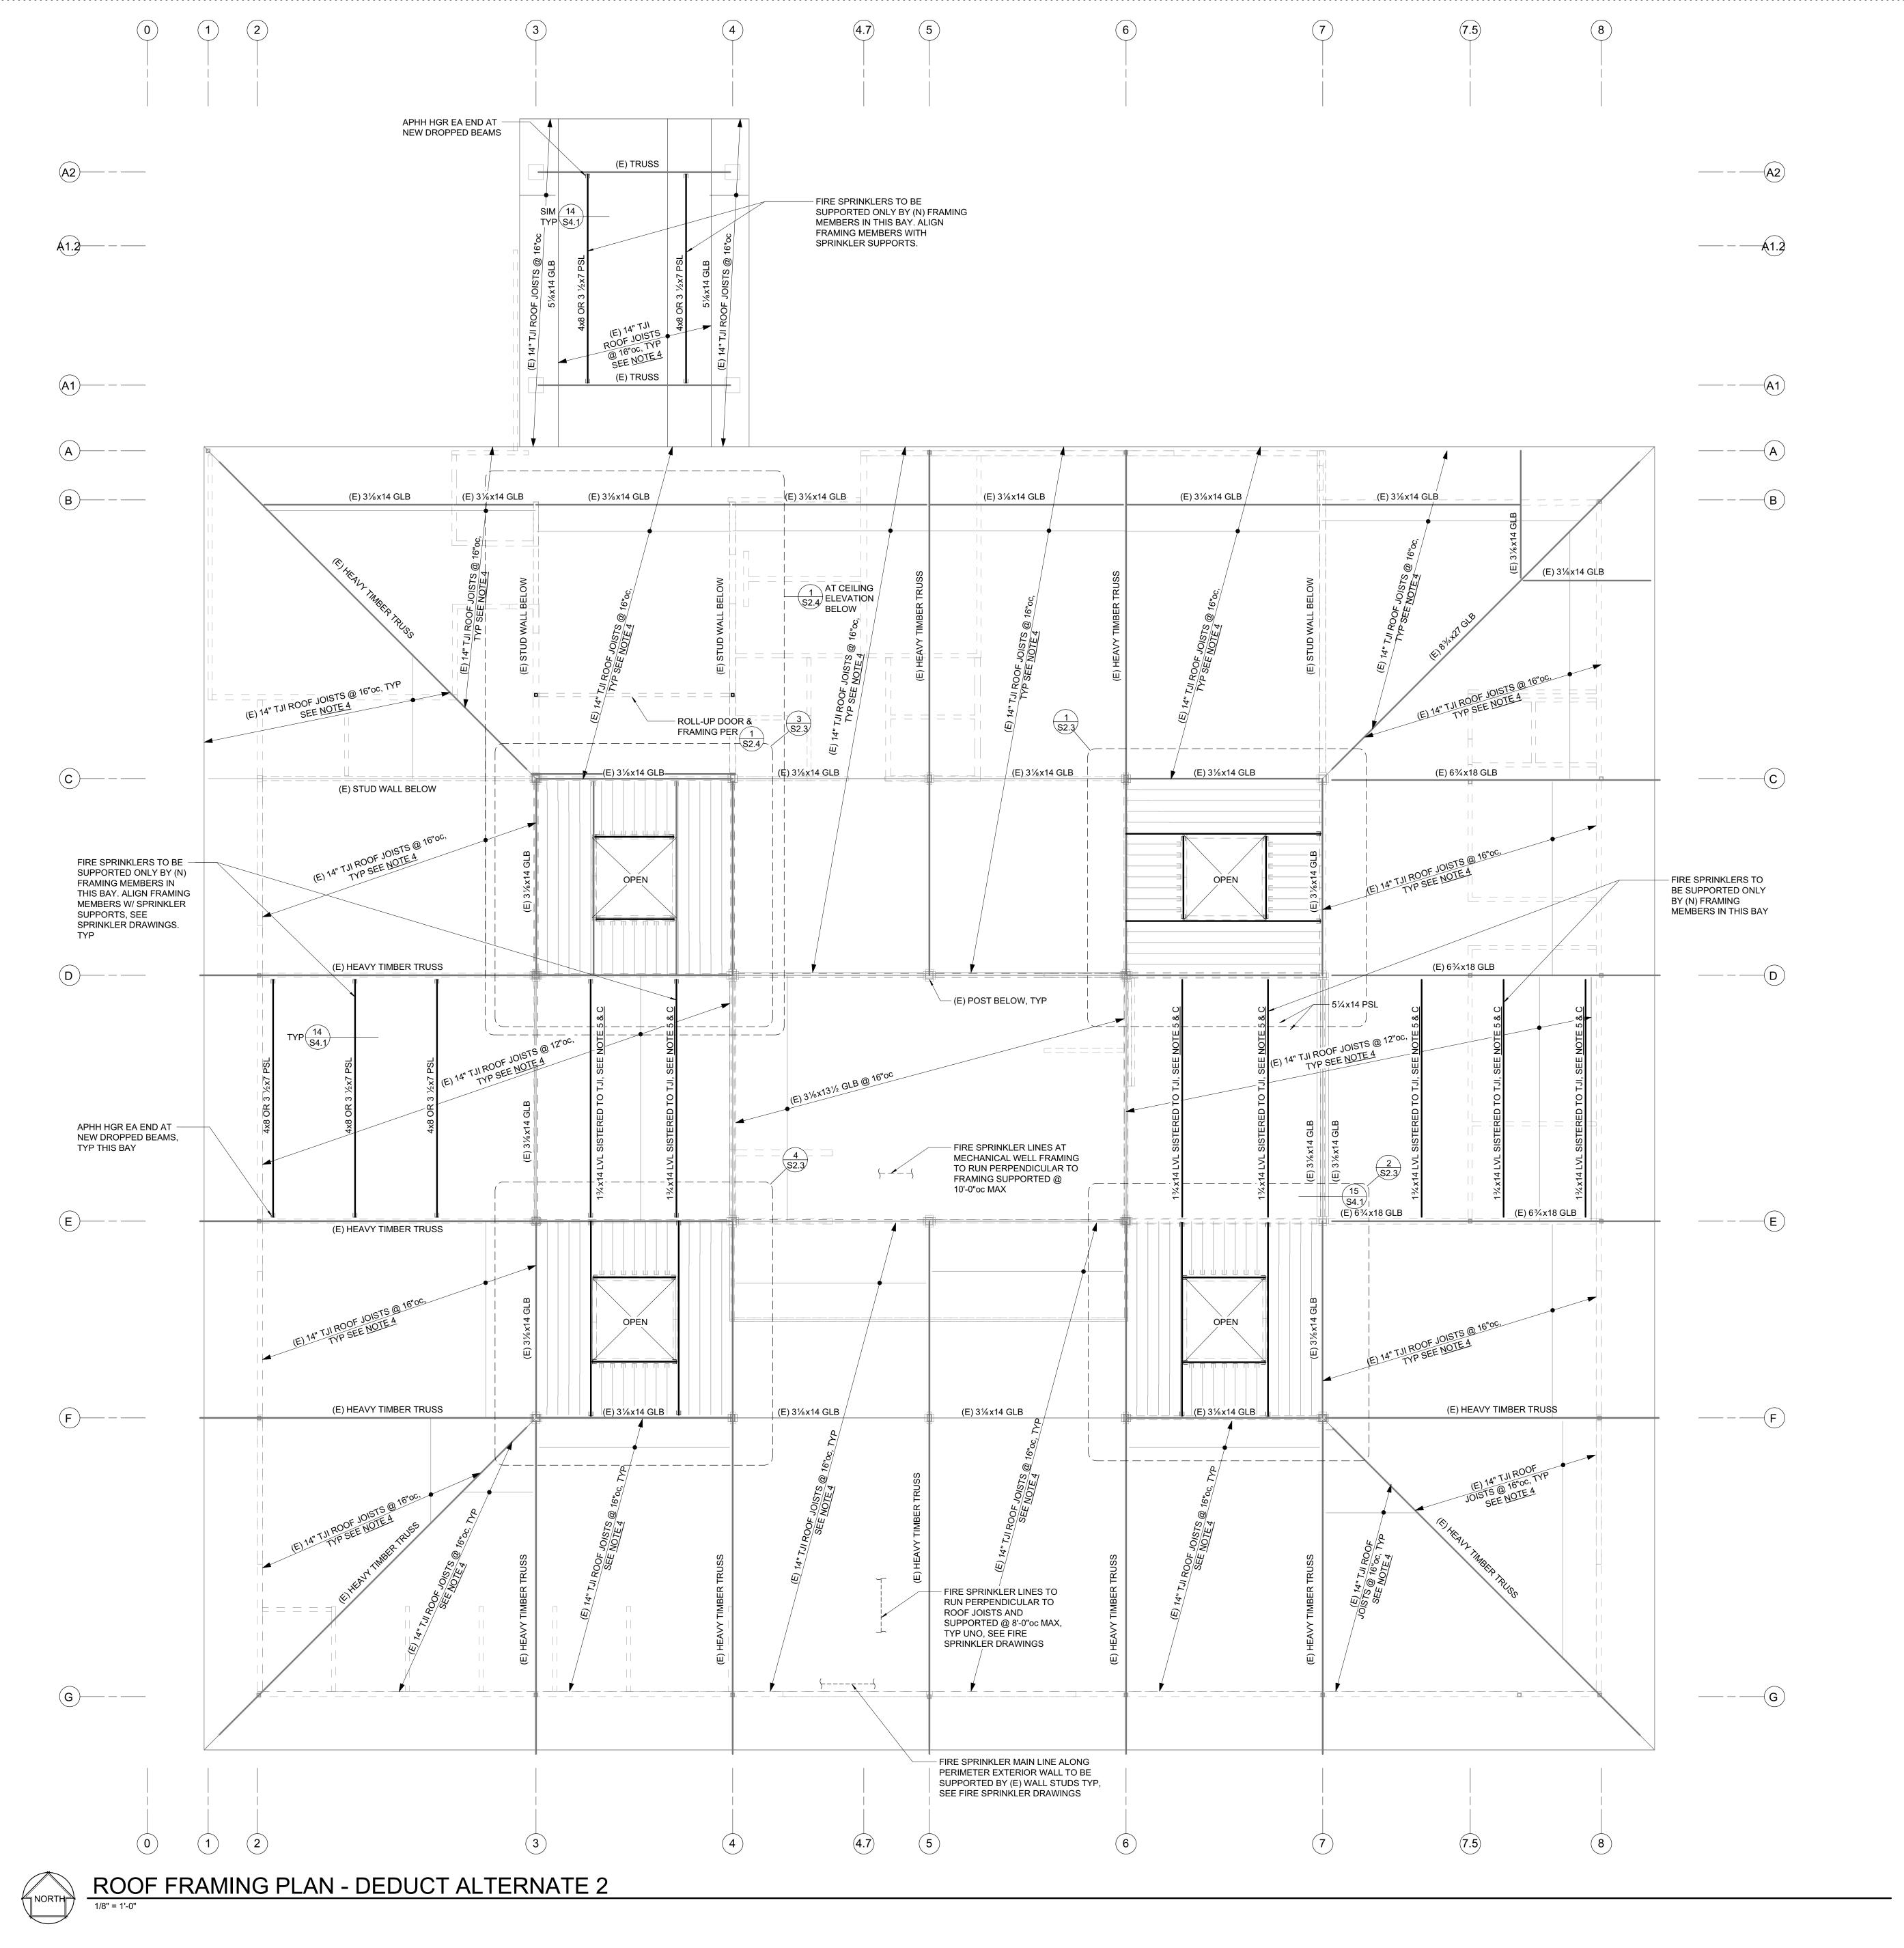

- REFER TO SHEETS <u>S0.1</u> THROUGH <u>S1.2</u> FOR GENERAL NOTES AND TYPICAL DETAILS. ALL GENERAL NOTES AND TYPICAL DETAIL SHEETS NOTED ABOVE ARE APPLICABLE AND SHALL BE FOLLOWED.
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5. FOR LVL SISTERED TO TJI CONNECTION SEE BELOW:

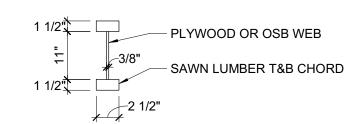16d @ 12"oc T&B

LVL

TJI

PLAN LEGEND							
SYMBOL	REFERENCE DETAIL	DESCRIPTION					
====		INDICATES (E) WALL BELOW.					
	<u>D/S0.1</u>	INDICATES (E) WOOD POST.					
====	==== INDICATES WALL BELOW.						
0, 🗆 , 📘		INDICATES STEEL COLUMN.					
<u></u>	<u>8/S1.2</u>	INDICATES PANEL EDGE NAILING ALONG FULL LENGTH OF MEMBER.					
E	<u>D/S0.1</u>	INDICATES HANGER.					
88		INDICATES GRIDLINE.					
INDICATES STEP IN ELEVATION, SEE ARCHITECTURAL DRAWINGS.							
A 4'-0"	<u>10/S1.2</u>	INDICATES TIE STRAP. SEE SCHEDULE FOR STRAP, NAILING AND LENGTH.					

FIRE SPRINKLER NOTES:

- A. PRIOR TO INSTALLATION OF FIRE SPRINKLER PIPING SUPPORTS, CONTRACTOR TO VERIFY FRAMING MEMBER SIZES AND ORIENTATION ARE AS SHOWN. SEE ALSO FRAMING PLAN NOTES, NOTE 4.
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- F. AT MEZZANINE FLOOR, SPRINKLER PIPES OF ANY SIZE UP TO 4" MAY RUN PARALLEL OR PERPENDICULAR TO EXISTING FLOOR FRAMING MEMBERS WITH MAX SUPPORT SPACING AT 10'-0"oc.
- G. DIAGONAL SEISMIC BRACING OF SPRINKLER PIPES SHALL ONLY CONNECT TO EXISTING GLULAM GIRDERS OR HEAVY TIMBER TRUSSES.

NULL & TAM ARCHITECTS

> 729 Heinz Avenue Berkeley, CA 94710 tel 510.542.2200 fax 510.542.2201

tel 510.542.2200 fax 510.542.2201



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PROJECT TITLE

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PROJECT NO.
10-19

100 FAIRGROUNDS DRIVE PETALUMA, CA 94952

PERMIT SET

ISSUE DATE

N&T JOB NUMBER

REVISIONS

DATE

DESCRIPTION

2 4/24/24 DEDUCT ALTERNATES

REVIEWED FOR CODE COMPLIANCE

05/03/2024


Shums Coda Associates

SHEET TITLE

ROOF FRAMING PLAN -DEDUCT ALTERNATE 2


SHEET NUMBER

S2.2B

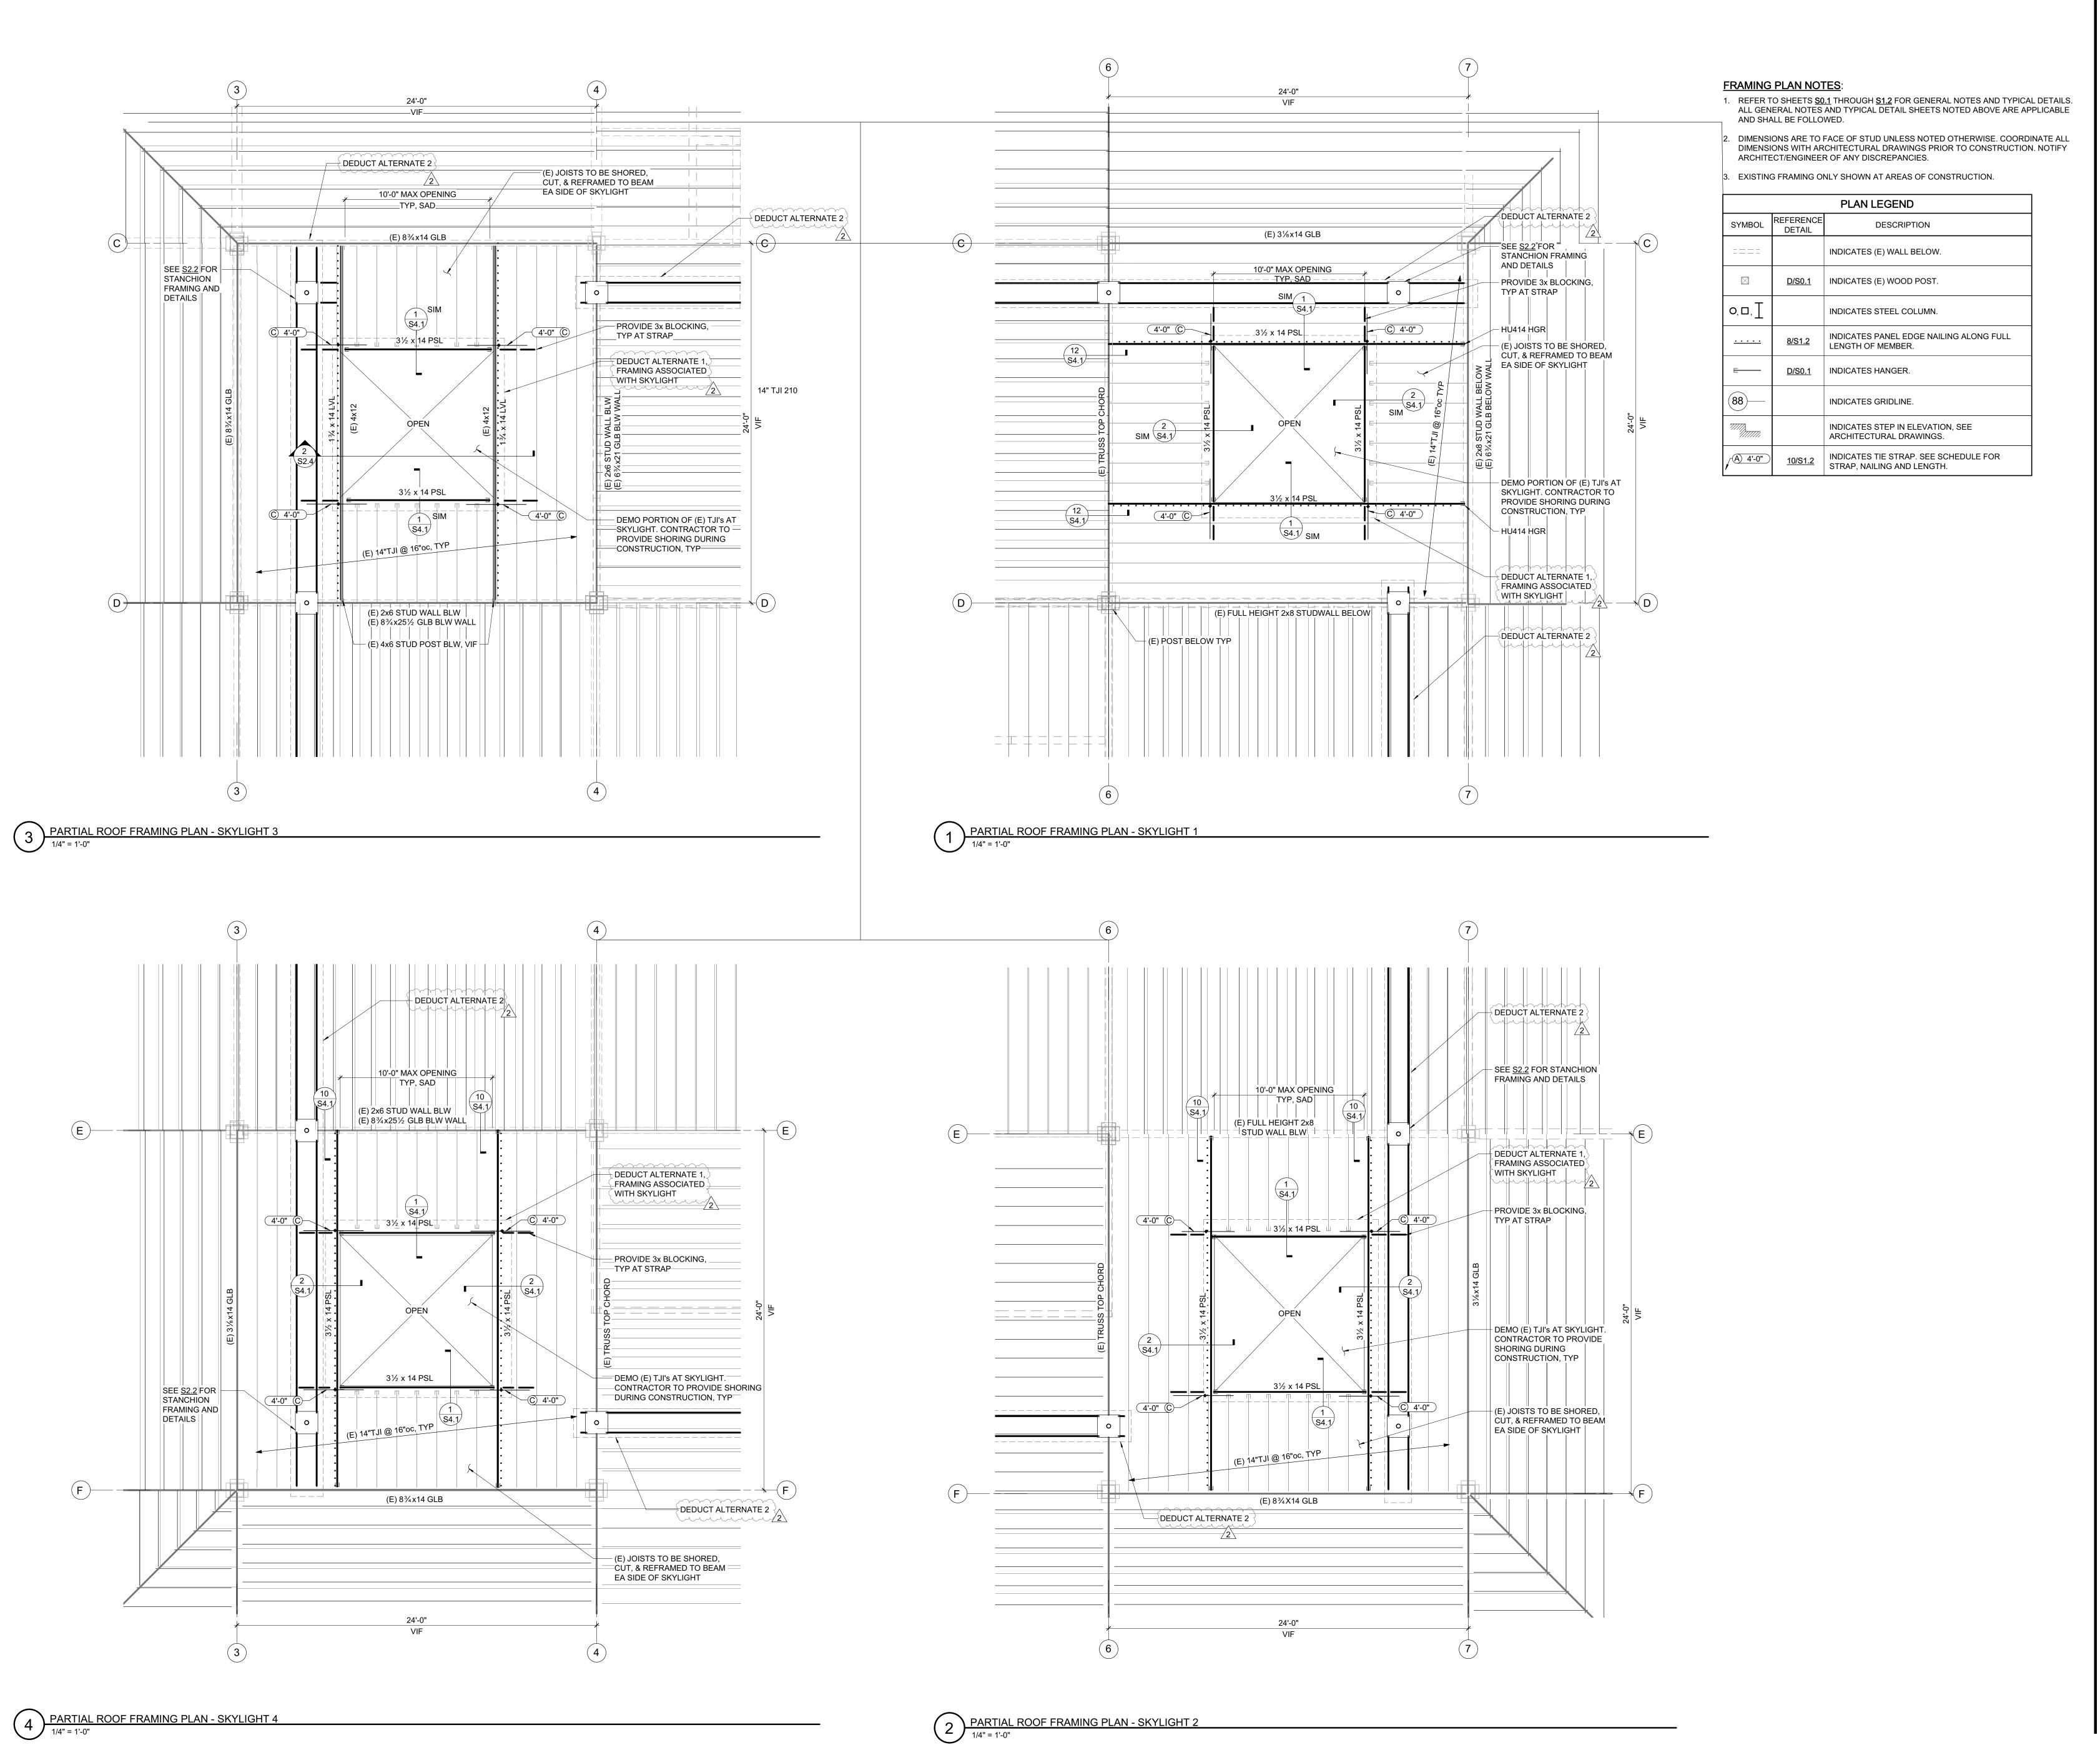

NOLL & TAM ARCHITECTS

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san francisco ca 94111 415.243.403
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PROJECT TITLE
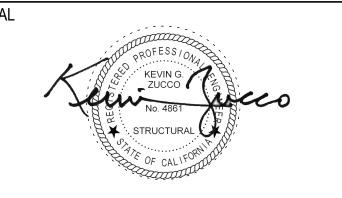
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PROJECT NO.
10-19

100 FAIRGROUNDS DRIVE PETALUMA, CA 94952

PERMIT SET

REVIEWED FOR CODE COMPLIANCE

05/03/2024


Shums Coda Associates


SHEET TITLE

PARTIAL ROOF FRAMING PLANS

SHEET NUMBER


S2.3

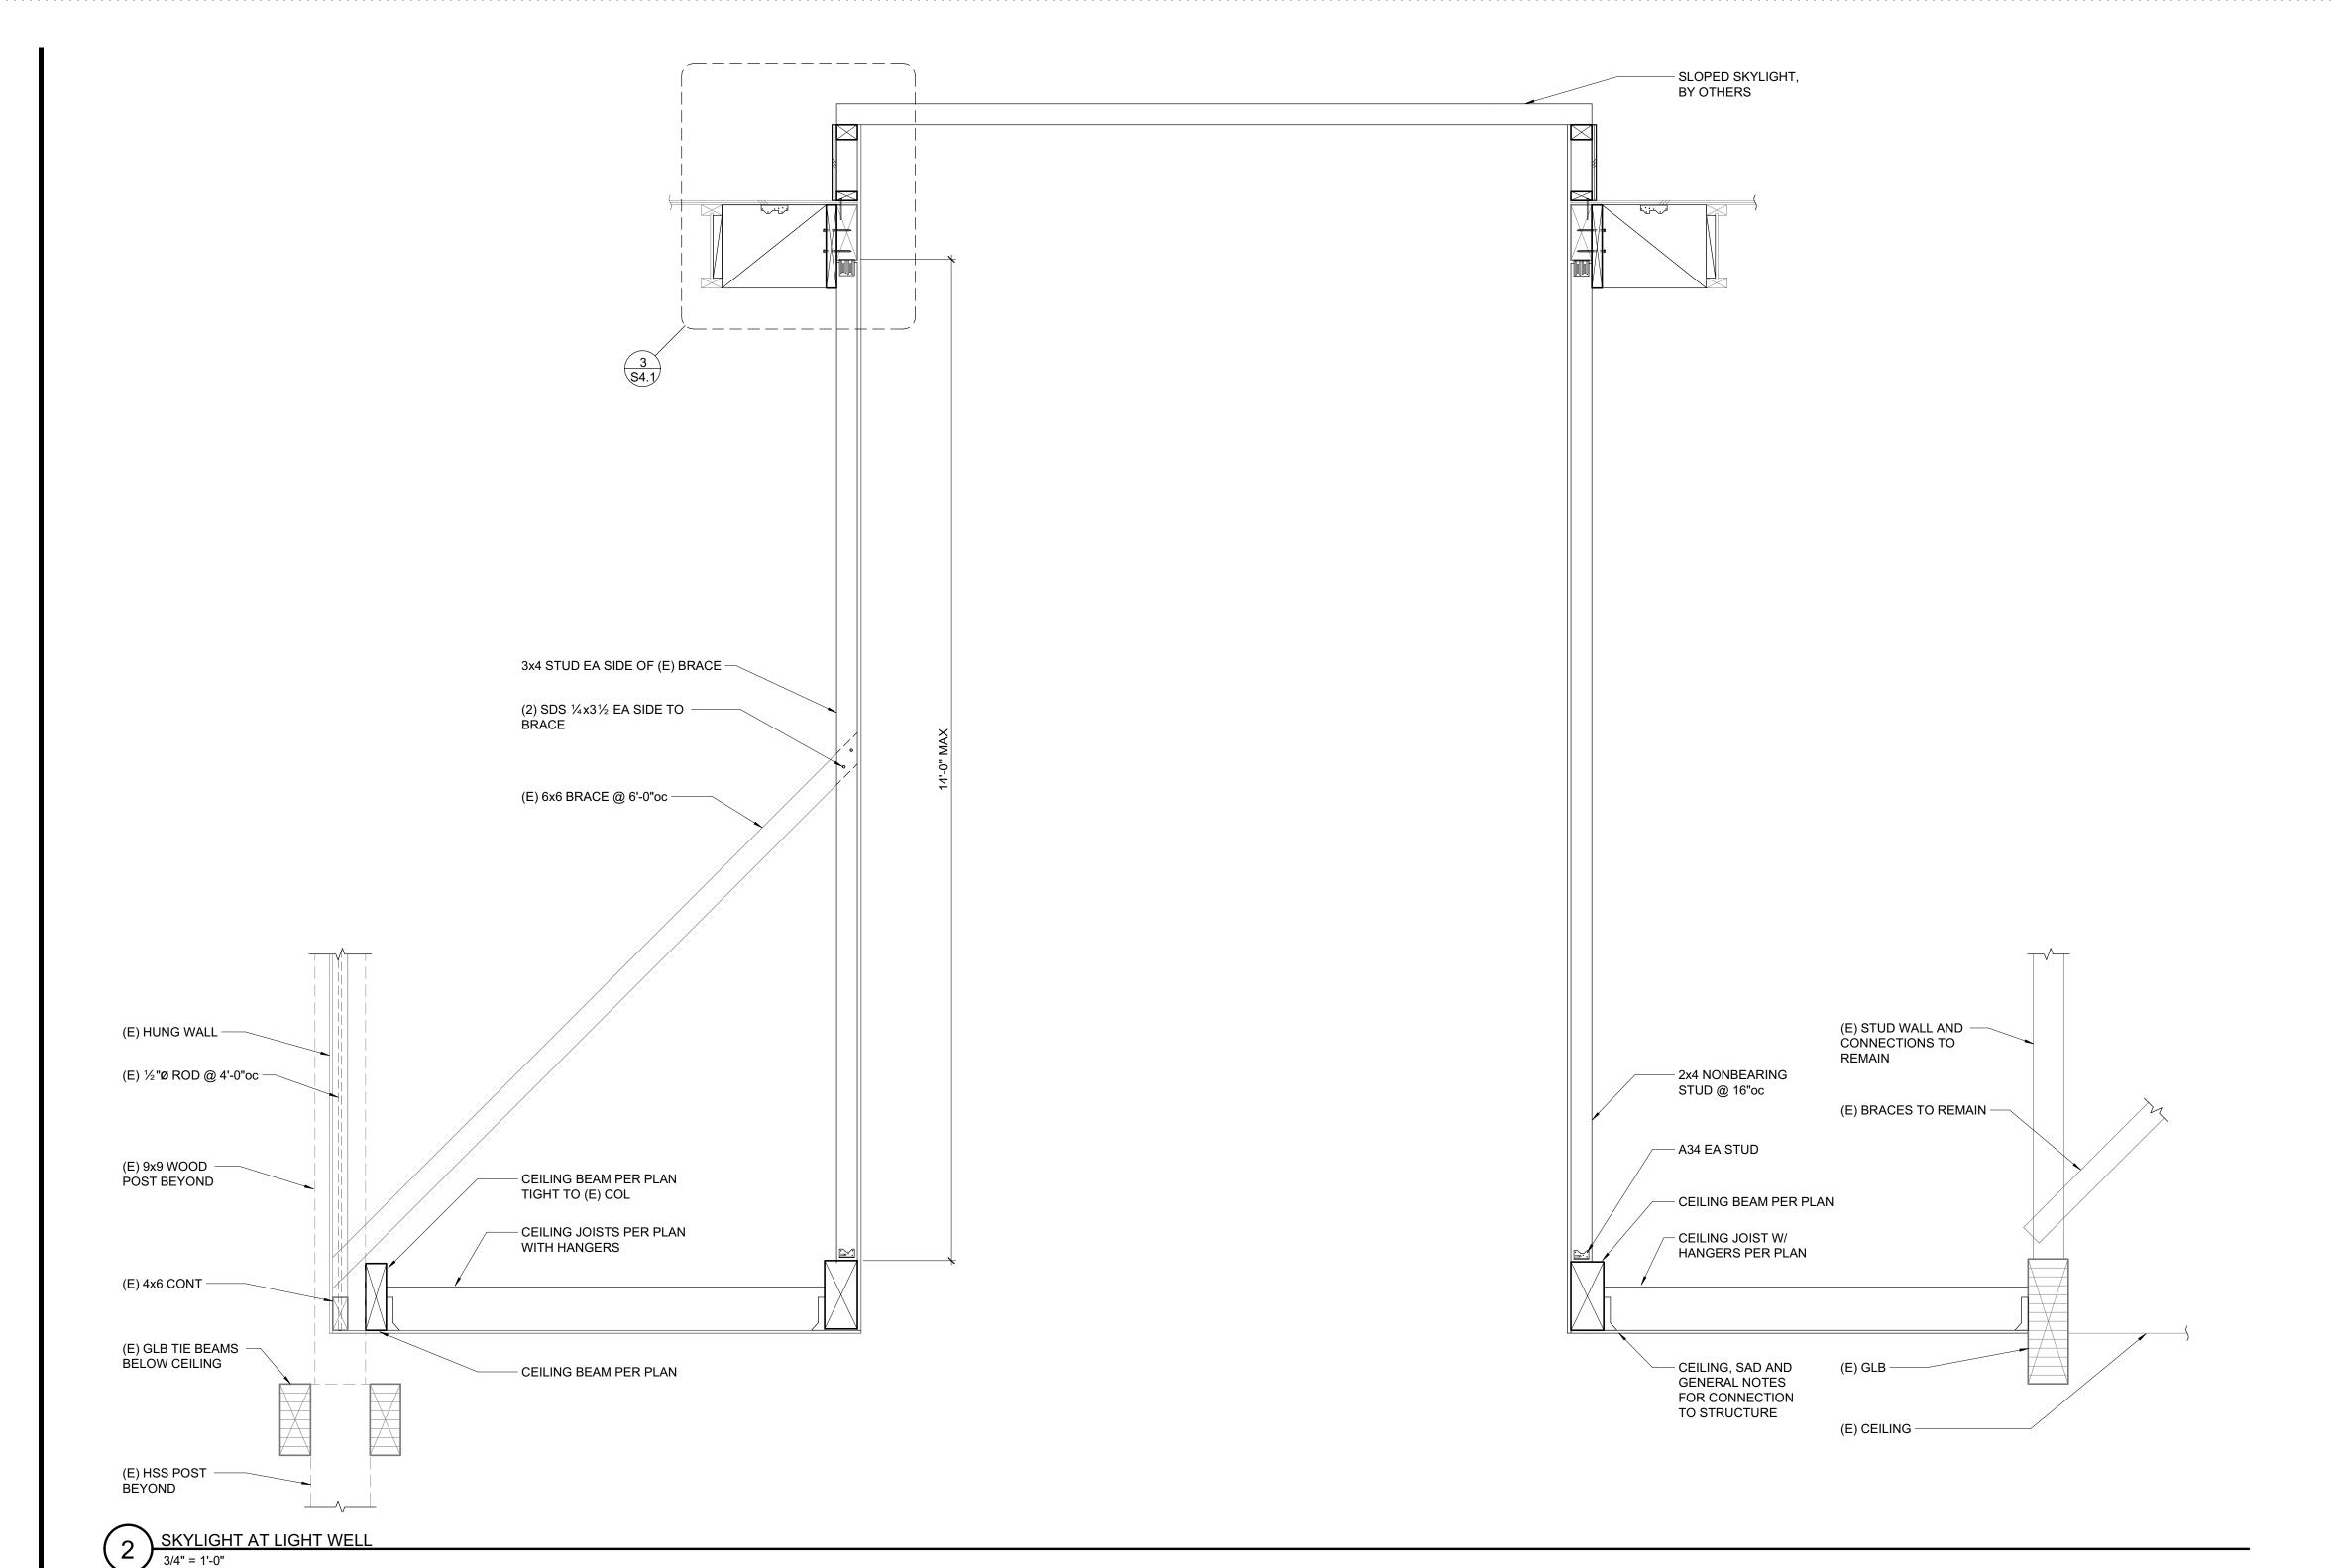

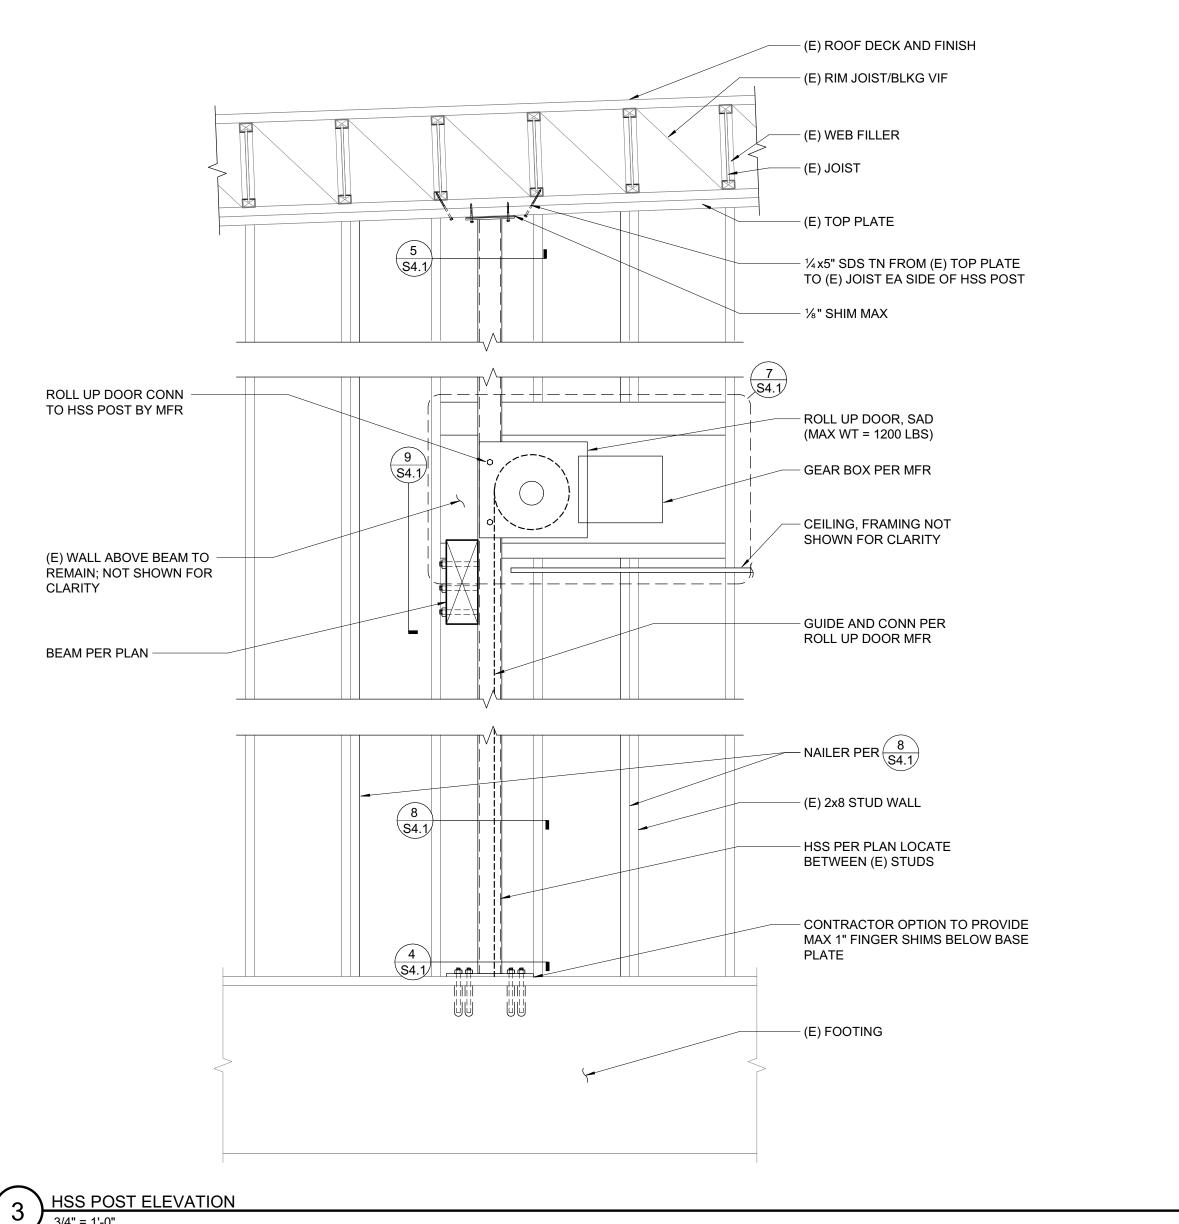


- REFER TO SHEETS <u>\$0.1</u> THROUGH <u>\$1.2</u> FOR GENERAL NOTES AND TYPICAL DETAILS. ALL GENERAL NOTES AND TYPICAL DETAIL SHEETS NOTED ABOVE ARE APPLICABLE AND SHALL BE FOLLOWED.
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- 3. EXISTING FRAMING ONLY SHOWN AT AREAS OF CONSTRUCTION.

	PLAN LEGEND						
SYMBOL	REFERENCE DETAIL	DESCRIPTION					
====		INDICATES (E) WALL BELOW.					
	<u>D/S0.1</u>	INDICATES (E) WOOD POST.					
0, 🗆 , 📘		INDICATES STEEL COLUMN.					
· · · · ·	<u>8/S1.2</u>	INDICATES PANEL EDGE NAILING ALONG FULL LENGTH OF MEMBER.					
E	<u>D/S0.1</u>	INDICATES HANGER.					
88		INDICATES GRIDLINE.					
		INDICATES STEP IN ELEVATION, SEE ARCHITECTURAL DRAWINGS.					
(A) 4'-0"	10/S1.2	INDICATES TIE STRAP. SEE SCHEDULE FOR STRAP, NAILING AND LENGTH.					

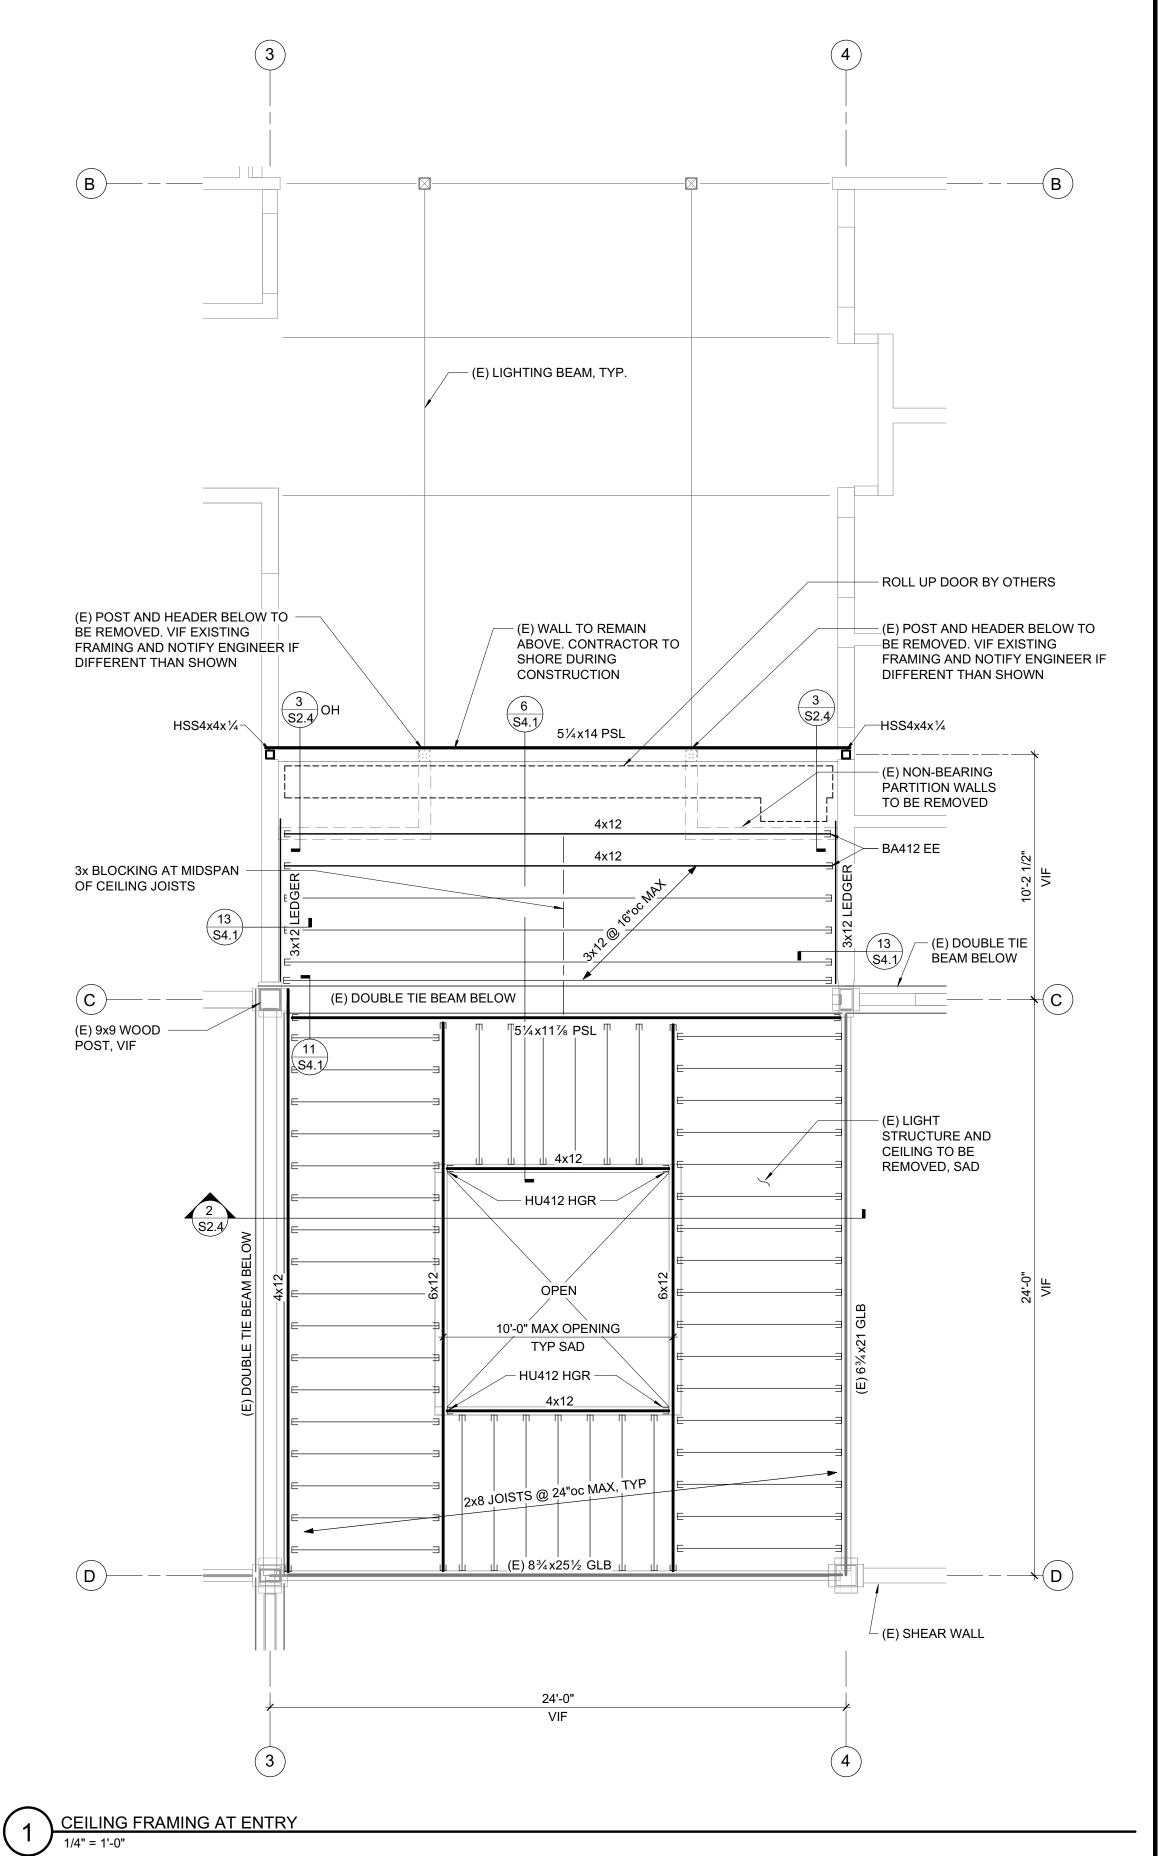



729 Heinz Avenue Berkeley, CA 94710 tel 510.542.2200 fax 510.542.2201

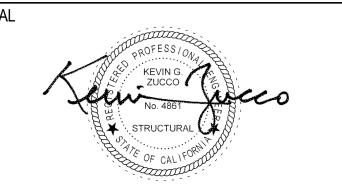

PROJECT TITLE

SONOMA COUNTY
PETALUMA
REGIONAL
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RENOVATION
PROJECT NO.
10-19

100 FAIRGROUNDS DRIVE PETALUMA, CA 94952

PERMIT SET

ISSUE DATE 11/27/202:

N&T JOB NUMBER 2182

DESCRIPTION DESCRIPTION

REVIEWED FOR CODE COMPLIANCE

05/03/2024

Shums Coda Associates

SHEET TITLE


PARTIAL CEILING FRAMING PLAN AND ELEVATIONS

SHEET NUMBER

S2.4


- REFER TO SHEETS <u>S0.1</u> THROUGH <u>S1.2</u> FOR GENERAL NOTES AND TYPICAL DETAILS. ALL GENERAL NOTES AND TYPICAL DETAIL SHEETS NOTED ABOVE ARE APPLICABLE AND SHALL BE FOLLOWED.
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PLAN LEGEND						
SYMBOL	REFERENCE DETAIL	DESCRIPTION				
====		INDICATES (E) WALL BELOW.				
	<u>D/S0.1</u>	INDICATES (E) WOOD POST.				
0, 🗆 , 📘		INDICATES STEEL COLUMN.				
<u></u>	<u>8/S1.2</u>	INDICATES PANEL EDGE NAILING ALONG FULL LENGTH OF MEMBER.				
E	D/S0.1	INDICATES HANGER.				
88)—		INDICATES GRIDLINE.				
		INDICATES STEP IN ELEVATION, SEE ARCHITECTURAL DRAWINGS.				
A 4'-0"	<u>10/S1.2</u>	INDICATES TIE STRAP. SEE SCHEDULE FOR STRAP, NAILING AND LENGTH.				

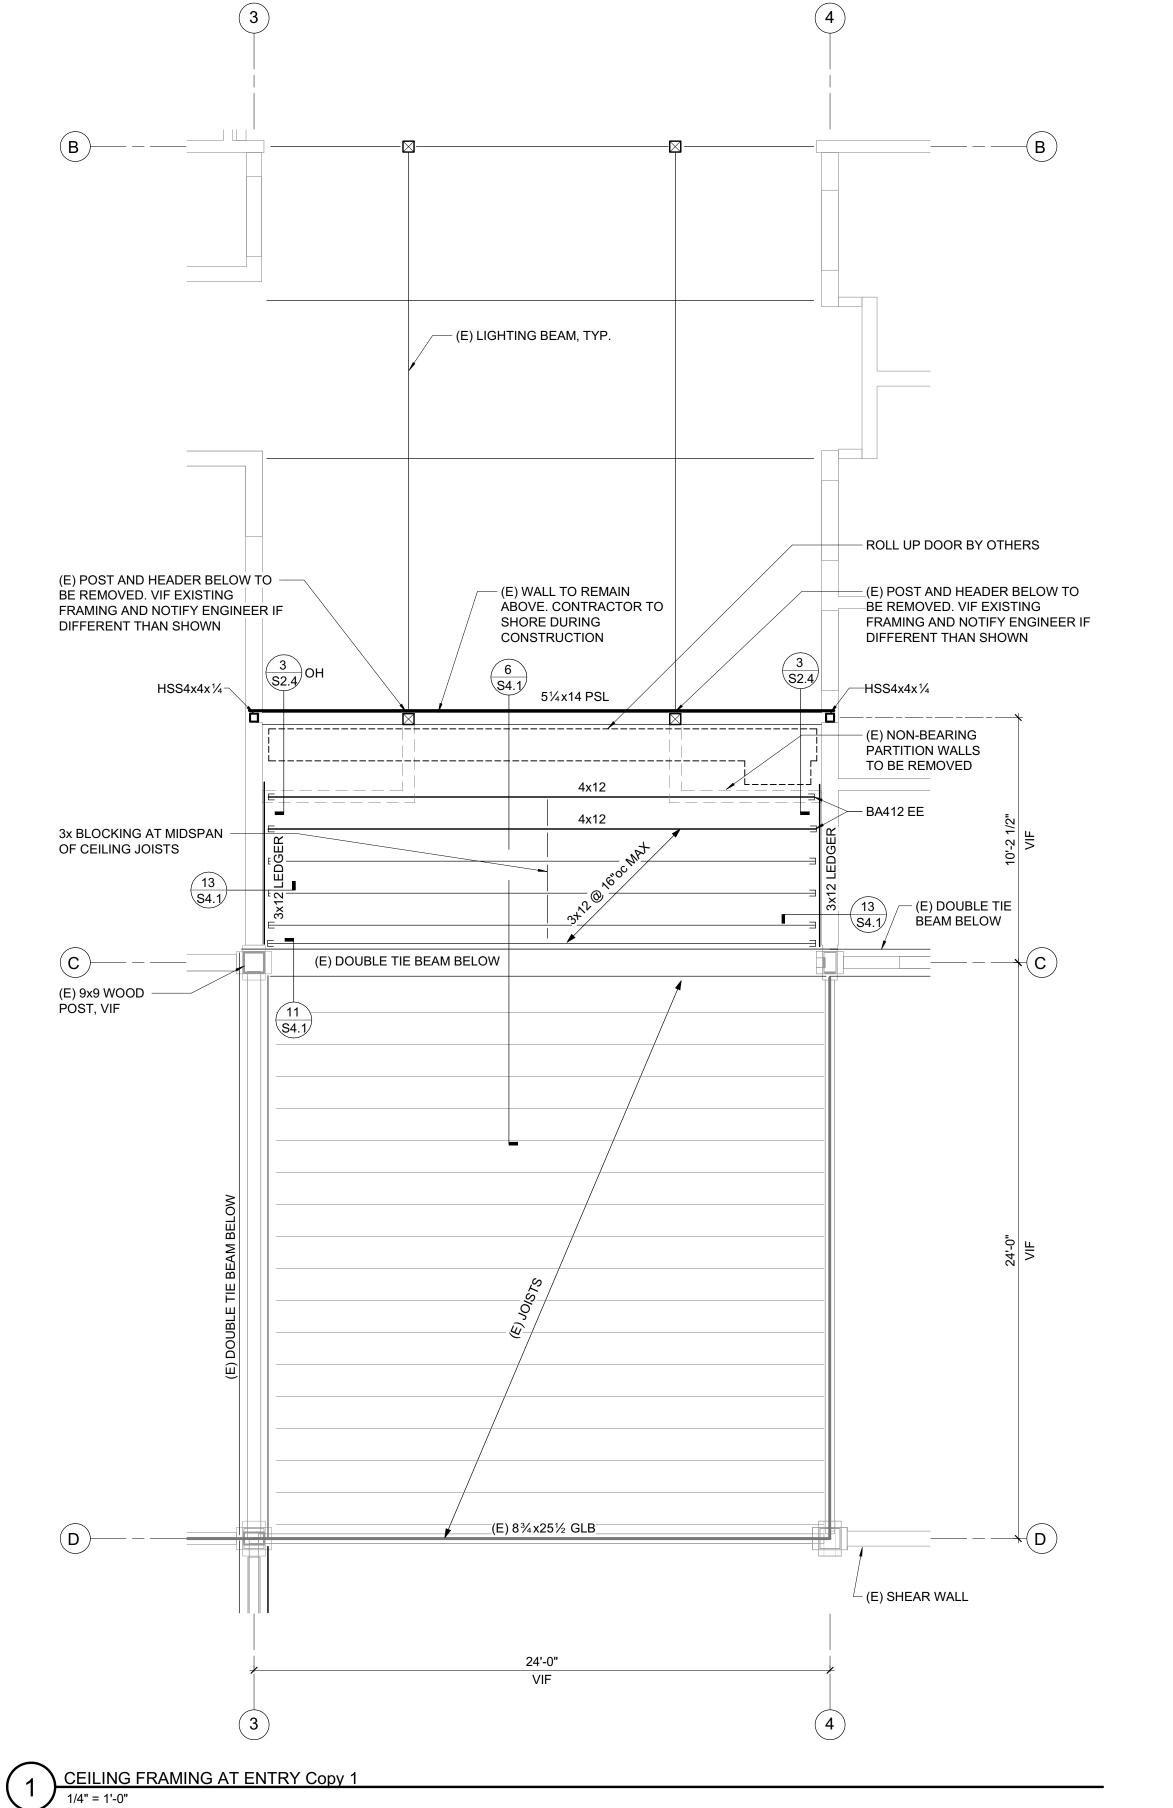

NULL & TAM

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PROJECT TITLE

SONOMA COUNTY
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PROJECT NO.
10-19

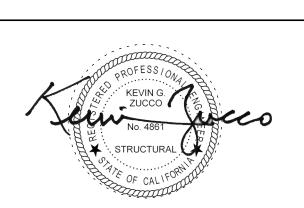100 FAIRGROUNDS DRIVE PETALUMA, CA 94952

PERMIT SET

ISSUE DATE

N&T JOB NUMBER

21824

REVISIONS

DATE

DESCRIPTION

2 4/24/24

DEDUCT ALTERNATES

REVIEWED FOR CODE COMPLIANCE

05/03/2024


Shums Coda Associates


SHEET TITLE

PARTIAL CEILING FRAMING PLAN -DEDUCT ALTERNATE 1

SHEET NUMBER

S2.4A

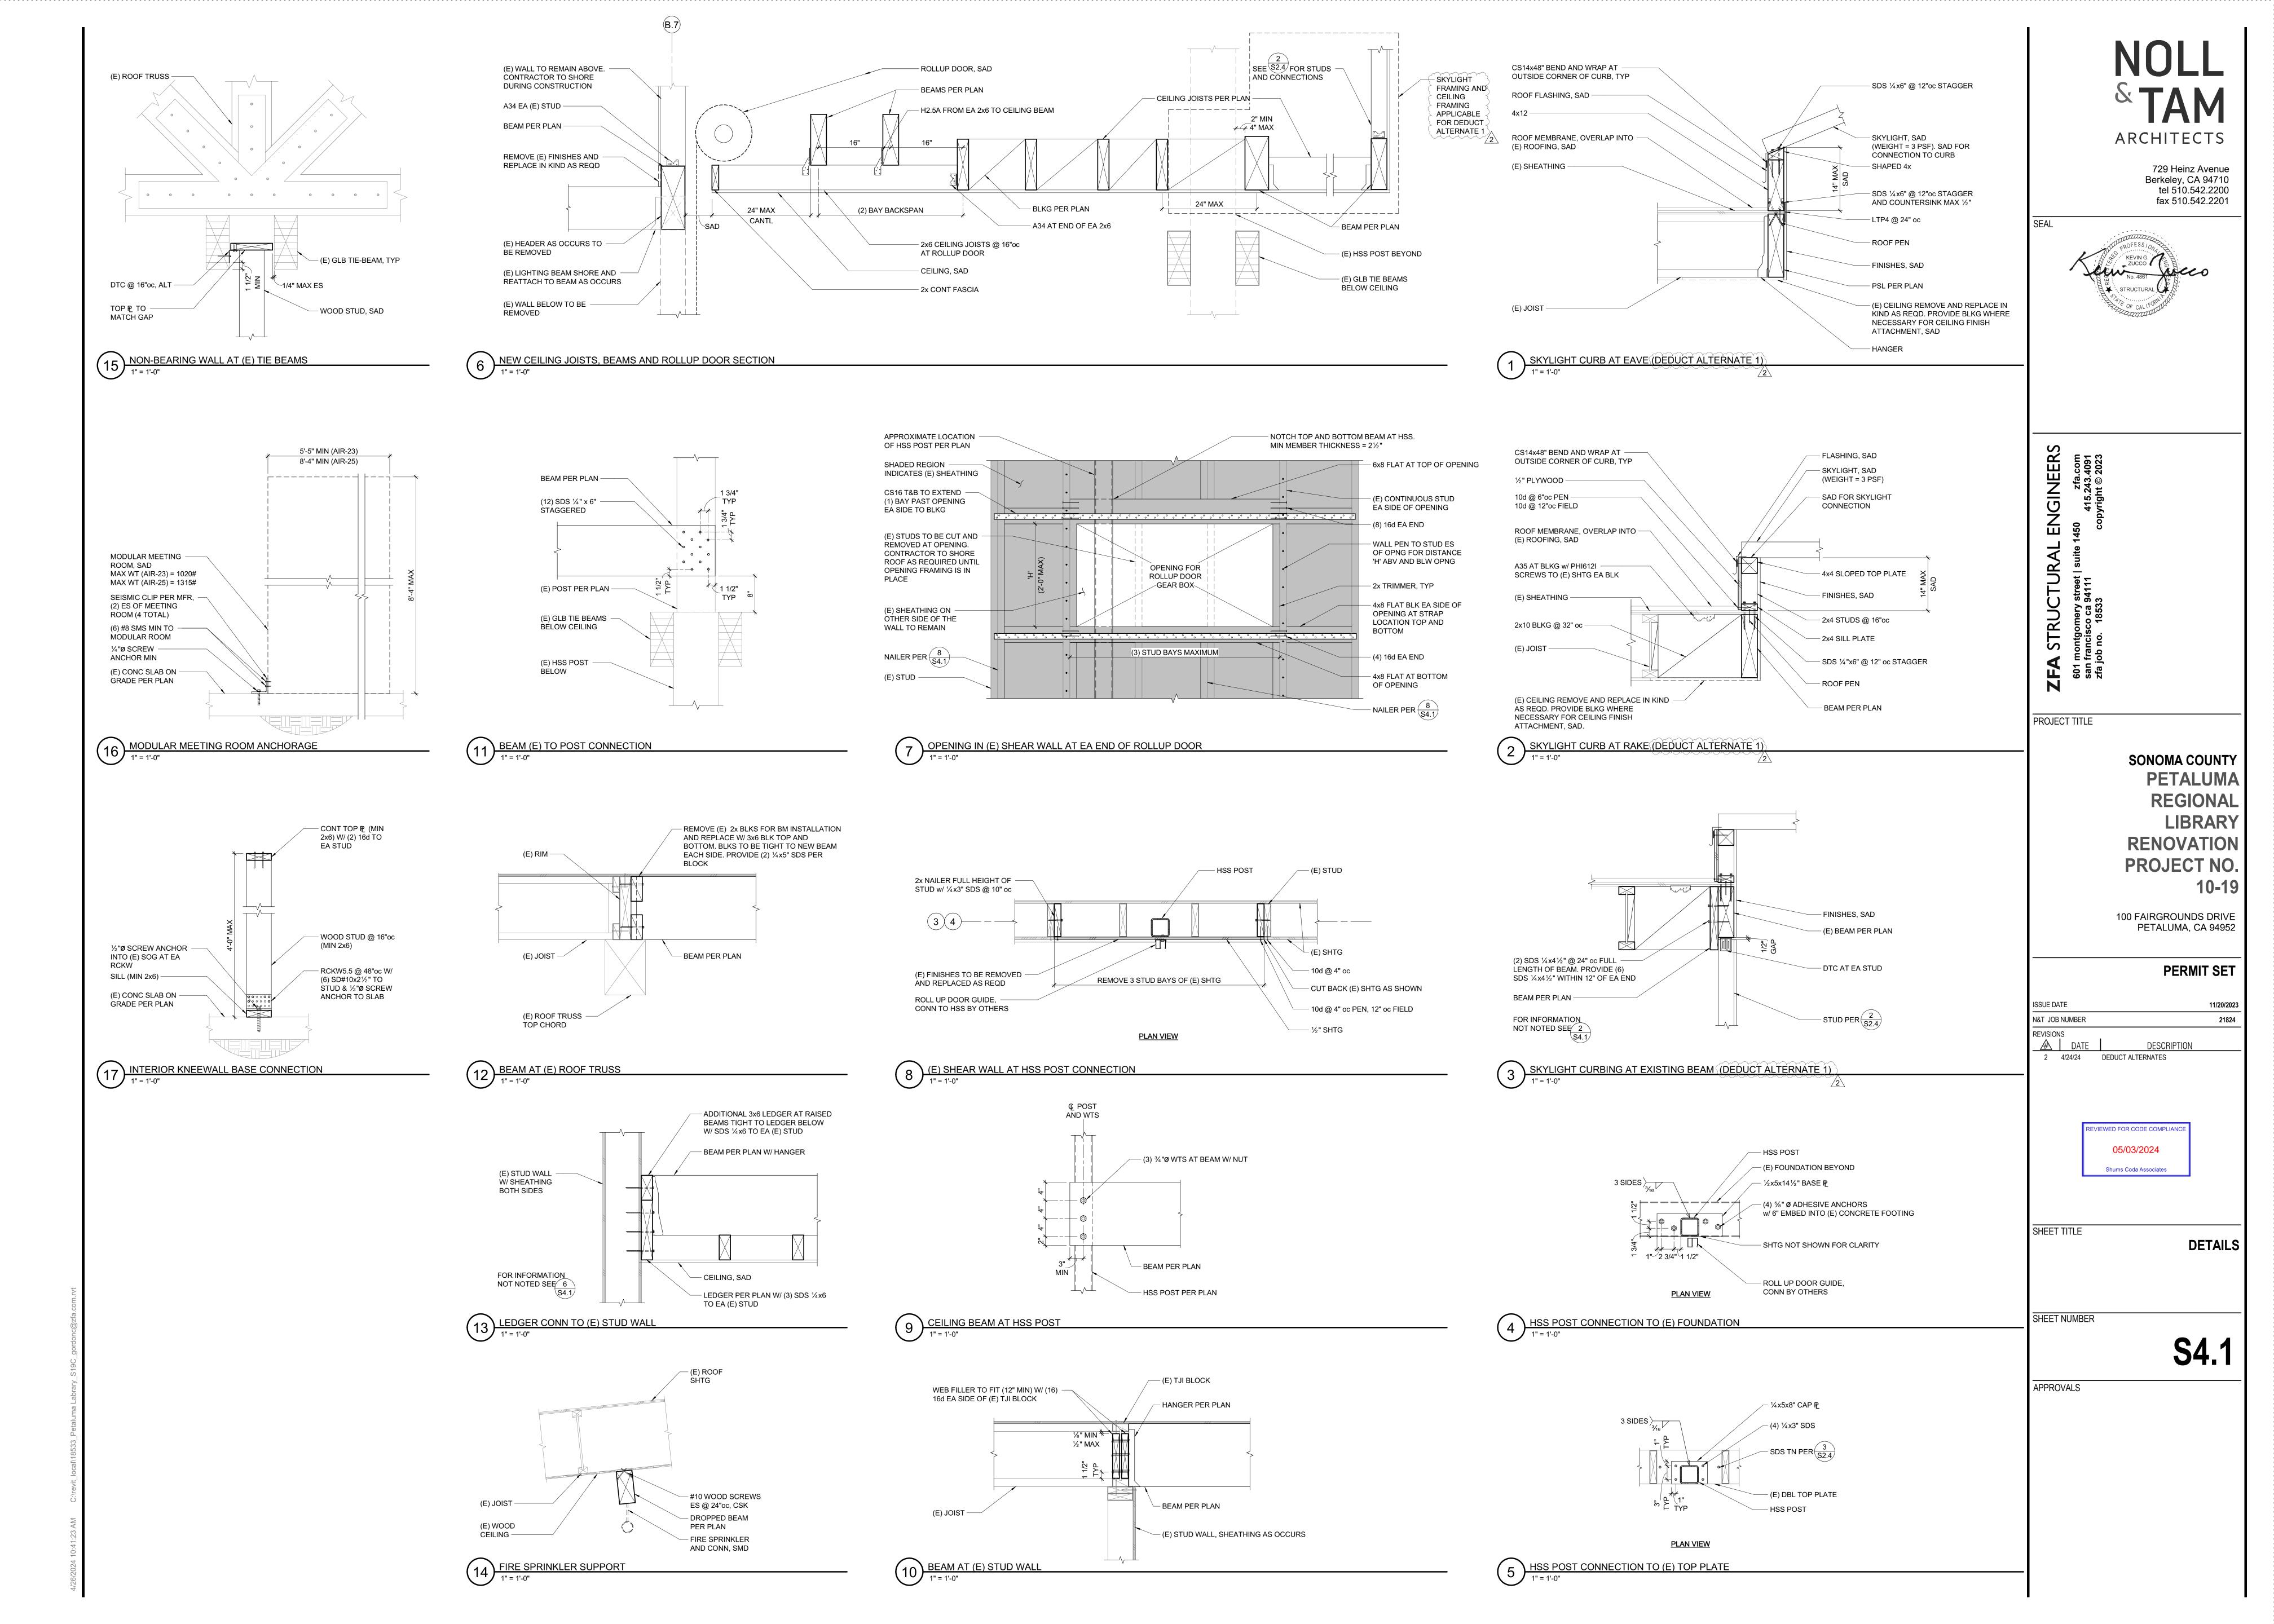

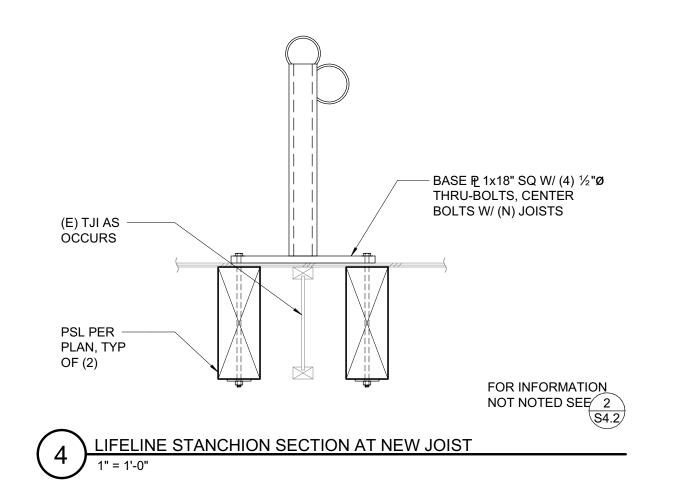

— (E) ROOF TRUSS TOP CHORD


FOR INFORMATION NOT NOTED SEE 5 \$4.2

EQ


6 LIFELINE STANCHION SEPARATION AT EXISTING TRUSS
1" = 1'-0"

(E) JOIST AS — OCCURS OR (N) JOIST, TYP


> 2 S4.2

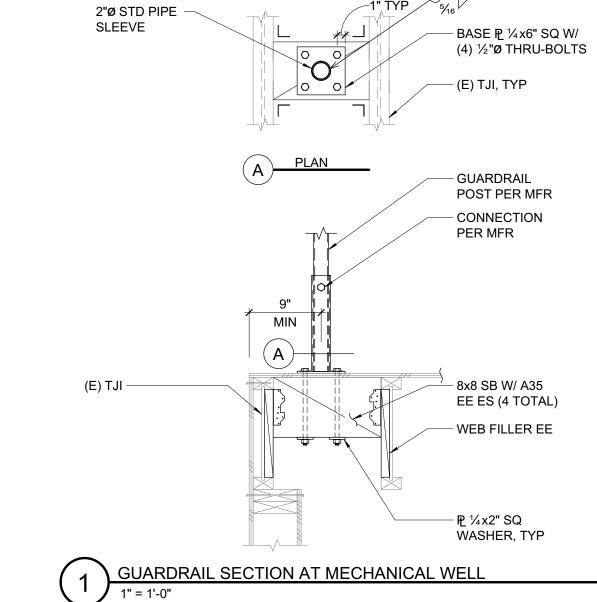


A35, TYP -

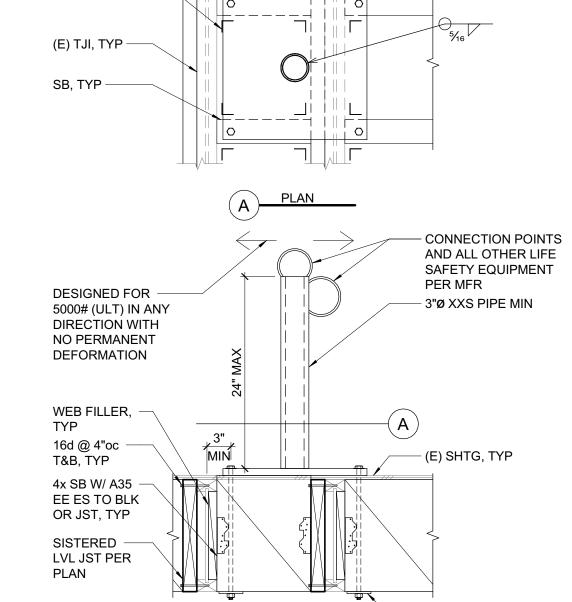

─ BASE ₱ 1x18" SQ W/ (4) ½"Ø THRU-BOLTS TO UNDERSIDE OF SB

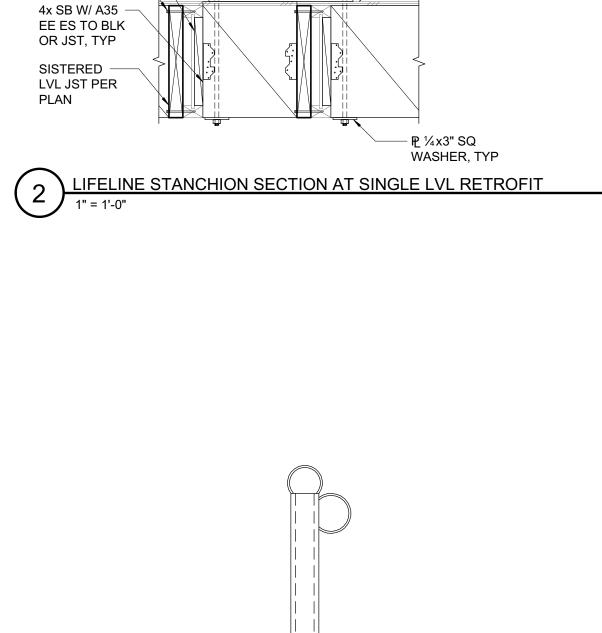

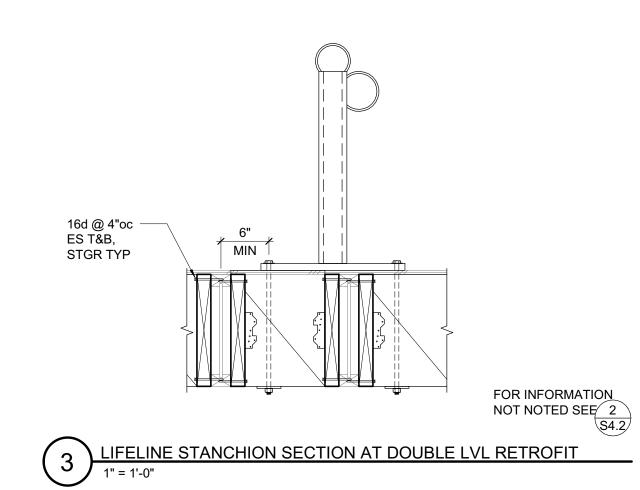



REVIN G.
ZUCCO

No. 4861

→ STRUCTURAL

OF CALLFORMAN

PROJECT TITLE

SONOMA COUNTY
PETALUMA
REGIONAL
LIBRARY
RENOVATION
PROJECT NO.
10-19

100 FAIRGROUNDS DRIVE PETALUMA, CA 94952

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2 4/24/24

DEDUCT ALTERNATES

REVIEWED FOR CODE COMPLIANCE

05/03/2024

Shums Coda Associates

SHEET TITLE

FALL PROTECTION

DETAILS


SHEET NUMBER

APPROVALS

S4.2

ALL DETAILS ON THIS SHEET APPLICABLE
TO DEDUCT ALTERNATE 2

. 10:41:24 AM C:\revit_local\18533_Petaluma Labrary_S19C_gordonc@zfa.com.rvt

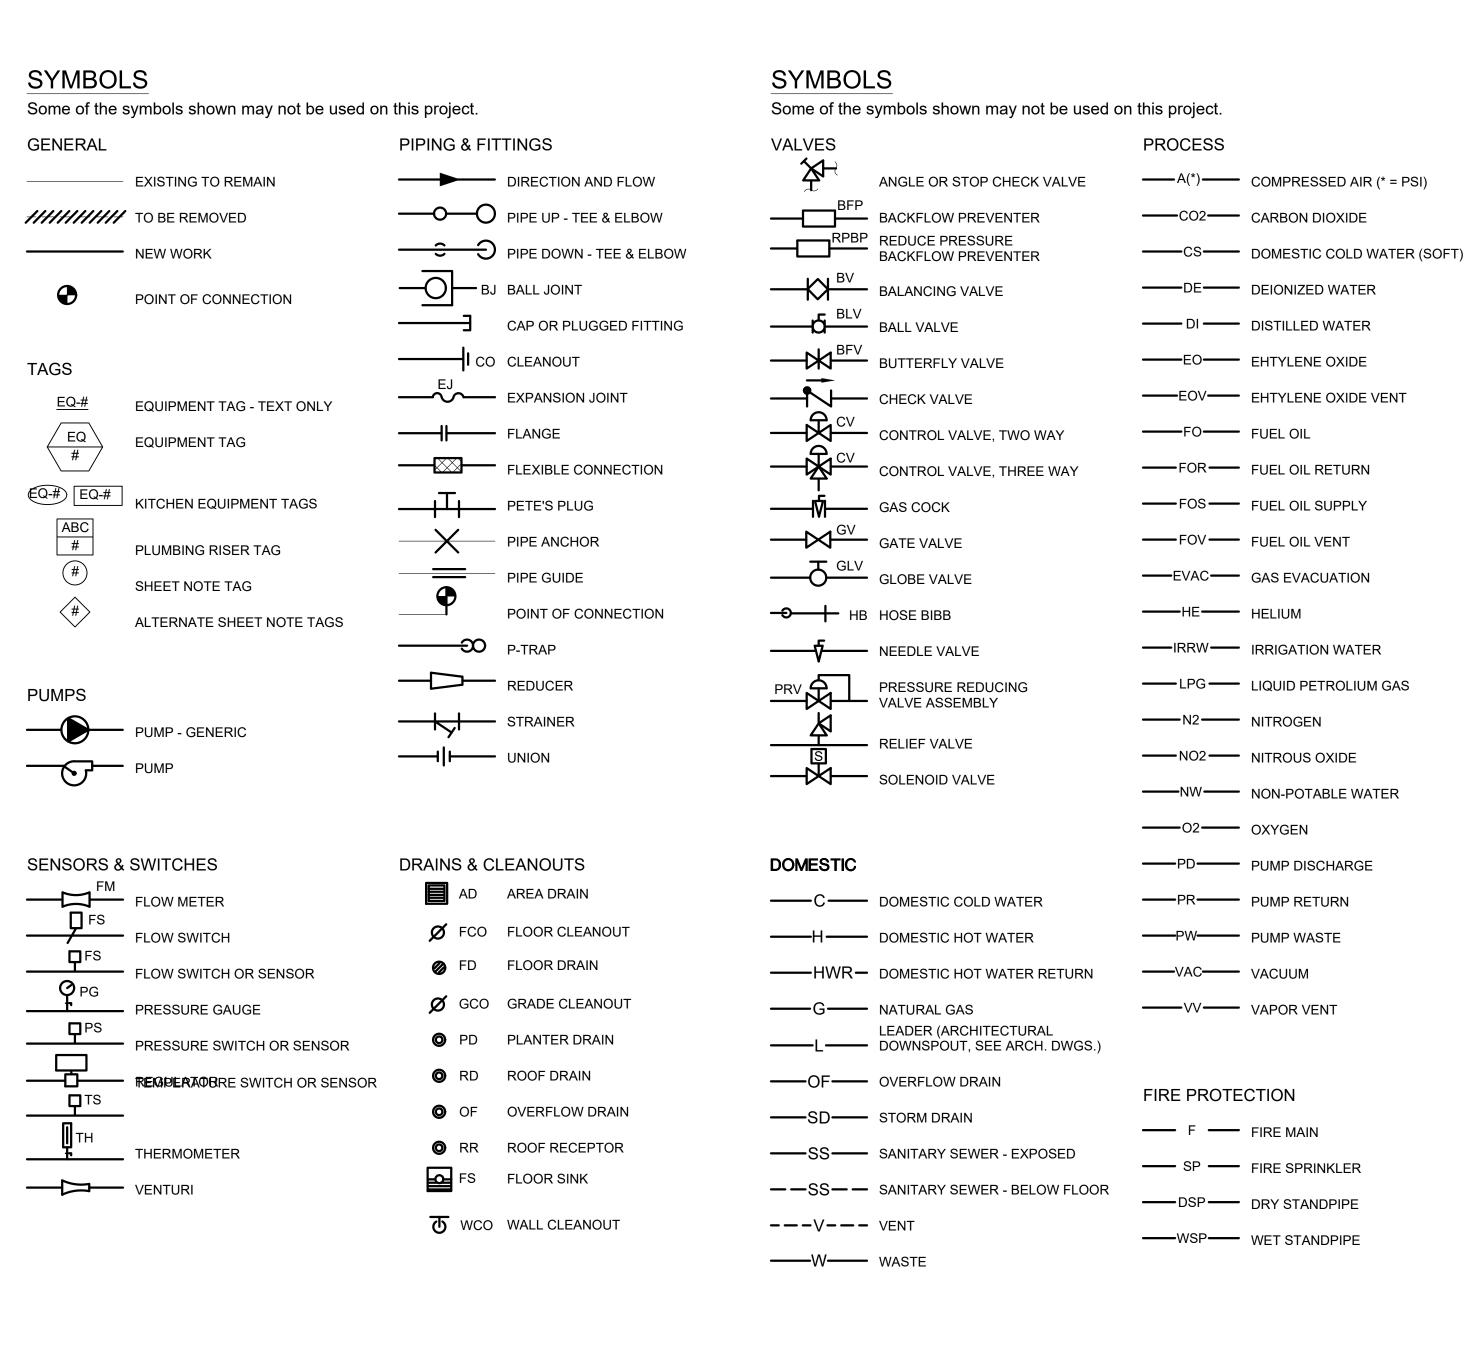

A (4)	00MDD5005D AID (#D0LMU5D5 D50LUD5D)		FUEL OU FUL		0.0.051
A(*)	COMPRESSED AIR (*PSI WHERE REQUIRED)	FOF	FUEL OIL FILL	02	OXYGEN
AD VEE	AREA DRAIN	FOG	FUEL OIL GAUGE	OD	OUTSIDE DIMENSION
√FF √P	ABOVE FINISHED FLOOR ACCESS PANEL	FOR FOS	FUEL OIL RETURN FUEL OIL SUPPLY	OSY OV	OUTSIDE STEM AND YOKE OUTLET VELOCITY
V.	ACID VENT	FOV	FUEL OIL VENT	PCHS	PRIMARY CHILLED WATER SUPPL
.v .VTR	ACID VENT THRU ROOF	FPM	FEET PER MINUTE	PCHR	PRIMARY CHILLED WATER SUPPL
W	ACID WASTE	FS	FLOW SWITCH	PD	PUMP DISCHAGE/PRESSURE DRO
D.	BOILER BLOW DOWN	FSK	FLOOR SINK	PFF	PLUG FOR FUTURE
iF	BOILER FEED	FTT	FLOAT AND THERMOSTAT TRAP	PG	PRESSURE GAUGE
r FP	BACKFLOW PREVENTER	FUT	FUTURE	PIV	POST INDICATOR VALVE
FV	BUTTERFLY VALVE	G	NATURAL GAS	PLBG	PLUMBING
HP	BRAKE HORSEPOWER /	GA	GAUGE	PR	PUMP RETURN
• • •	BOILER HORSEPOWER	GCO	GRADE CLEANOUT	PRV	PRESSURE REDUCING VALVE
LDG	BUILDING	GI	GALVANIZED IRON	PSI	POUNDS PER SQUARE INCH
LV	BALL VALVE	GLV	GLOBE VALVE	PSIG	POUNDS PER SQUARE INCH GAU
MS	BUILDING MANAGEMENT SYSTEM	GPH	GALLONS PER HOUR	PTS	PNEUMATIC TUBE SYSTEM
T	BATH TUB	GR	GRADE	PW	PUMP WASTE
V	BALANCING VALVE	GV	GATE VALVE	RD	ROOF DRAIN
WV	BACKWATER VALVE	H(*)	DOMESTIC HOT WATER	RIC	ROUGH IN AND CONNECT
•••	DOMESTIC COLD WATER	\ /	(*TEMP. WHERE REQ'D.)	RIO	ROUGH IN ONLY
D	CONDENSATE DRAIN	НВ	HOSE BIBB	RPBP	REDUCED PRESSURE BACKFLOW
F	CHEMICAL FEED	HE	HELIUM		PREVENTER
FF	CAP FOR FUTURE	HET	HOT WATER EXPANSION TANK	RPM	REVOLUTIONS PER MINUTE
FH	CUBIC FEET PER HOUR	HPDT	HIGH PRESSURE DRIP TRAP	RV	RELIEF VENT/ROOF VENTILATOR
:I	CAST IRON	HPR	HIGH PRESSURE CONDENSATE RETURN	RVV	RELIEF VALVE VENT
LG	CEILING	HPS	HIGH PRESSURE STEAM	SA	SHOCK ARRESTOR
0	CLEANOUT	HTG	HEATING	SB	STZ BATH
:02	CARBON DIOXIDE	HU	HUMIDIFIER	SD	SIGHT DRAIN
OND	CONDENSER/CONDENSING/CONDENSATE	HV	HEATING AND VENTILATING	SH	SHOWER
P	CHROME PLATED	HVAC	HEATING VENTILATING AND	SK	SINK
PVC	CHLORINATED POLYVINYL CHLORIDE	IIVAO	AIR CONDITIONING	SM	SHEET METAL
RP	CONDENSATE RETURN PUMP	HWR	DOMESTIC HOT WATER RETURN	SP	FIRE SPRINKLER
S	DOMESTIC COLD WATER (SOFT)	HZ	HERTZ	SPD	SPRINKLER DRAIN
SK	CLINICAL SINK	ID	INSIDE DIAMETER	SS	STAINLESS STEEL
TE	CONNECT TO EXISTING	IE	INVERT ELEVATION	SSD	SUBSURFACE DRAIN
V V	CONTROL VALVE	IFS	IN FURRED SPACE	SSK	SERVICE SINK
WR	CONDENSER WATER RETURN	IPS	IRON PIPE SIZE	ST	STEAM TRAP
cws	CONDENSER WATER SUPPLY	IRRW	IRRIGATION WATER	STD	STANDARD
)B	DRY BULB TEMPERATURE	IW	INDIRECT WASTE	STL	STEEL
Ε	DEIONIZED WATER	L	RAINWATER	SV	STEAM VENT
)F	DRINKING FOUNTAIN	LA	LABORATORY COMPRESSED AIR	SW	SPECIAL WASTE
) 	DISTILLED WATER	LAT	LEAVING AIR TEMPERATURE/LATENT	TCV	TEMPERATURE CONTROL VALVE
) N	DOWN	LP	LOW PRESSURE	TD	TRENCH DRAIN
ıR	DRAIN	LPDT	LOW PRESSURE DRIP TRAP	TH	THERMOMETER
SP	DRY STANDPIPE	LPG	LIQUID PETROLEUM GAS	UR	URINAL
osp T	DRIP TRAP	LPG	LOW PRESSURE CONDENSATE RETURN	V	SANITARY VENT
WG	DRAWING	LPS	LOW PRESSURE STEAM	v VAC	MEDICAL VACUUM
	EXISTING	LV	LAVATORY	VAC	VACUUM BREAKER
≣) :D	EXTRACTION DAMPER	LV	LEAVING	VCP	VITRIFIED CLAY PIPE
	EXPANSION JOINT	LWCO	LOW WATER CUT-OFF	VEL	VITRIFIED CLAY PIPE VELOCITY
J L	ELEVATION SOLINI	LWCO	LEAVING WATER TEMPERATURE	VEL	VELOCITY VENT THRU ROOF
:L :NT	ENTERING	Lvv i MA	MEDICAL COMPRESSED AIR	VIR	VAPOR VENT
	ETHYLENE OXIDE		THOUSAND BRITISH THERMAL	W	WASTE
:0 :0V	ETHYLENE OXIDE ETHYLENE OXIDE VENT	MBH			WASTE WET BULB TEMPERATURE
OV		MCC	UNITS PER HOUR MOTOR CONTROL CENTER	WB	
VAC	GAS EVACUATION ENTERING WATER PRESSURE	MCC MD		WCO	WALL CLEANOUT
WT	ENTERING WATER PRESSURE	MD MED	MOTORIZED DAMPER	WCO	WALL CLEANOUT
C	FLEXIBLE CONNECTION	MFR	MANUFACTURER MEDICAL CAS	WP	WEATHER OR WATER PROOF
CO	FLOOR CLEANOUT	MG	MEDICAL GAS ALABM	WSP	WET STAND PIPE
D	FLOOR DRAIN	MGA	MEDICAL GAS ALARM	WT	WEIGHT
DC	FIRE DEPARTMENT CONNECTION	MPDT	MEDIUM PRESSURE DRIP TRAP		
DR -	FIRE DAMPER	MPR	MEDIUM PRESSURE CONDENSATE RETURN		
E 	FIRE EXTINGUISHER	MPS	MEDIUM PRESSURE STEAM		
EC	FIRE EXTINGUISHER CABINET	(N)	NEW		
Н	FIRE HYDRANT	N2	NITROGEN		
HC	FIRE HOSE CABINET	NC	NORMALLY CLOSED		
IN	FINISHED	NFPA	NATIONAL FIRE PROTECTION ASSOCIATION		
		NO	NORMALLY OPEN		

NO NORMALLY OPEN


N2O NITROUS OXIDE

NTS NOT TO SCALE

NW NON-POTABLE WATER

ARCHITECTS

729 Heinz Avenue Berkeley, CA 94710 tel 510.542.2200 fax 510.542.2201

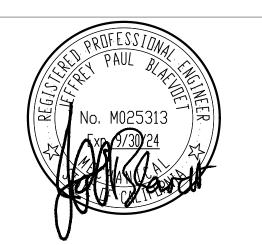



San Francisco, CA. 94133-1449 P 415 655 4000 F 415 655 4001

E g&b@gb—eng.com

PROJECT TITLE

SONOMA COUNTY **PETALUMA REGIONAL LIBRARY**

100 FAIRGROUNDS DRIVE PETALUMA, CA 94952

DESCRIPTION

PERMIT SET

N&T JOB NUMBER

REVIEWED FOR CODE COMPLIANCE 05/03/2024

Shums Coda Associates

DATE

LEGEND, SYMBOLS, **GENERAL NOTES & DRAWING LIST**

SHEET NUMBER

P0.01

APPROVALS

PLUMBING GENERAL NOTES

- ENTIRE INSTALLATION SHALL CONFORM TO THE REQUIREMENTS OF THE 9. REFER TO ARCHITECTURAL DRAWINGS FOR EXACT 2022 PLUMBING CODE, BUILDING CODE, NATIONAL FIRE PROTECTION CODES, ALL OTHER APPLICABLE CODES AND REGULATIONS, AND AUTHORITIES HAVING JURISDICTIONS.
- COORDINATE PLUMBING SYSTEMS WITH WORK OF OTHER TRADES PRIOR TO ANY FABRICATION OR INSTALLATION. PROVIDE ALL FITTINGS, OFFSETS, AND TRANSITIONS AS REQUIRED FOR A COMPLETE WORKABLE INSTALLATION.
- ALL EQUIPMENT SHALL BE INSTALLED IN STRICT ACCORDANCE WITH THE EQUIPMENT MANUFACTURER'S RECOMMENDATIONS AND APPLICABLE CODES. PROVIDE ALL FITTINGS, TRANSITIONS, VALVES, AND OTHER DEVICES REQUIRED FOR A COMPLETE WORKABLE INSTALLATION.
- MAINTENANCE LABEL SHALL BE AFFIXED TO ALL PLUMBING EQUIPMENT AND A MAINTENANCE MANUAL SHALL BE PROVIDED TO
- ALL CLEANOUTS SHALL BE INSTALLED PER CALIFORNIA PLUMBING CODE, 2022 EDITION.
- LAVATORIES IN PUBLIC RESTROOMS SHALL HAVE HOT WATER CONTROLS THAT COMPLY WITH THE FOLLOWING CALIF. CODE REQUIREMENTS:
- MAXIMUM FLOW RATE OF 0.4 GPM.
- FLOW RATE (GAL/CYCLE) FOR SELF-CLOSING VALVES OF 0.25.
- MAXIMUM OUTLET TEMPERATURE OF 120° F. CIRCULATING SERVICE WATER HEATING SYSTEM SHALL HAVE A CONTROL TIMECLOCK CAPABLE OF AUTOMATICALLY TURNING OFF THE CIRCULATING PUMP WHEN HOT WATER IS NOT REQUIRED.
- SANITARY AND DRAINAGE PIPING 3" AND SMALLER SHALL BE SLOPED AT 1/4" PER FOOT MINIMUM. PIPING 4" AND LARGER SHALL BE SLOPED AT 1/8" PER FOOT MINIMUM. AS APPROVED BY SF INSPECTOR.

LOCATIONS.

DRAWINGS ARE DIAGRAMMATIC TO THE EXTENT THAT ALL OFF-SETS, BENDS, SPECIAL FITTINGS AND EXACT LOCATIONS ARE NOT INDICATED. EXAMINE DRAWINGS AND PREMISES IN ORDER TO DETERMINE BEST METHODS, EXACT LOCATIONS, ROUTES AND BUILDING CONSTRUCTIONS.INSTALL APPARATUS AND EQUIPMENT IN ACCESSIBLE

- LOCATION AND ELEVATIONS OF PLUMBING EQUIPMENT. 10. PROVIDE LOW FLOW PLUMBING FIXTURES TO MEET
- 11. LOCATIONS OF PIPING, FIXTURES AND EQUIPMENT INDICATED ON THE DRAWINGS ARE APPROXIMATE ONLY, AND SHALL BE CHANGED TO MEET THE ARCHITECTURAL AND STRUCTURAL CONDITIONS AS REQUIRED, AT NO EXTRA COST TO THE OWNER.

WATER CONSERVATION ACT.

- ALL PLUMBING FIXTURES AND EQUIPMENT SHALL HAVE ISOLATING VALVES, ACCESSIBLE SHUT-OFF VALVE ON ALL WATER SUPPLY LINES AND GAS LINES.
- 13. INSULATE ALL WATER PIPING PER TITLE 24 REQUIREMENTS.
- 14. ABSOLUTE ACCURACY OF DRAWING AND SPECIFICATIONS CANNOT BE GUARANTEED. THE DRAWINGS ARE SCHEMATIC IN NATURE AND WHILE EVERY EFFORT HAS BEEN MADE TO COORDINATE THE LOCATIONS OF EQUIPMENT PIPING, DUCT, AND ETC. WITH OTHER TRADES. IT IS THE RESPONSIBILITY OF THE CONTRACTOR TO COORDINATE EXACT REQUIREMENTS GOVERNED BY ACTUAL JOB CONDITION.
- PENETRATION OF RATED ASSEMBLY SHALL BE FIRE-STOPPED. FOR STOPPING SYSTEM (MATERIAL& DESIGN) SHALL CONFORM TO BOTH FLAME (F) AND TEMPERATURE(T) RATING AS REQUIRED BY LOCAL BUILDING CODE AND AS TESTED BY NATIONALLY ACCEPTED TEST AGENCIES PER ASTM E814 OR REPRESENTABLE OF FIELD CONDITION.
- 16. IT IS THE CONTRACTOR'S RESPONSIBILITY TO INSTALL ALL WORK TO MEET OR EXCEED MINIMUM REQUIREMENTS STIPULATED IN CURRENT ISSUE OF APPLICABLE STANDARDS, CODES, OR REGULATIONS.
- 17. PROVIDE WATER HAMMER ARRESTOR ON WATER PIPE CONNECTION TO EACH FLUSH VALVE FIXTURE & FAST ACTING VALVES.
- 18. ALL PLUMBING WORK SHALL COMPLY WITH LEAD FREE REQUIREMENTS OF AB1953 EFFECTIVE JANUARY 01, 2010.

FIRE LINE

FLOW METER

FLANGE

FLOOR

FUEL OIL

FLR

DRAWING LIST

P5.01

Sheet Number Sheet Title LEGEND, SYMBOLS, GENERAL NOTES & DRAWING LIST DEMOLITION PLAN - 1ST FLOOR AND MEZZANINE - PLUMBING

FLOOR PLAN - 1ST FLOOR AND MEZZANINE - PLUMBING P2.31 P3.01 ENLARGED PLANS - PLUMBING

SCHEDULES

ARCHITECTS

729 Heinz Avenue Berkeley, CA 94710 tel 510.542.2200 fax 510.542.2201



SONOMA COUNTY **PETALUMA REGIONAL LIBRARY RENOVATION** PROJECT NO.

DEMOLITION PLAN - 1ST FLOOR AND MEZZANINE

P1.31


GENERAL NOTES

1. CONTRACTOR TO FIELD VERIFY EXISTING CONDITION PRIOR OF STARTING NEW WORK.

NOLL & TAM ARCHITECTS

729 Heinz Avenue

Berkeley, CA 94710 tel 510.542.2200

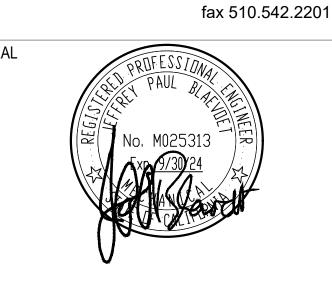



PROJECT TITLE

PETALUMA
REGIONAL
LIBRARY
RENOVATION
PROJECT NO.
10-19

100 FAIRGROUNDS DRIVE PETALUMA, CA 94952

PERMIT SET

ISSUE DATE 11/27/202

N&T JOB NUMBER 21824

REVISIONS

DATE

DESCRIPTION

REVIEWED FOR CODE COMPLIANCE

05/03/2024

Shums Coda Associates


FLOOR PLAN - 1ST
FLOOR AND MEZZANINE
- PLUMBING


SHEET NUMBER

P2.31


ROVALS


2 MEZZANINE - FLOOR PLAN
1/8" = 1'-0"

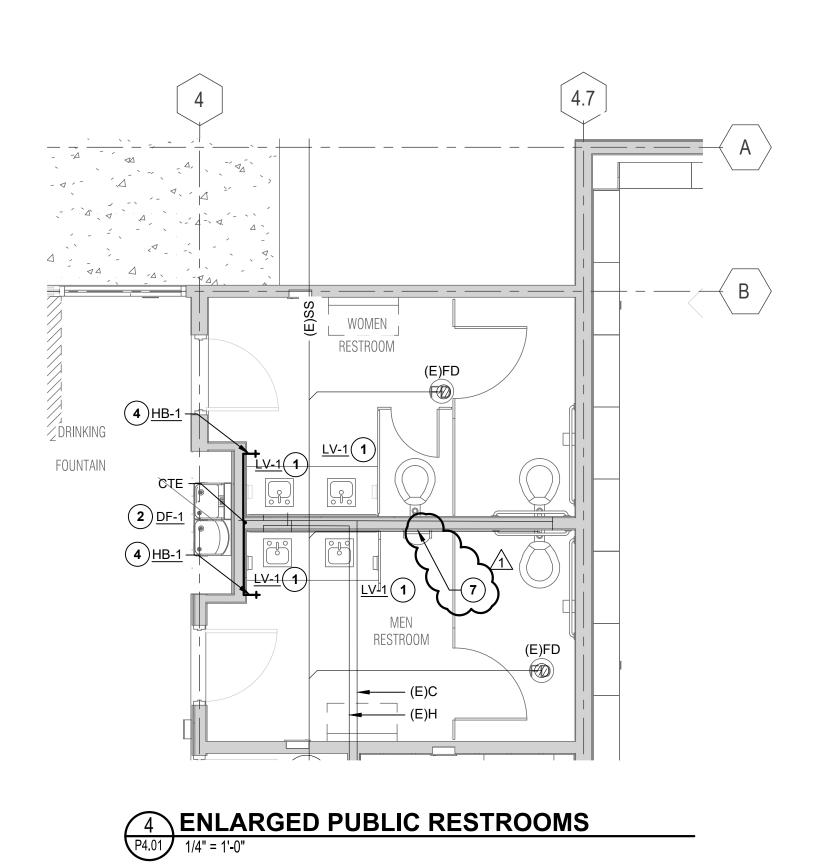


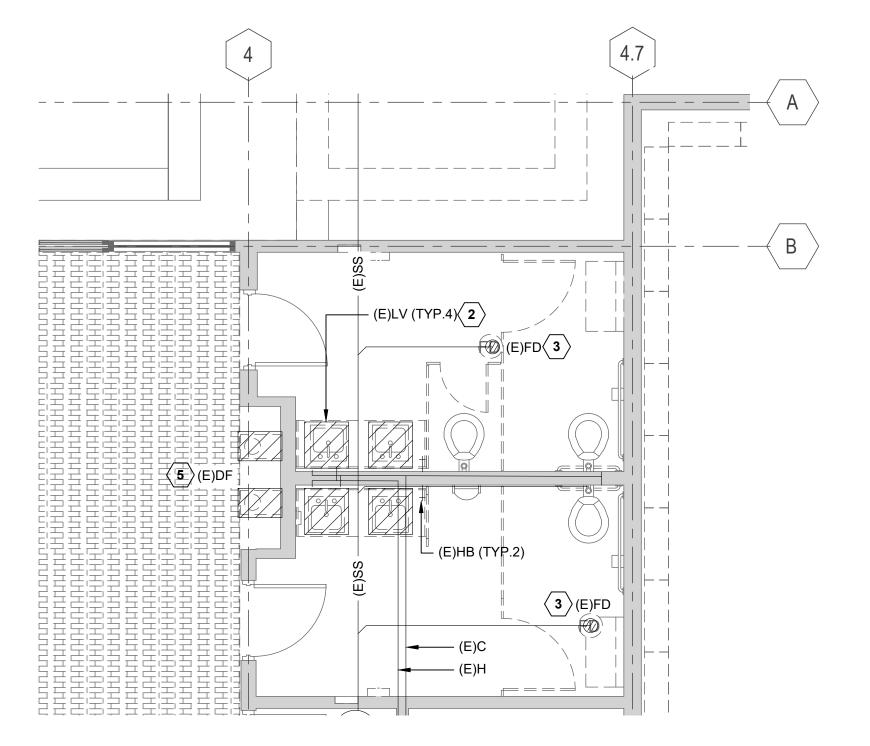




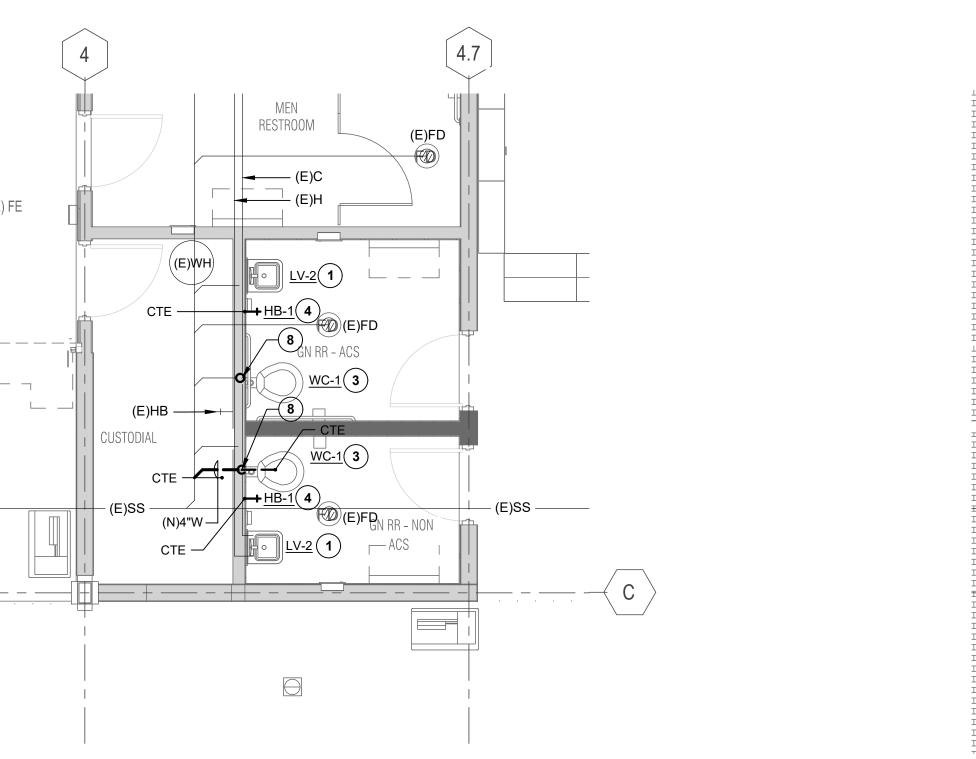

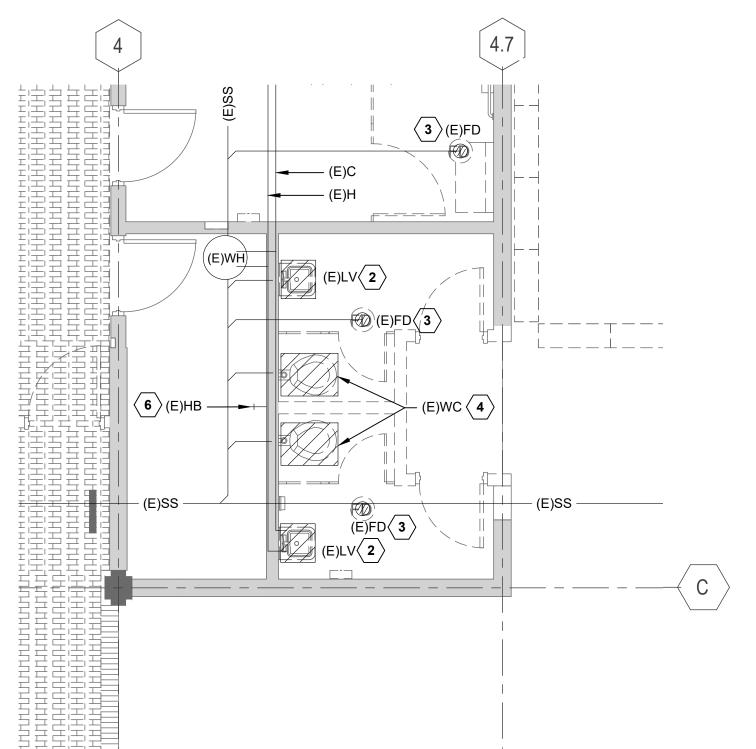

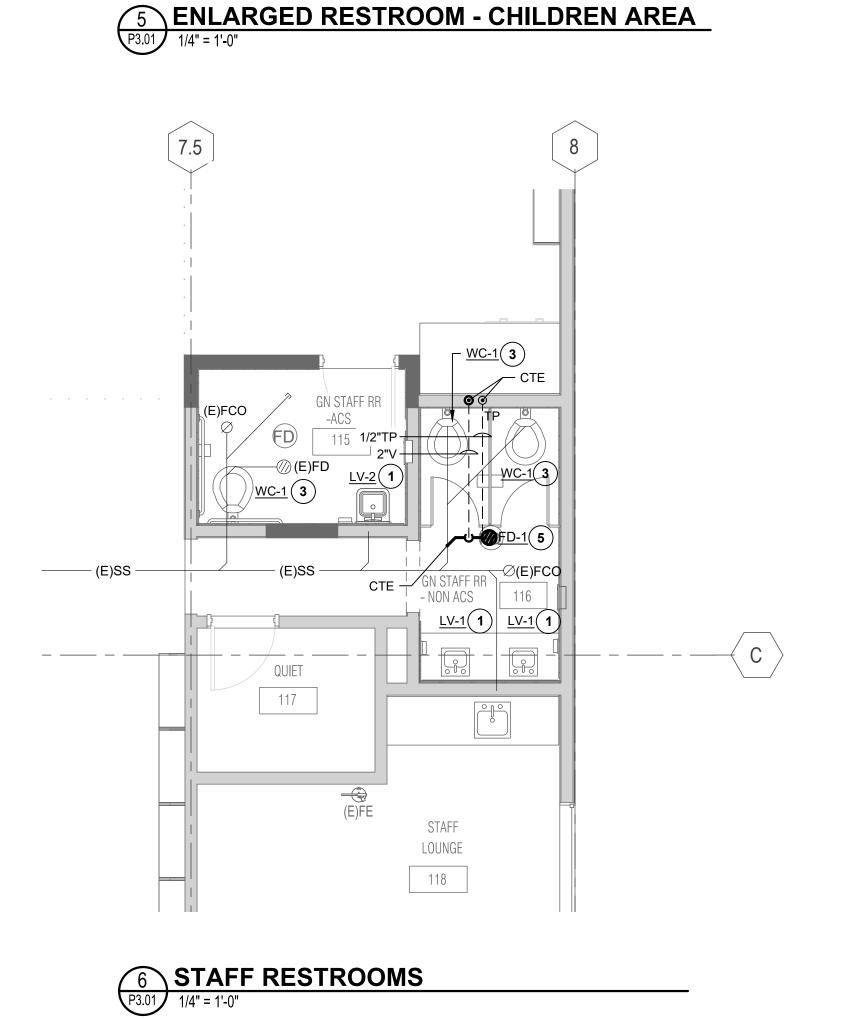

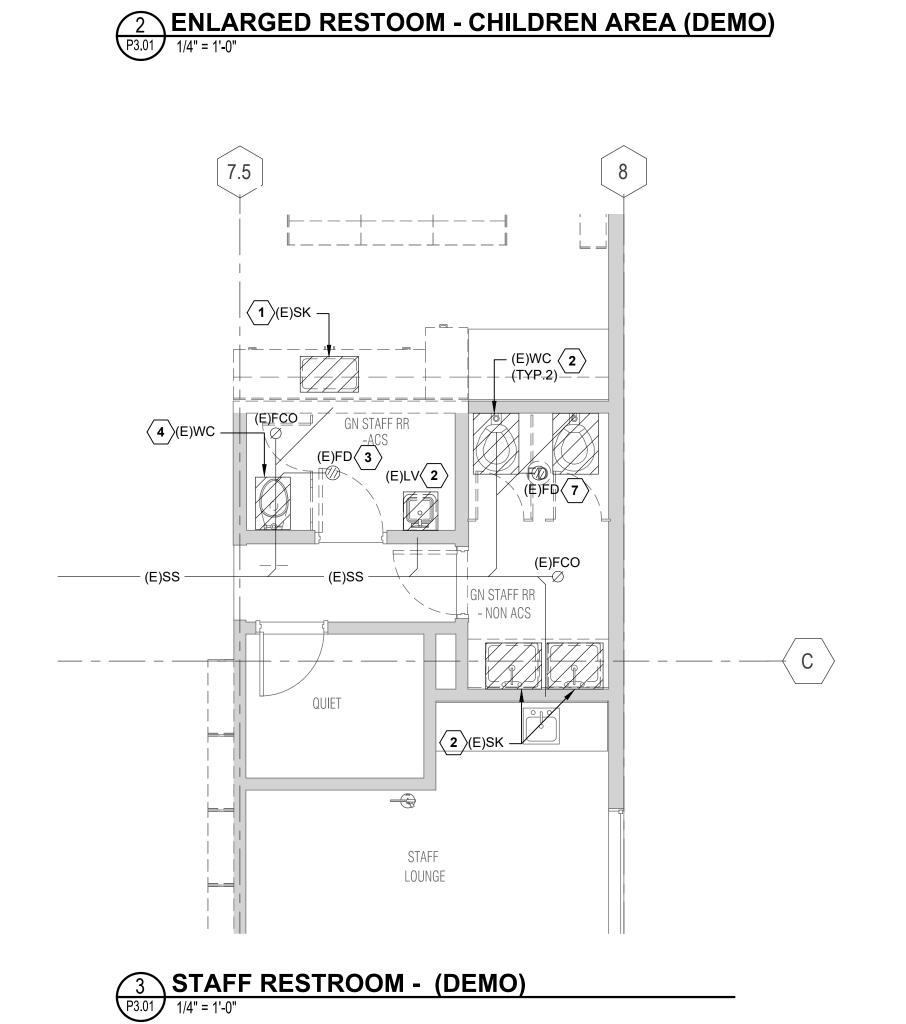

GENERAL NOTES


- 1. THE EXISTING PIPING AND SERVICES SHOWN ON THE DRAWINGS ARE BASED ON EXISTING AS-BUILT DRAWINGS DATED 05/26/1999 AND GENERAL FIELD INVESTIGATION. THE PLUMBING CONTRACTOR SHALL FIELD VERIFY THE EXACT LOCATION AND PIPE SIZES PRIOR TO INSTALLATION OF NEW WORK.
- 2. RELOCATE ANY VENT THROUGH ROOF OR PIPING IMPACTED BY THE SKYLIGHT LOCATION.

SHEET NOTES (DEMO):


- 1 REMOVE AND DISCARD EXISTING SINK AND ALL RELATED PIPING AND ACCESSORIES. CAP W, V, C, H PIPING AS NECESSARY.
- REMOVE AND DISCARD EXISTING LAVATORY, P-TRAP AND WATER LINES TO STOPS (STOPS ARE TO REMAIN). PREPARE EXISTING COUNTER FOR INSTALLATION OF NEW LAVATORY. PREPARE EXISTING WATER LINES AND WASTE LINE FOR CONNECTION TO NEW.
- (3) EXISTING FLOOR DRAIN TO REMAIN. ADJUST TOP OF DRAIN DURING FLOOR REPLACEMENT AS NEEDED.
- 4 REMOVE (E) WATER CLOSET AND ALL RELATED PIPING AND ACCESSORIES. CAP TOILET FLANGE, COLD WATER SUPPLY FOR NEW TOILET INSTALLATION.
- REMOVE (E) DRINKING FOUNTAIN AND ALL RELATED PIPING AND ACCESSORIES. CAP WASTE, COLD WATER SUPPLY FOR NEW DF INSTALLATION.
- 6 REMOVE (E) HOSE BIBB. CAP WATER LINE FOR FUTURE CONNECTION.
- 7 REMOVE (E) FLOOR DRAIN.

SHEET NOTES: (NEW)

- 1 PROVIDE NEW ADA LAVATORY, P-TRAP WITH INSULATION AND FLEXIBLE WATER LINES TO EXISTING WATER STOPS AT WALL.
- 2 PROVIDE NEW DRINKING FOUNTAIN, SUPPORT CARRIER, WASTE AND WATER LINE TO EXISTING WATER AND WASTE LINE IN WALL.
- 3 PROVIDE NEW WATER CLOSET. MODIFY EXISTING WASTE, VENT AND COLD WATER AS NECESSARY TO SUITE THE NEW LOCATION. CONNECT TO EXISTING PIPING SYSTEMS.
- (4) PROVIDE NEW HOSE BIBB. CONNECT TO EXISTING PIPING.
- (5) PROVIDE TRAP PRIMER IN WALL WITH ACCESS PANEL.
- (6) PROVIDE WATER HAMMER ARRESTOR IN WALL WITH ACCESS PANEL.
- 7) PROVIDE WALL CLEANOUT ABOVE THE FIXTURE CONNECTION FITTING SERVING URINALS.

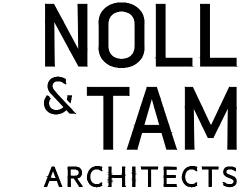

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PROJECT TITLE

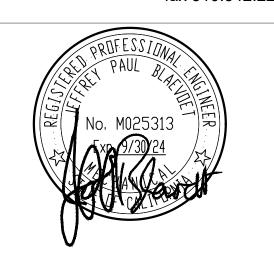SONOMA COUNTY **PETALUMA REGIONAL LIBRARY** RENOVATION PROJECT NO.

100 FAIRGROUNDS DRIVE PETALUMA, CA 94952

PERMIT SET

N&T JOB NUMBER


1 1/22/2024 RESUBMITTAL



ENLARGED PLANS -PLUMBING

SHEET NUMBER

P3.01

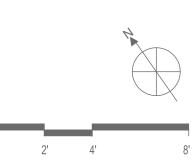

PLUMBING FIXTURE PIPING CONNECTION SCHEDULE								
FIXTURE	DESCRIPTION	PIPING TO FINAL BRANCH CONNECTION						
		W	V	С	Н			
WC	WATER CLOSET	4"	2"	1-1/4"	-			
LV	LAVATORY	2"	1-1/2"	1/2"	1/2"			
DF	DRINKING FOUNTAIN	2"	1-1/2"	1/2"	-			
НВ	HOSE BIBB	-	-	3/4"	-			

	PLUMBING FIXTURE SCHEDULE								
FIXTURE NUMBER									
WC-1	WATER CLOSET FLOOR MOUNTED ADA	SLOAN WETS-2021.1101, ELONGATED BOWL, TOP SPUD, 1.1 GPF.	INTEGRAL		INTEGRAL	INTEGRAL WITH FLUSH VALVE	OPEN FRONT SEAT CHURCH # 255SSC		
LV-1	LAVATORY UNDER COUNTER ADA	KOHLER LADENA K-2214, 21" x 12", VITREOUS CHINA, WHITE, UNGLAZED RIM FOR UNDER COUNTER MOUNT, WITH OVERFLOW	KOHLER SCULPTED "INSIGHT" K-13462, WITH TEMPERATURE MIXER, AC POWERED K-13480 TRANSFORMER, 0.5 GPM. FIELD ADJUST FAUCET TO FLOW NO MORE THAN 0.20 GPM PER CYCLE.	ZURN # Z8746-PC FLAT GRID STRAINER DRAIN 1-1/4" OFFSET TAILPIECE	ZURN 1-1/4"x1-1/2" #Z-8701-9LC-PC, 17 GA.	BRASSCRAFT SPEEDWAY #KTS-R-1-01-B-C SERIES 1/4 TURN LOOSE KEY ANGLE STOP		2 4	
LV-2	LAVATORY WALL MOUNTED ADA	KOHLER SOHO K-2084-NR, 20" x 18", VITREOUS CHINA, WHITE, SINGLE HOLE, WITH SEALED OVERFLOW.	KOHLER SCULPTED "INSIGHT" K-13462, WITH TEMPERATURE MIXER, AC POWERED K-13480 TRANSFORMER, 0.5 GPM. FIELD ADJUST FAUCET TO FLOW NO MORE THAN 0.20 GPM PER CYCLE.	ZURN # Z8746-PC FLAT GRID STRAINER DRAIN 1-1/4" OFFSET TAILPIECE	ZURN 1-1/4"x1-1/2" #Z-8701-9LC-PC, 17 GA.	BRASSCRAFT SPEEDWAY #KTS-R-1-01-B-C SERIES 1/4 TURN LOOSE KEY ANGLE STOP		2 (4	
DF-1	DRINKING FOUNTAIN WALL MOUNTED WITH BOTTLE FILLER ADA	ELKAY, MODEL #LZSTL8WSSP, 18 GAUGE, TYPE 304 STAINLESS STEEL, PUSH BUTTON, WITH FILTERED BI-LEVEL LZ COOLER, CHILLING CAPACITY 8.0 GPH.	INTEGRAL BUBBLER FLOW RATE = 0.5 GPM BOTTLE FILLER FLOW RATE = 1.0 GPM	INTEGRAL	ZURN 1-1/4"x1-1/2" #Z-8701-9LC-PC, 17 GA.	BRASSCRAFT SPEEDWAY #CR-1900-S2 SERIES LOOSEKEY ANGLE STOP	115V, 4.2A, 370W, 94 LBS SHIPPING WEIGHT		
HB-1	HOSE BIBB	ZURN Z1350, NARROW WALL HYDRANT					INSTALL @ 18" AFF		

	DRAIN SCHEDULE 12								
0)/115-01	TVDE	TRAP		GRATE	MANUFACTURER AND				
SYMBOL	TYPE	SIZE (IN)	MATERIAL	SIZE (IN)	MODEL NUMBER	REMARKS			
FD-1	FLOOR DRAIN	2", 4"	CI	Ø5"	ZURN #ZN-415-5BL-P-VP	FLOOR DRAIN WITH CAST IRON BODY, TYPE "BL" STRAINER, POLISHED NICKEL BRONZE ROUND TOP; PROVIDE TRAP PRIMER.			
WCO	WALL CLEANOUT	2", 3", 4"		5"/7"	ZURN #Z-1446-BP-VP	WALL CLEANOUT, CAST IRON BODY WITH BRONZE PLUG AND STAINLESS STEEL COVER WITH VANDAL-PROOF SCREW.			
FCO	FLOOR CLEANOUT	3", 4"		Ø6"	ZURN #Z-1400-VP	FLOOR CLEANOUT, CAST IRON BODY WITH NICKEL BRONZE TOP.			
GCO	GRADE CLEANOUT	6"		Ø9"	ZURN #ZN-1474-VP	GRADE CLEANOUT, CAST IRON BODY WITH NICKEL BRONZE TOP.			

3 PROVIDE LEAD-FREE PRODUCTS.

4 PROVIDE THERMOSTATIC MIXING VALVE SYMMONS #7-225-CK-MS OR EQUIVALENT. SET @ 105°F.

NOTES:

(1) ALL TRAPS SHALL BE IAPMO APPROVED. ALL FIXTURE TRAPS SHALL BE APPROVED BY THE CODE AUTHORITY HAVING JURISDICTION.


PLUMBING FIXTURE SCHEDULE NOTES:

2 PROVIDE PROWRAP SEAMLESS INSULATOR COVERS FOR DRAIN AND SUPPLY LINES.

- 1 ALL PRODUCTS ARE "OR EQUAL".
- 2 PROVIDE VANDAL-RESISTENT PRODUCTS.

NOLL & TAM ARCHITECTS

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PROJECT TITLE

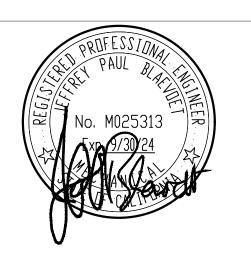PETALUMA
REGIONAL
LIBRARY
RENOVATION
PROJECT NO.
10-19

100 FAIRGROUNDS DRIVE PETALUMA, CA 94952

PERMIT SET

ISSUE DATE 11/27/20

N&T JOB NUMBER 2182

REVISIONS

DATE DESCRIPTION

REVIEWED FOR CODE COMPLIANCE 05/03/2024

Shums Coda Associates

SHEET TITLE

SCHEDULES

SHEET NUMBER

P5.01

PROVALS

GENERAL NOTES

- A. GENERAL
- VERTICAL AND HORIZONTAL OFFSETS SHOWN IN DUCTS AND PIPES INDICATE THE GENERAL RELATIONSHIP OF THE SYSTEMS. PROVIDE ADDITIONAL OFFSETS SIMILAR TO THOSE SHOWN AS REQUIRED TO SUIT CONSTRUCTION AND WORK DONE BY OTHER TRADES.
- 2. INSTALL ALL DAMPERS, ETC., IN ACCESSIBLE LOCATIONS. PROVIDE ADEQUATELY SIZED ACCESS DOORS WHERE REQUIRED.
- 3. INSTALL ALL DUCTWORK TO AVOID ARCHITECTURAL FRAMING. STRUCTURAL MEMBERS AND OTHER CONSTRUCTION. COORDINATE DUCT LAYOUT WITH ALL OTHER TRADES BEFORE FABRICATION AND INSTALLATION.
- 4. DUCT SIZES ARE INDICATED ON BRANCH WHERE THE DUCT AND OR PIPE REDUCES TO THE SMALLER DIMENSION.
- B. HVAC

1. LOCATE CEILING AIR OUTLETS ACCORDING TO THE ARCHITECTURAL REFLECTED CEILING PLANS. CONFIRM CEILING TYPES SHOWN ON ARCHITECTURAL DRAWINGS AND INSTALL CEILING TYPE SUPPLY AND RETURN OR EXHAUST OUTLETS TO SUIT.


2. ALL DUCT SIZES SHOWN ARE INSIDE CLEAR DIMENSIONS.


ABOVE ACCESSIBLE CEILINGS.

- 3. WHERE FLEXIBLE DUCT CONNECTORS ARE USED, THEY SHALL BE EQUAL TO OR GREATER THAN CROSS-SECTIONAL AREA OF DUCTS SHOWN. FOR MAXIMUM ALLOWABLE LENGTH SEE SPECIFICATION SECTION 233100. "DUCTWORK."
- 4. PROVIDE TURNING VANES IN ALL SQUARE ELBOWS. RADIUS ELBOWS WITHOUT TURNING VANES SHALL BE USED IN ALL EXHAUST AND RETURN DUCTS EXCEPT WHERE SHOWN OR NOTED ON DRAWINGS. WHERE SQUARE ELBOWS ARE SHOWN IN EXHAUST AND RETURN DUCTS, ACCESS DOORS SHALL BE PROVIDED IMMEDIATELY UPSTREAM OF VANES.

5. VOLUME DAMPERS SHALL BE INSTALLED IN ALL BRANCH SUPPLY AND

EXHAUST OR RETURN DUCTS. LOCATE DAMPERS AS FAR AS POSSIBLE

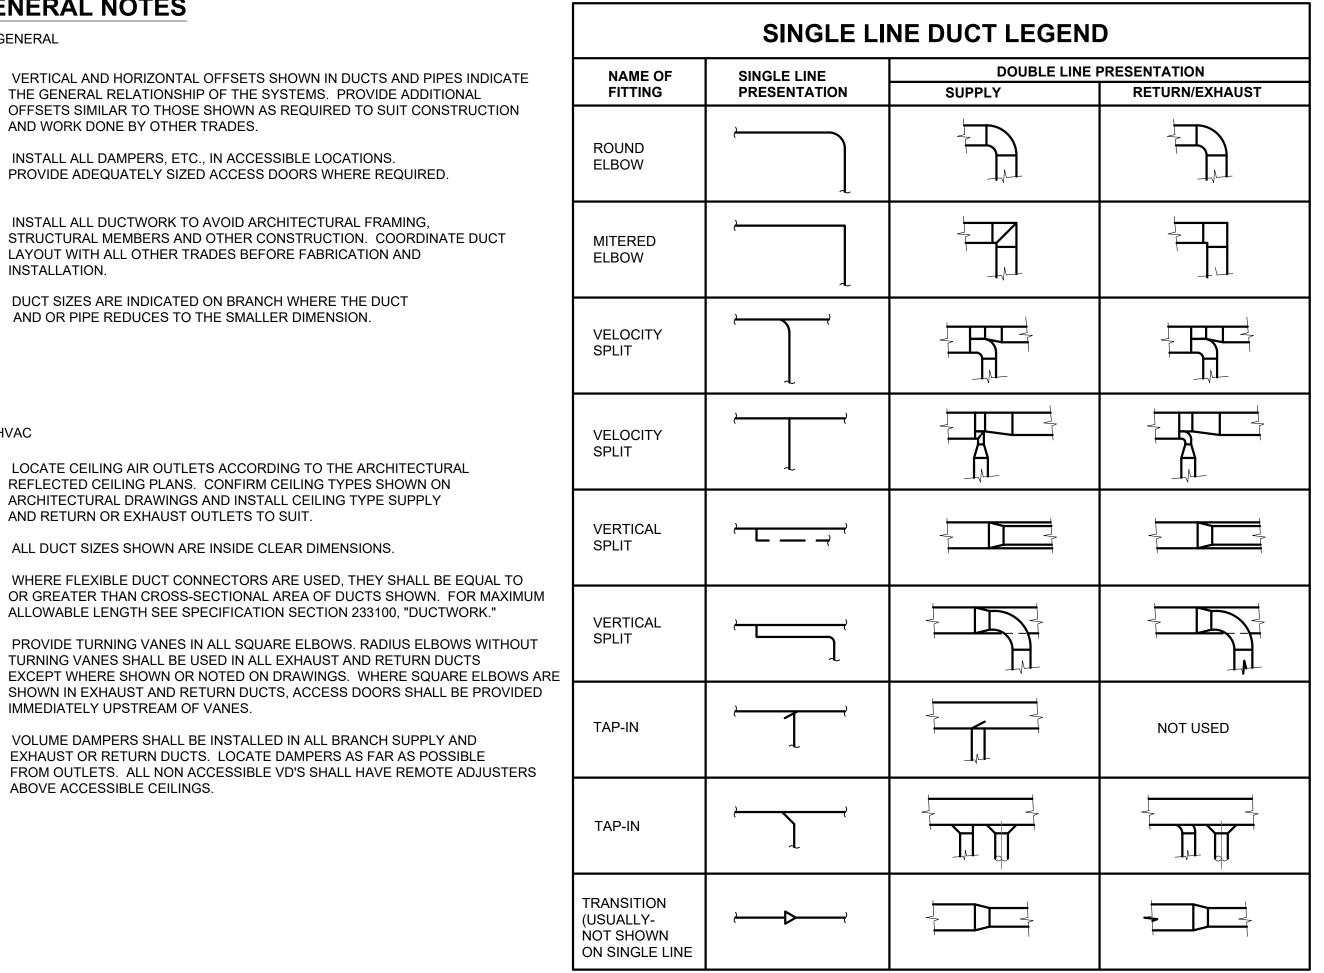

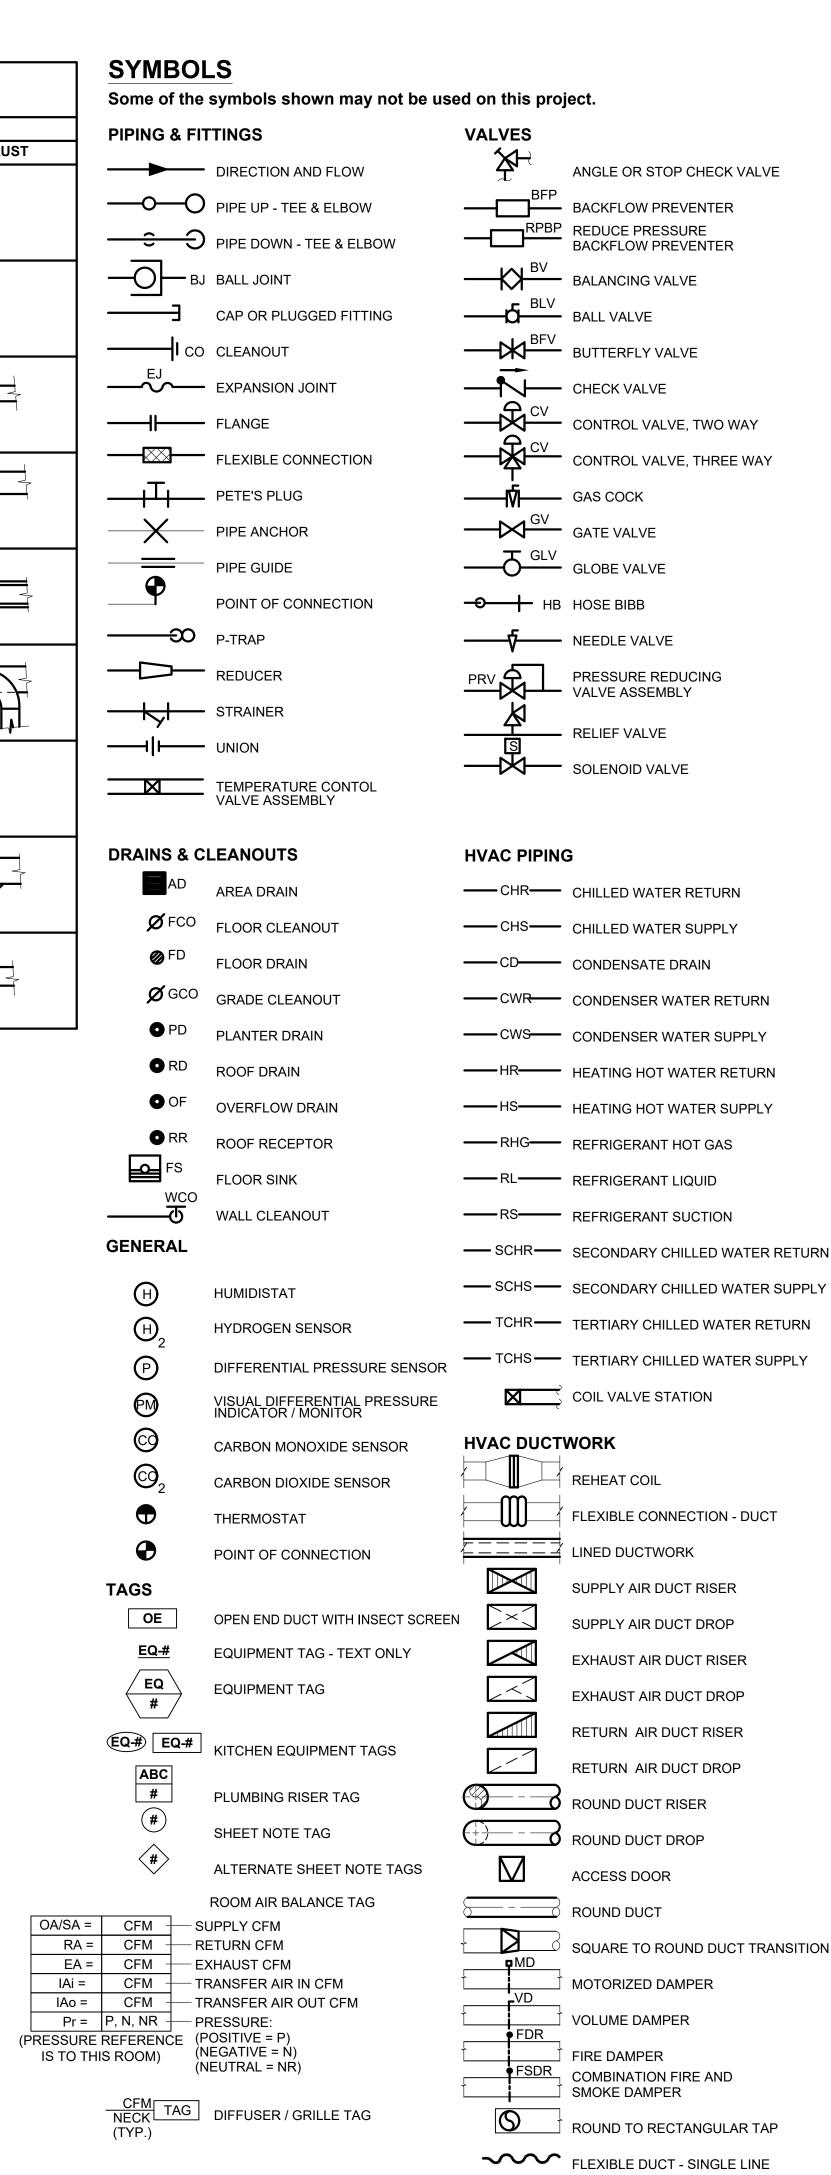

MECHANICAL LEGEND (SOME OF THE ABBREVIATIONS AND SYMBOLS SHOWN MAY NOT BE USED ON THIS PROJECT.) A(*) COMPRESSED AIR (*PSI WHERE REQUIRED) FIN FINISHED O2 OXYGEN AREA DRAIN FIRE LINE OA OUTSIDE AIR SEE ARCHITECTURAL DRAWINGS AND DOCUMENTS FLG FLANGE OUTSIDE DIMENSION ABOVE FINISHED FLOOR FLR FLOOR OSY OUTSIDE STEM AND YOKE ACCESS PANEL FM FLOW METER OV OUTLET VELOCITY ACID VENT FUEL OIL PCHS PRIMARY CHILLED WATER SUPPLY AVTR ACID VENT THRU ROOF PCHR PRIMARY CHILLED WATER RETURN FUEL OIL FILL PUMP DISCHAGE/PRESSURE DROP ACID WASTE FUEL OIL GAUGE BOILER BLOW DOWN FUEL OIL RETURN PLUG FOR FUTURE **BOILER FEED** PRESSURE GAUGE FUEL OIL SUPPLY BACKFLOW PREVENTER FUEL OIL VENT PNEUMATIC INTERFACE BFV BUTTERFLY VALVE FEET PER MINUTE PIV POST INDICATOR VALVE BRAKE HORSEPOWER / PLBG PLUMBING FLOW SWITCH BOILER HORSEPOWER FSDR COMBINATION FIRE AND SMOKE DAMPER PUMP RETURN BLDG BUILDING PRV PRESSURE REDUCING VALVE FSK FLOOR SINK BLV BALL VALVE FTT FLOAT AND THERMOSTAT TRAP POUNDS PER SQUARE INCH BMS BUILDING MANAGEMENT SYSTEM FUT FUTURE PSIG POUNDS PER SQUARE INCH GAUGE BOD BOTTOM OF DUCT PNEUMATIC TUBE SYSTEM PTS NATURAL GAS BATH TUB PW PUMP WASTE BALANCING VALVE RETURN AIR GRADE CLEANOUT BACKWATER VALVE BWV ROOF DRAIN GALVANIZED IRON DOMESTIC COLD WATER GLV RETURN FAN GLOBE VALVE CC COOLING COIL RELATIVE HUMIDITY GALLONS PER HOUR CD CONDENSATE DRAIN REFRIGERANT HOT GAS GR GRADE CF CHEMICAL FEED **GATE VALVE** ROUGH IN AND CONNECT CAP FOR FUTURE DOMESTIC HOT WATER RIO ROUGH IN ONLY CFH CUBIC FEET PER HOUR (*TEMP. WHERE REQ'D.) REFRIGERANT LIQUID CFM CUBIC FEET PER MINUTE HOSE BIBB RPBP REDUCED PRESSURE BACKFLOW CO2 CARBON DIOXIDE **HEATING COIL** PREVENTER CHET CHILLED WATER EXPANSION TANK RPM REVOLUTIONS PER MINUTE HELIUM CHILLED WATER RETURN REFRIGERANT SUCTION HOT WATER EXPANSION TANK CHS CHILLED WATER SUPPLY RELIEF VENT/ROOF VENTILATOR HIGH PRESSURE DRIP TRAP CAST IRON HIGH PRESSURE CONDENSATE RETURN RVV RELIEF VALVE VENT CLG CEILING SA SUPPLY AIR/SHOCK ARRESTOR HIGH PRESSURE STEAM CO CLEANOUT SB STZ BATH HEATING HOT WATER RETURN SCHS SECONDARY CHILLED WATER SUPPLY COND CONDENSER/CONDENSING/CONDENSATE HEATING HOT WATER SUPPLY CP CHROME PLATED SCHR SECONDARY CHILLED WATER RETURN HTG HEATING CPVC CHLORINATED POLYVINYL CHLORIDE HU HUMIDIFIER SIGHT DRAIN CRP CONDENSATE RETURN PUMP SDD SEE STRUCTURAL DRAWINGS AND DOCUMENTS HEATING AND VENTILATING CS DOMESTIC COLD WATER (SOFT) SDR SMOKE DAMPER HVAC HEATING VENTILATING AND AIR CONDITIONING CSK CLINICAL SINK SUPPLY FAN DOMESTIC HOT WATER RETURN CTE CONNECT TO EXISTING SHOWER HERTZ CONTROL VALVE SK SINK CWR CONDENSER WATER RETURN SM SHEET METAL INVERT ELEVATION SMD SEE MECHINCAL DRAWINGS CWS CONDENSER WATER SUPPLY IN FURRED SPACE DRY BULB TEMPERATURE FIRE SPRINKLER DIGITAL TO PNEUMATIC INTERFACE DDC DIRECT DIGITAL CONTROL SPD SPRINKLER DRAIN IRON PIPE SIZE DEIONIZED WATER STAINLESS STEEL IRRIGATION WATER DRINKING FOUNTAIN SSD SUBSURFACE DRAIN INDIRECT WASTE DISTILLED WATER SSK SERVICE SINK RAINWATER DOOR LOUVER ST STEAM TRAP LABORATORY COMPRESSED AIR STD STANDARD LEAVING AIR TEMPERATURE/LATENT DRAIN STL STEEL LOW PRESSURE DRY STANDPIPE STR SOUND TRAP LOW PRESSURE DRIP TRAP DRIP TRAP STEAM VENT LIQUID PETROLEUM GAS DWG DRAWING SPECIAL WASTE LOW PRESSURE CONDENSATE RETURN **EXISTING** TCA TEMPERATURE CONTROL AIR LOW PRESSURE STEAM EA EXHAUST AIR TCV TEMPERATURE CONTROL VALVE LAVATORY EAT ENTERING AIR TEMPERATURE TCHS TERTIARY CHILLED WATER SUPPLY LVG LEAVING EXTRACTION DAMPER TCHR TERTIARY CHILLED WATER RETURN LWCO LOW WATER CUT-OFF EXHAUST FAN TRENCH DRAIN LEAVING WATER TEMPERATURE **EXPANSION JOINT** THERMOMETER MEDICAL COMPRESSED AIR **ELEVATION** TRAP PRIMER THOUSAND BRITISH THERMAL EMS ENERGY MANAGEMENT SYSTEM TONS OF REFRIGERATION UNITS PER HOUR ENT ENTERING TIP SPEED MCC MOTOR CONTROL CENTER EO ETHYLENE OXIDE TSP TOTAL STATIC PRESSURE MOTORIZED DAMPER EOV ETHYLENE OXIDE VENT TURNING VANES MANUFACTURER ESP EXTERNAL STATIC PRESSURE URINAL MEDICAL GAS EVAC GAS EVACUATION SANITARY VENT MGA MEDICAL GAS ALARM EWT ENTERING WATER PRESSURE VAC MEDICAL VACUUM MPDT MEDIUM PRESSURE DRIP TRAP EXH EXHAUST VACUUM BREAKER MEDIUM PRESSURE CONDENSATE RETUR FIRE LINE VCP VITRIFIED CLAY PIPE MEDIUM PRESSURE STEAM FA FACE AREA **VOLUME DAMPER** FLEXIBLE CONNECTION VELOCITY NITROGEN FCO FLOOR CLEANOUT VARIABLE FREQUENCY DRIVE NORMALLY CLOSED FD FLOOR DRAIN VTR VENT THRU ROOF NFA NET FREE AREA FDC FIRE DEPARTMENT CONNECTION VAPOR VENT NFPA NATIONAL FIRE PROTECTION ASSOCIATION FDR FIRE DAMPER WASTE NORMALLY OPEN FE FIRE EXTINGUISHER WET BULB TEMPERATURE NITROUS OXIDE FEC FIRE EXTINGUISHER CABINET WATER CLOSET NOT TO SCALE FINISHED FLOOR LEVEL WCO WALL CLEANOUT NON-POTABLE WATER FH FIRE HYDRANT WEATHER OR WATER PROOF

OPEN END DUCT

FHC FIRE HOSE CABINET

VOLUME DAMPER WITH

BACKDRAFT DAMPER

REMOTE ADJUSTER

DRAWING LIST Sheet Number | Sheet Title LEGEND, SYMBOLS, GENERAL NOTES & DRAWING LIST M1.31A DEMOLITION PLAN - 1ST FLOOR AND MEZZANINE - HVAC - DEDUCT ALTERNATE #1 ARCHIVE MECHANICAL PLAN FOR REFERENC ONLY FLOOR PLAN - 1ST FLOOR AND MEZZANINE - HVAC M2.31A FLOOR PLAN -1ST FLOOR AND MEZZANINE - HVAC - DEDUCT ALTERNATE #1 ENLARGED PLANS - HVAC 2 M3.01A ENLARGED PLANS - HVAC - DEDUCT ALTERNATE #1 M4.01A DETAILS - DEDUCT ALTERNATE #1 M4.01A DETAILS - DEDUCT ALTERNATE #1

WSP

(X)


WET STAND PIPE

WEIGHT

REMOVE

ARCHITECTS

729 Heinz Avenue Berkeley, CA 94710 tel 510.542.2200 fax 510.542.2201

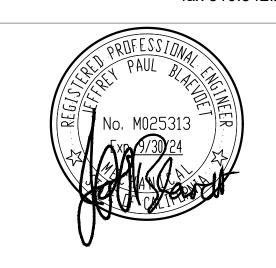



E g&b@gb-eng.com

PROJECT TITLE

SONOMA COUNTY PETALUM REGIONAL LIBRARY RENOVATION PROJECT NO.

100 FAIRGROUNDS DRIVI PETALUMA, CA 94952

PERMIT SET


N&T JOB NUMBER 2 4/25/2024 RESUBMITTAL 2

> REVIEWED FOR CODE COMPLIANCE 05/03/2024 Shums Coda Associates

LEGEND, SYMBOLS, **GENERAL NOTES &** DRAWING LIST


SHEET NUMBER

M0.01

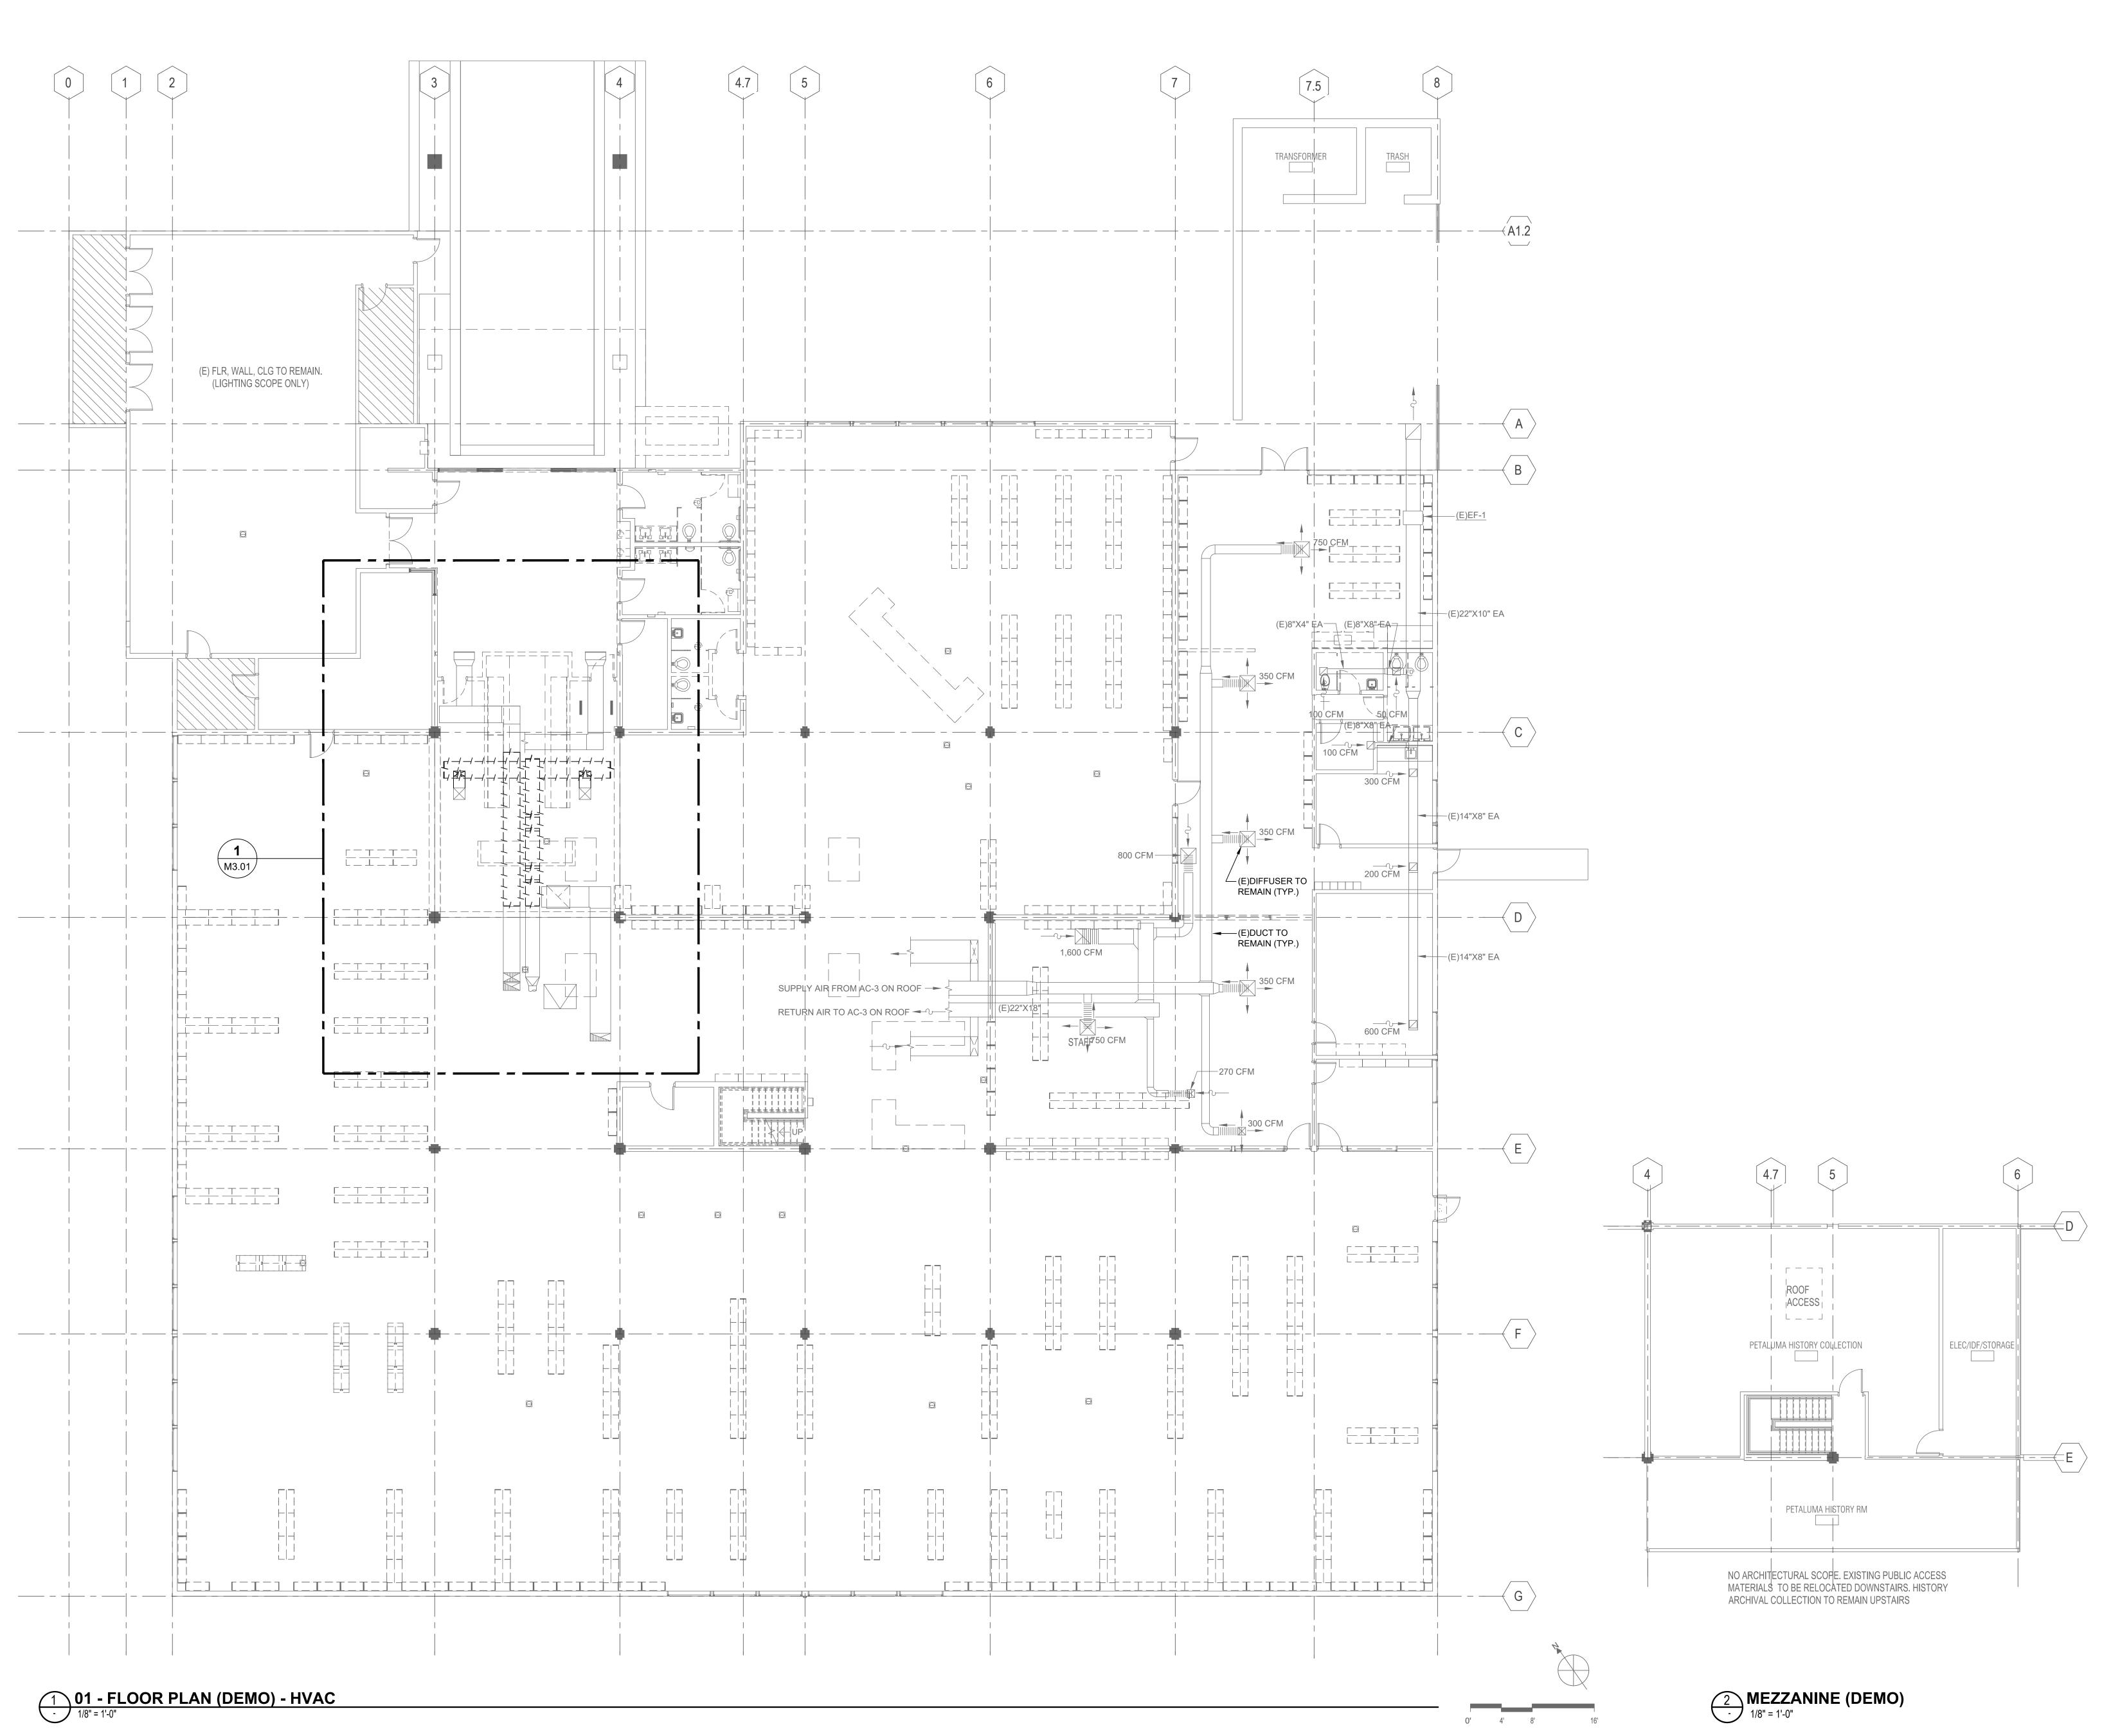

NOLL STAM ARCHITECTS

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PROJECT TITLE
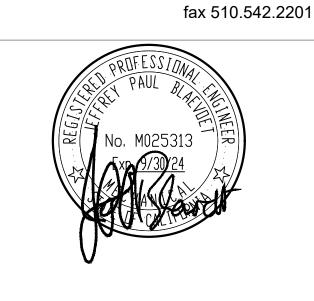
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RENOVATION
PROJECT NO.
10-19

100 FAIRGROUNDS DRIVE PETALUMA, CA 94952

PERMIT SET

 ISSUE DATE
 11/20/2023

 N&T JOB NUMBER
 21824

REVISIONS

DATE DESCRIPTION

REVIEWED FOR CODE COMPLIANCE


05/03/2024

Shums Coda Associates

DEMOLITION PLAN - 1ST
FLOOR AND MEZZANINE
- HVAC

SHEET NUMBER

M1.31

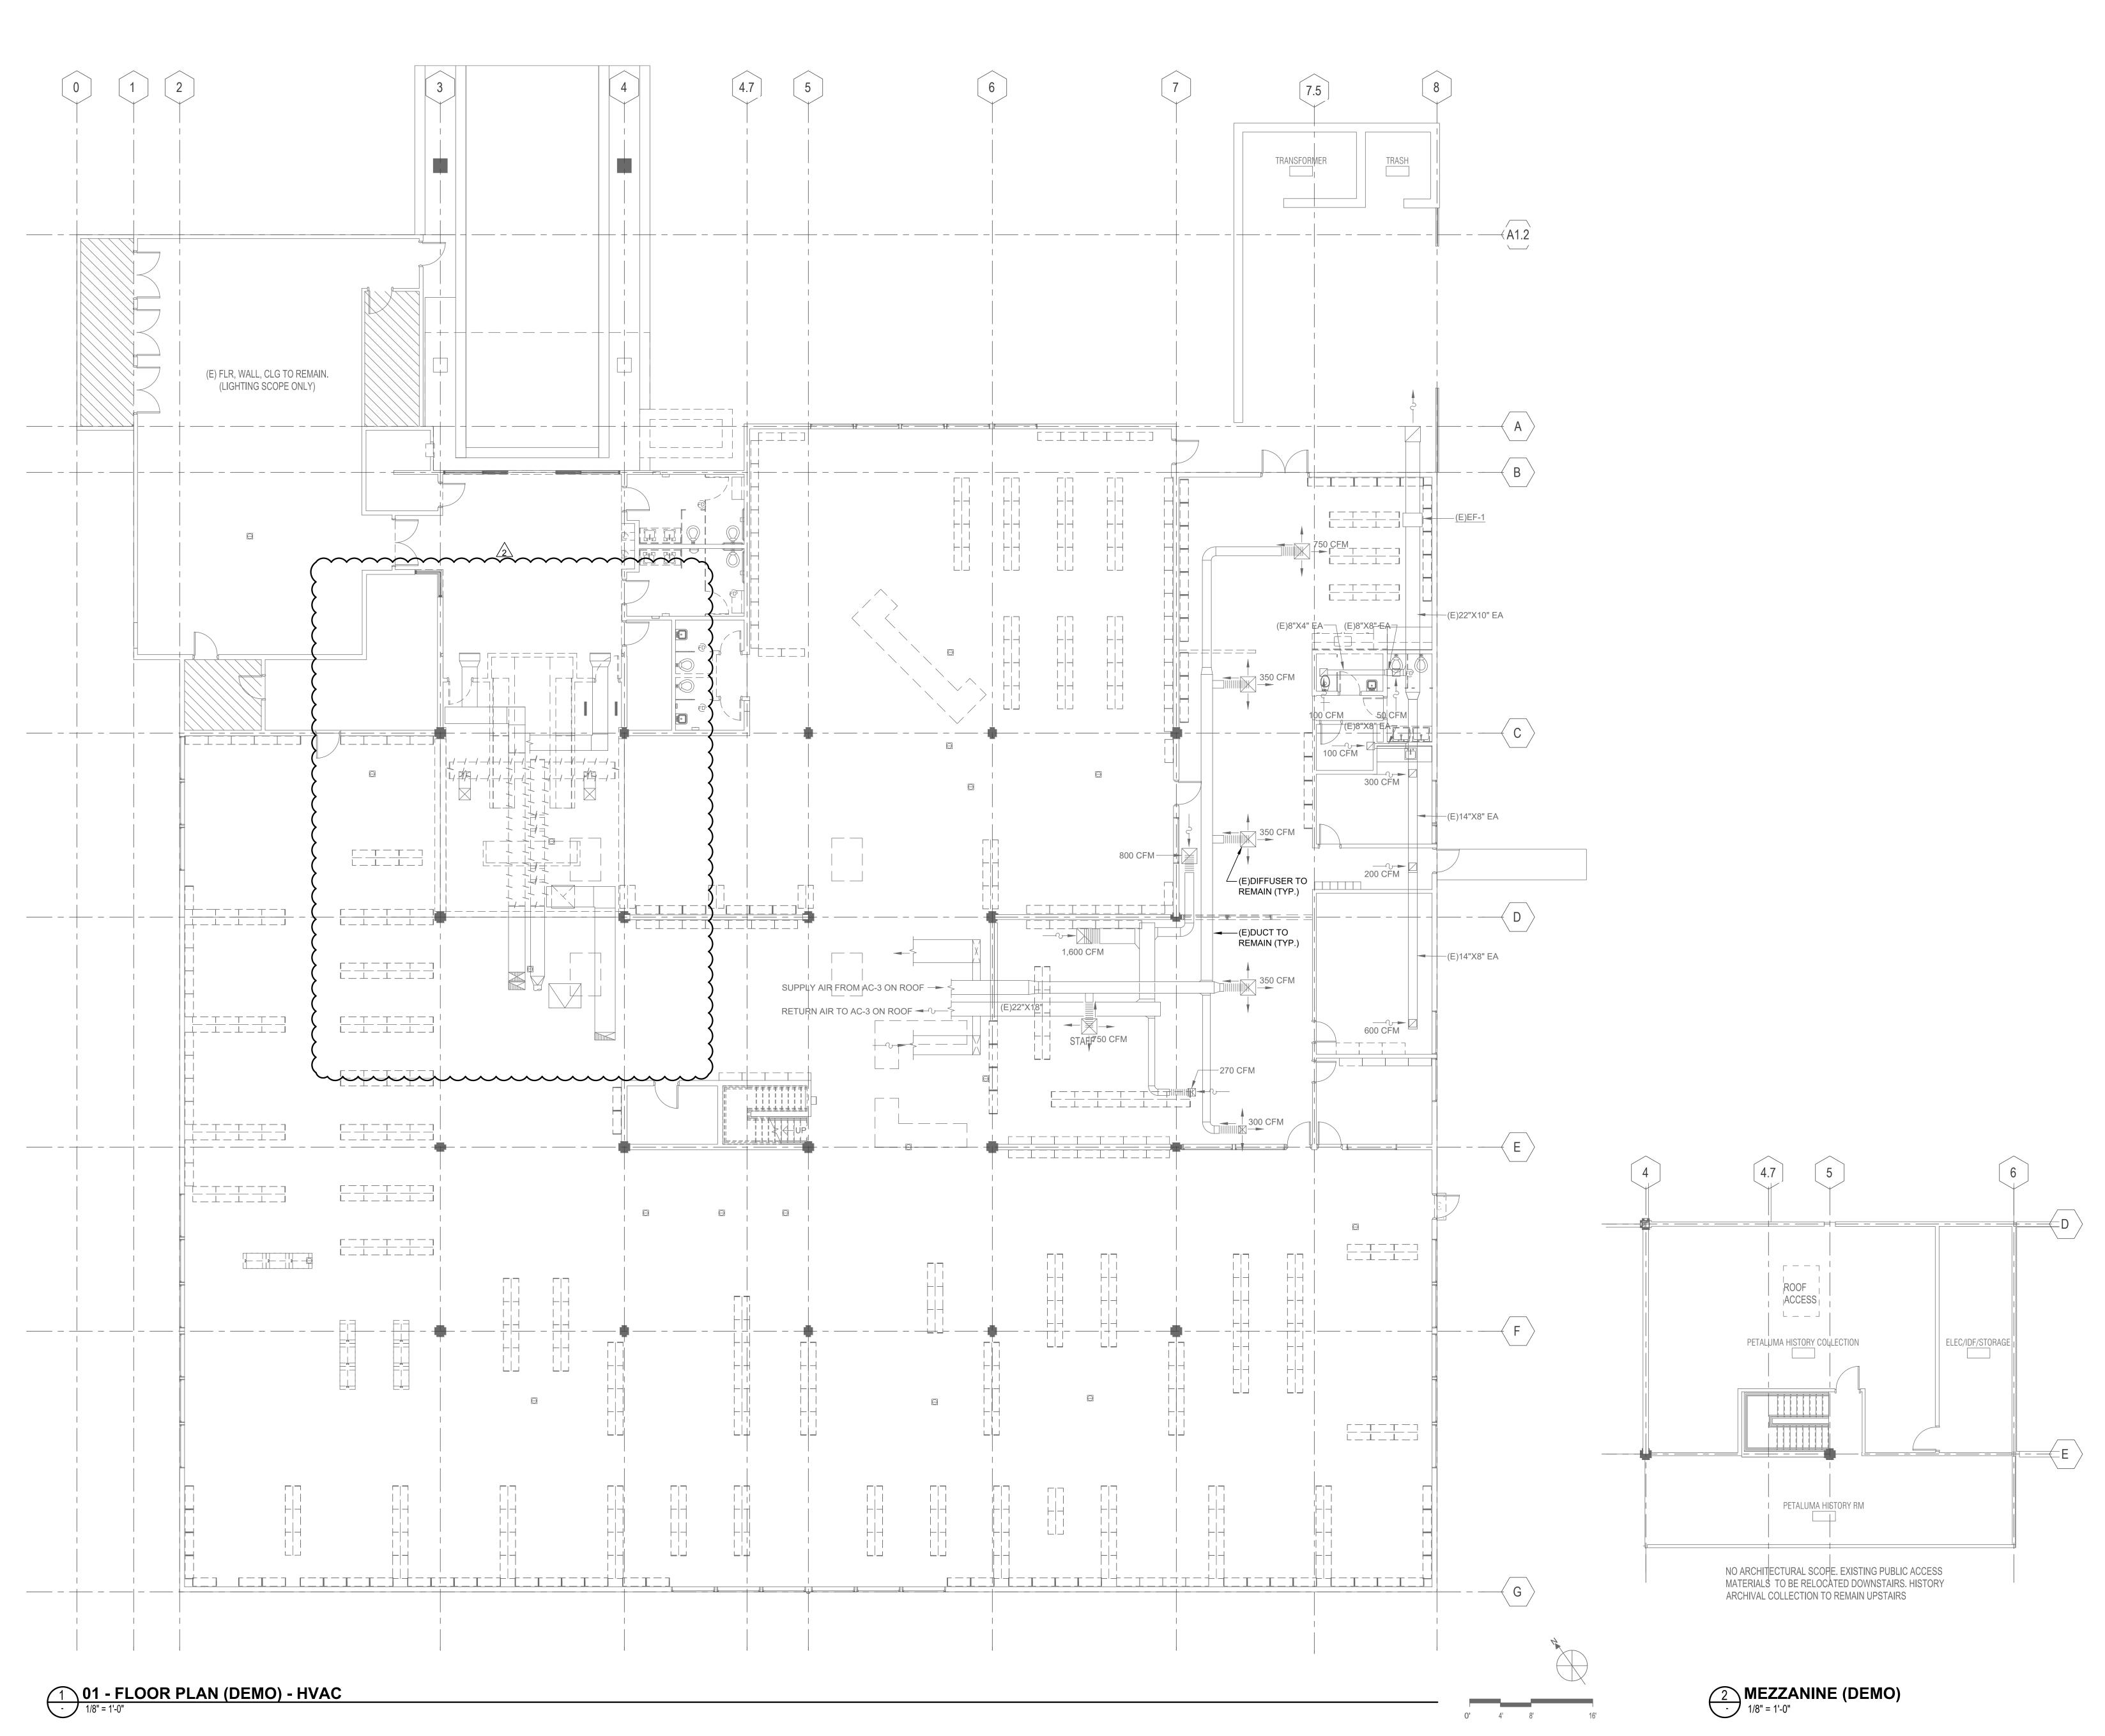

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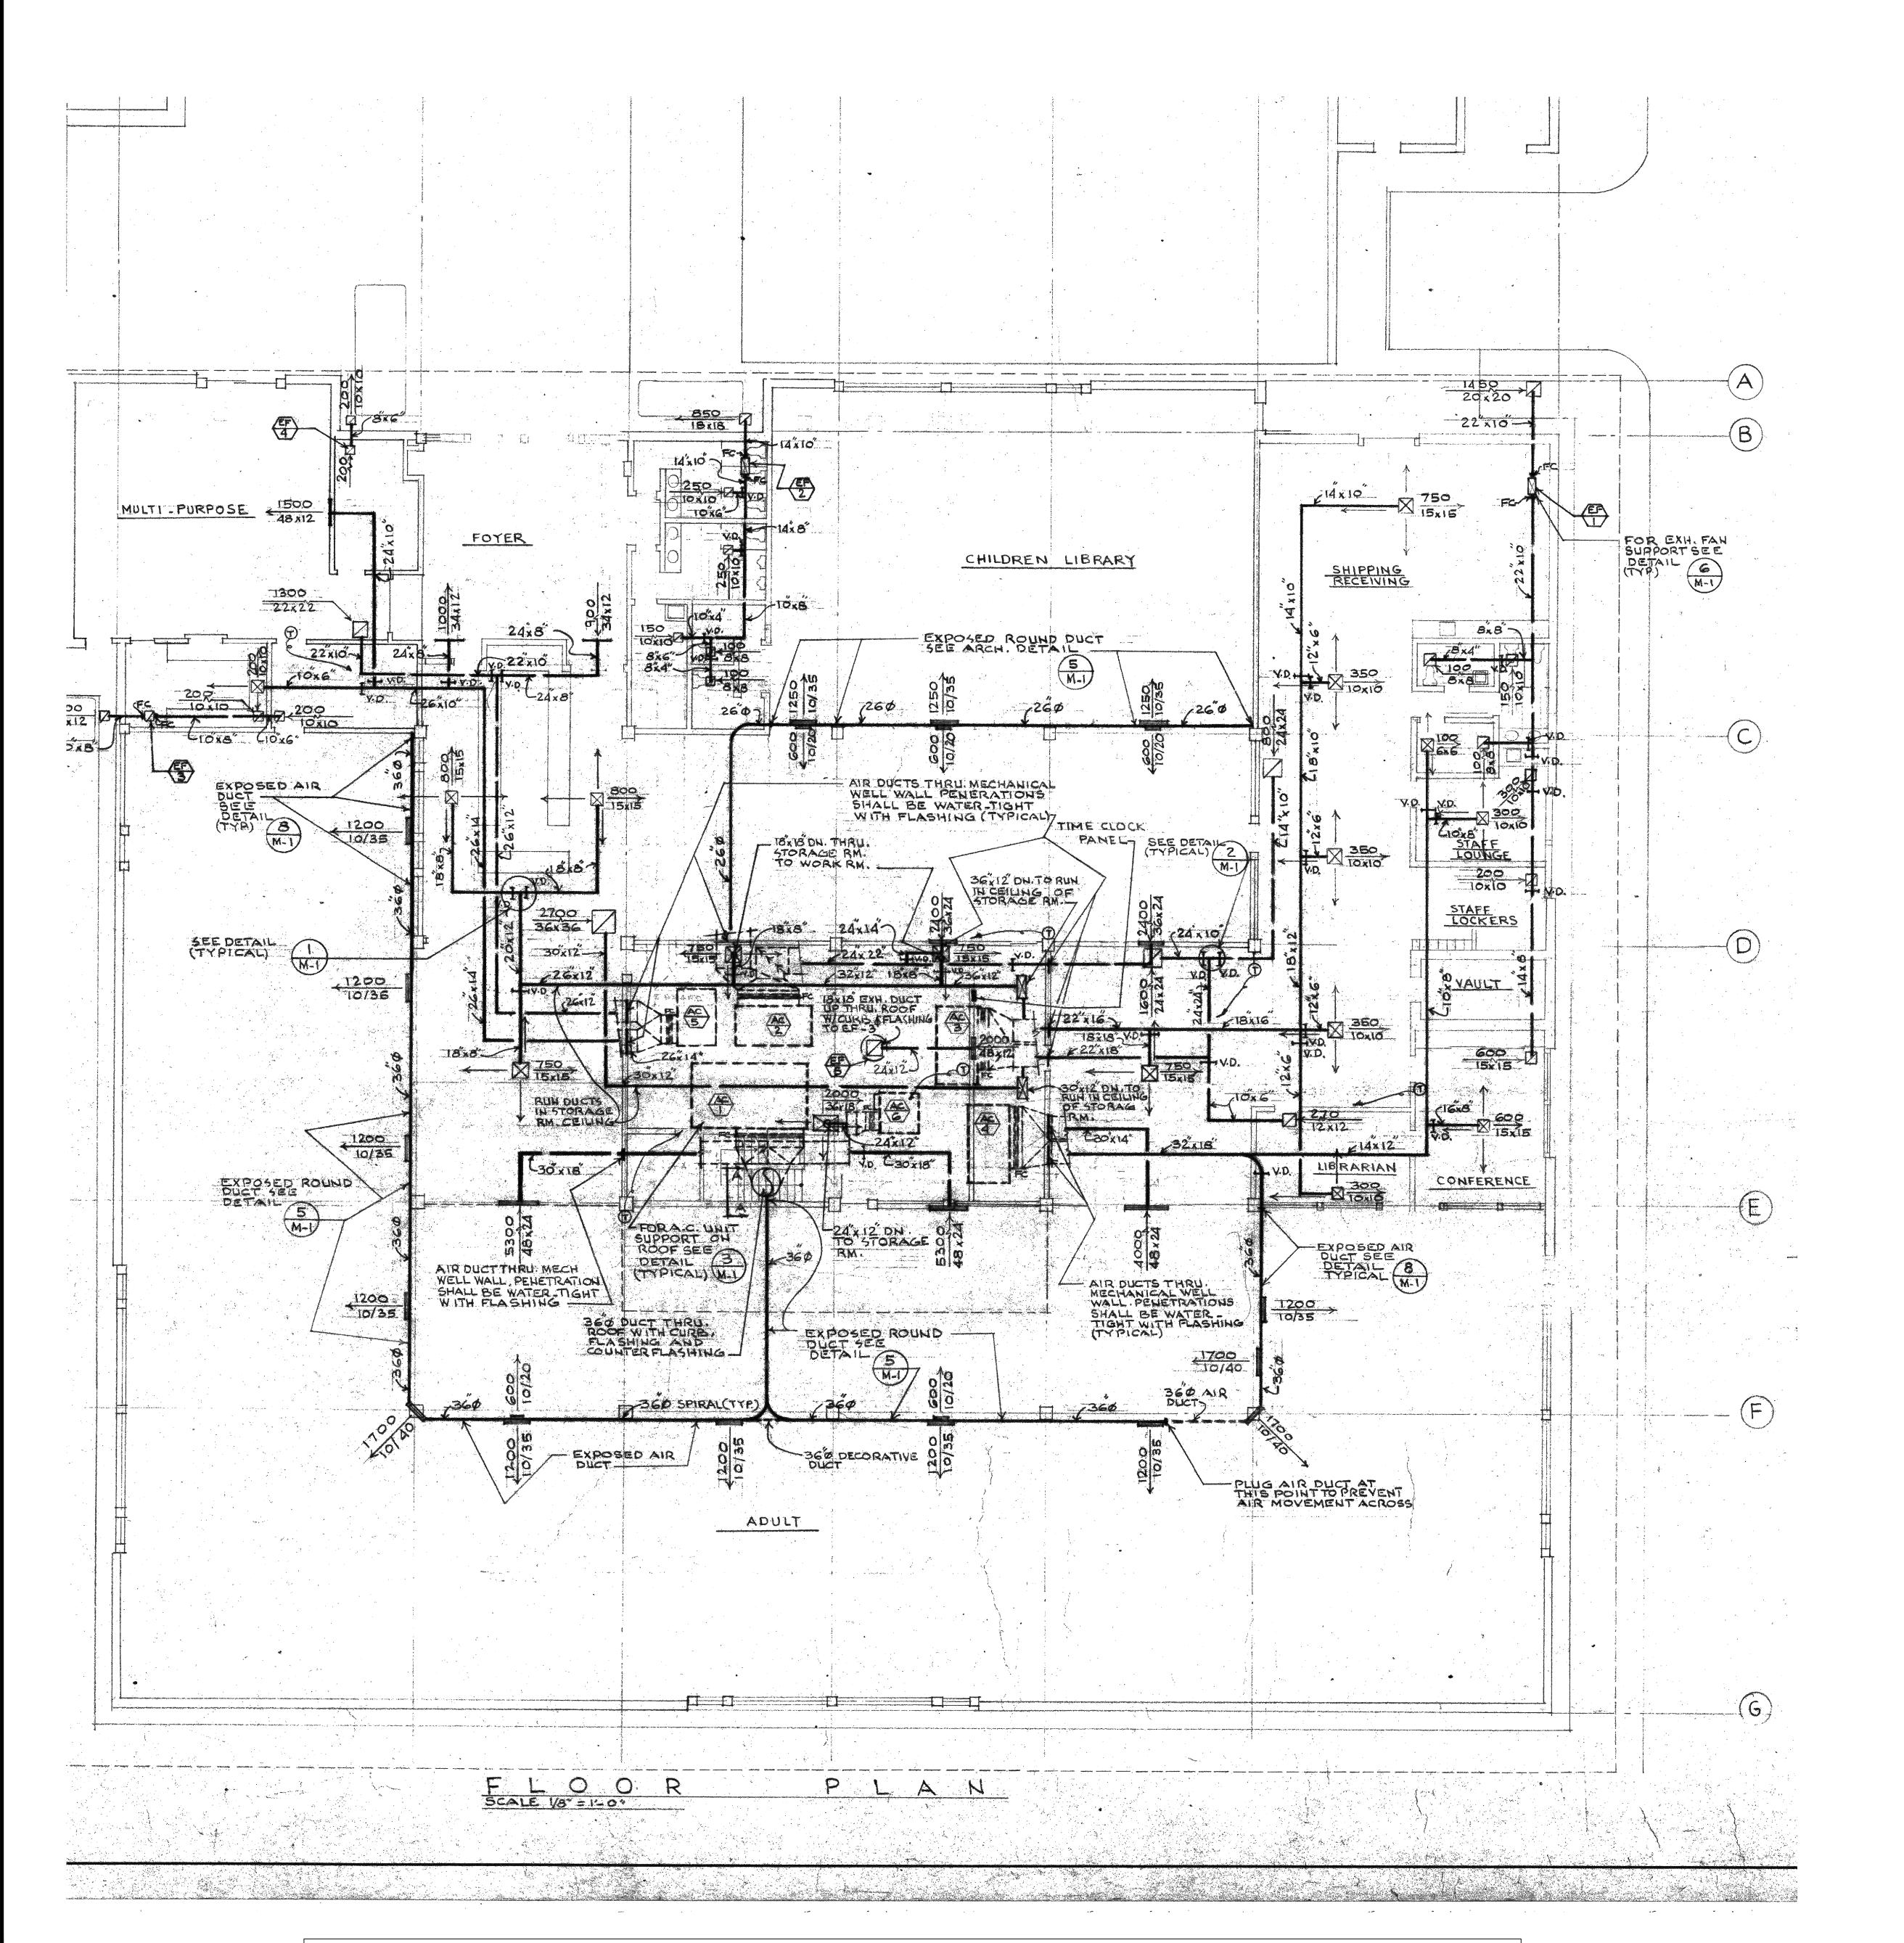
05/03/2024

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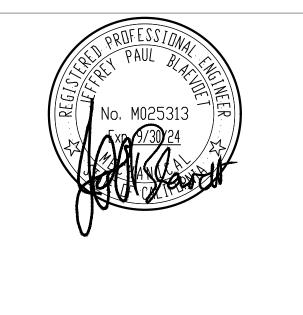
DEMOLITION PLAN – 1ST
FLOOR AND MEZZANINE
– HVAC – DEDUCT
ALTERNATE #1

SHEET NUMBER

M1.31A









PROJECT TI

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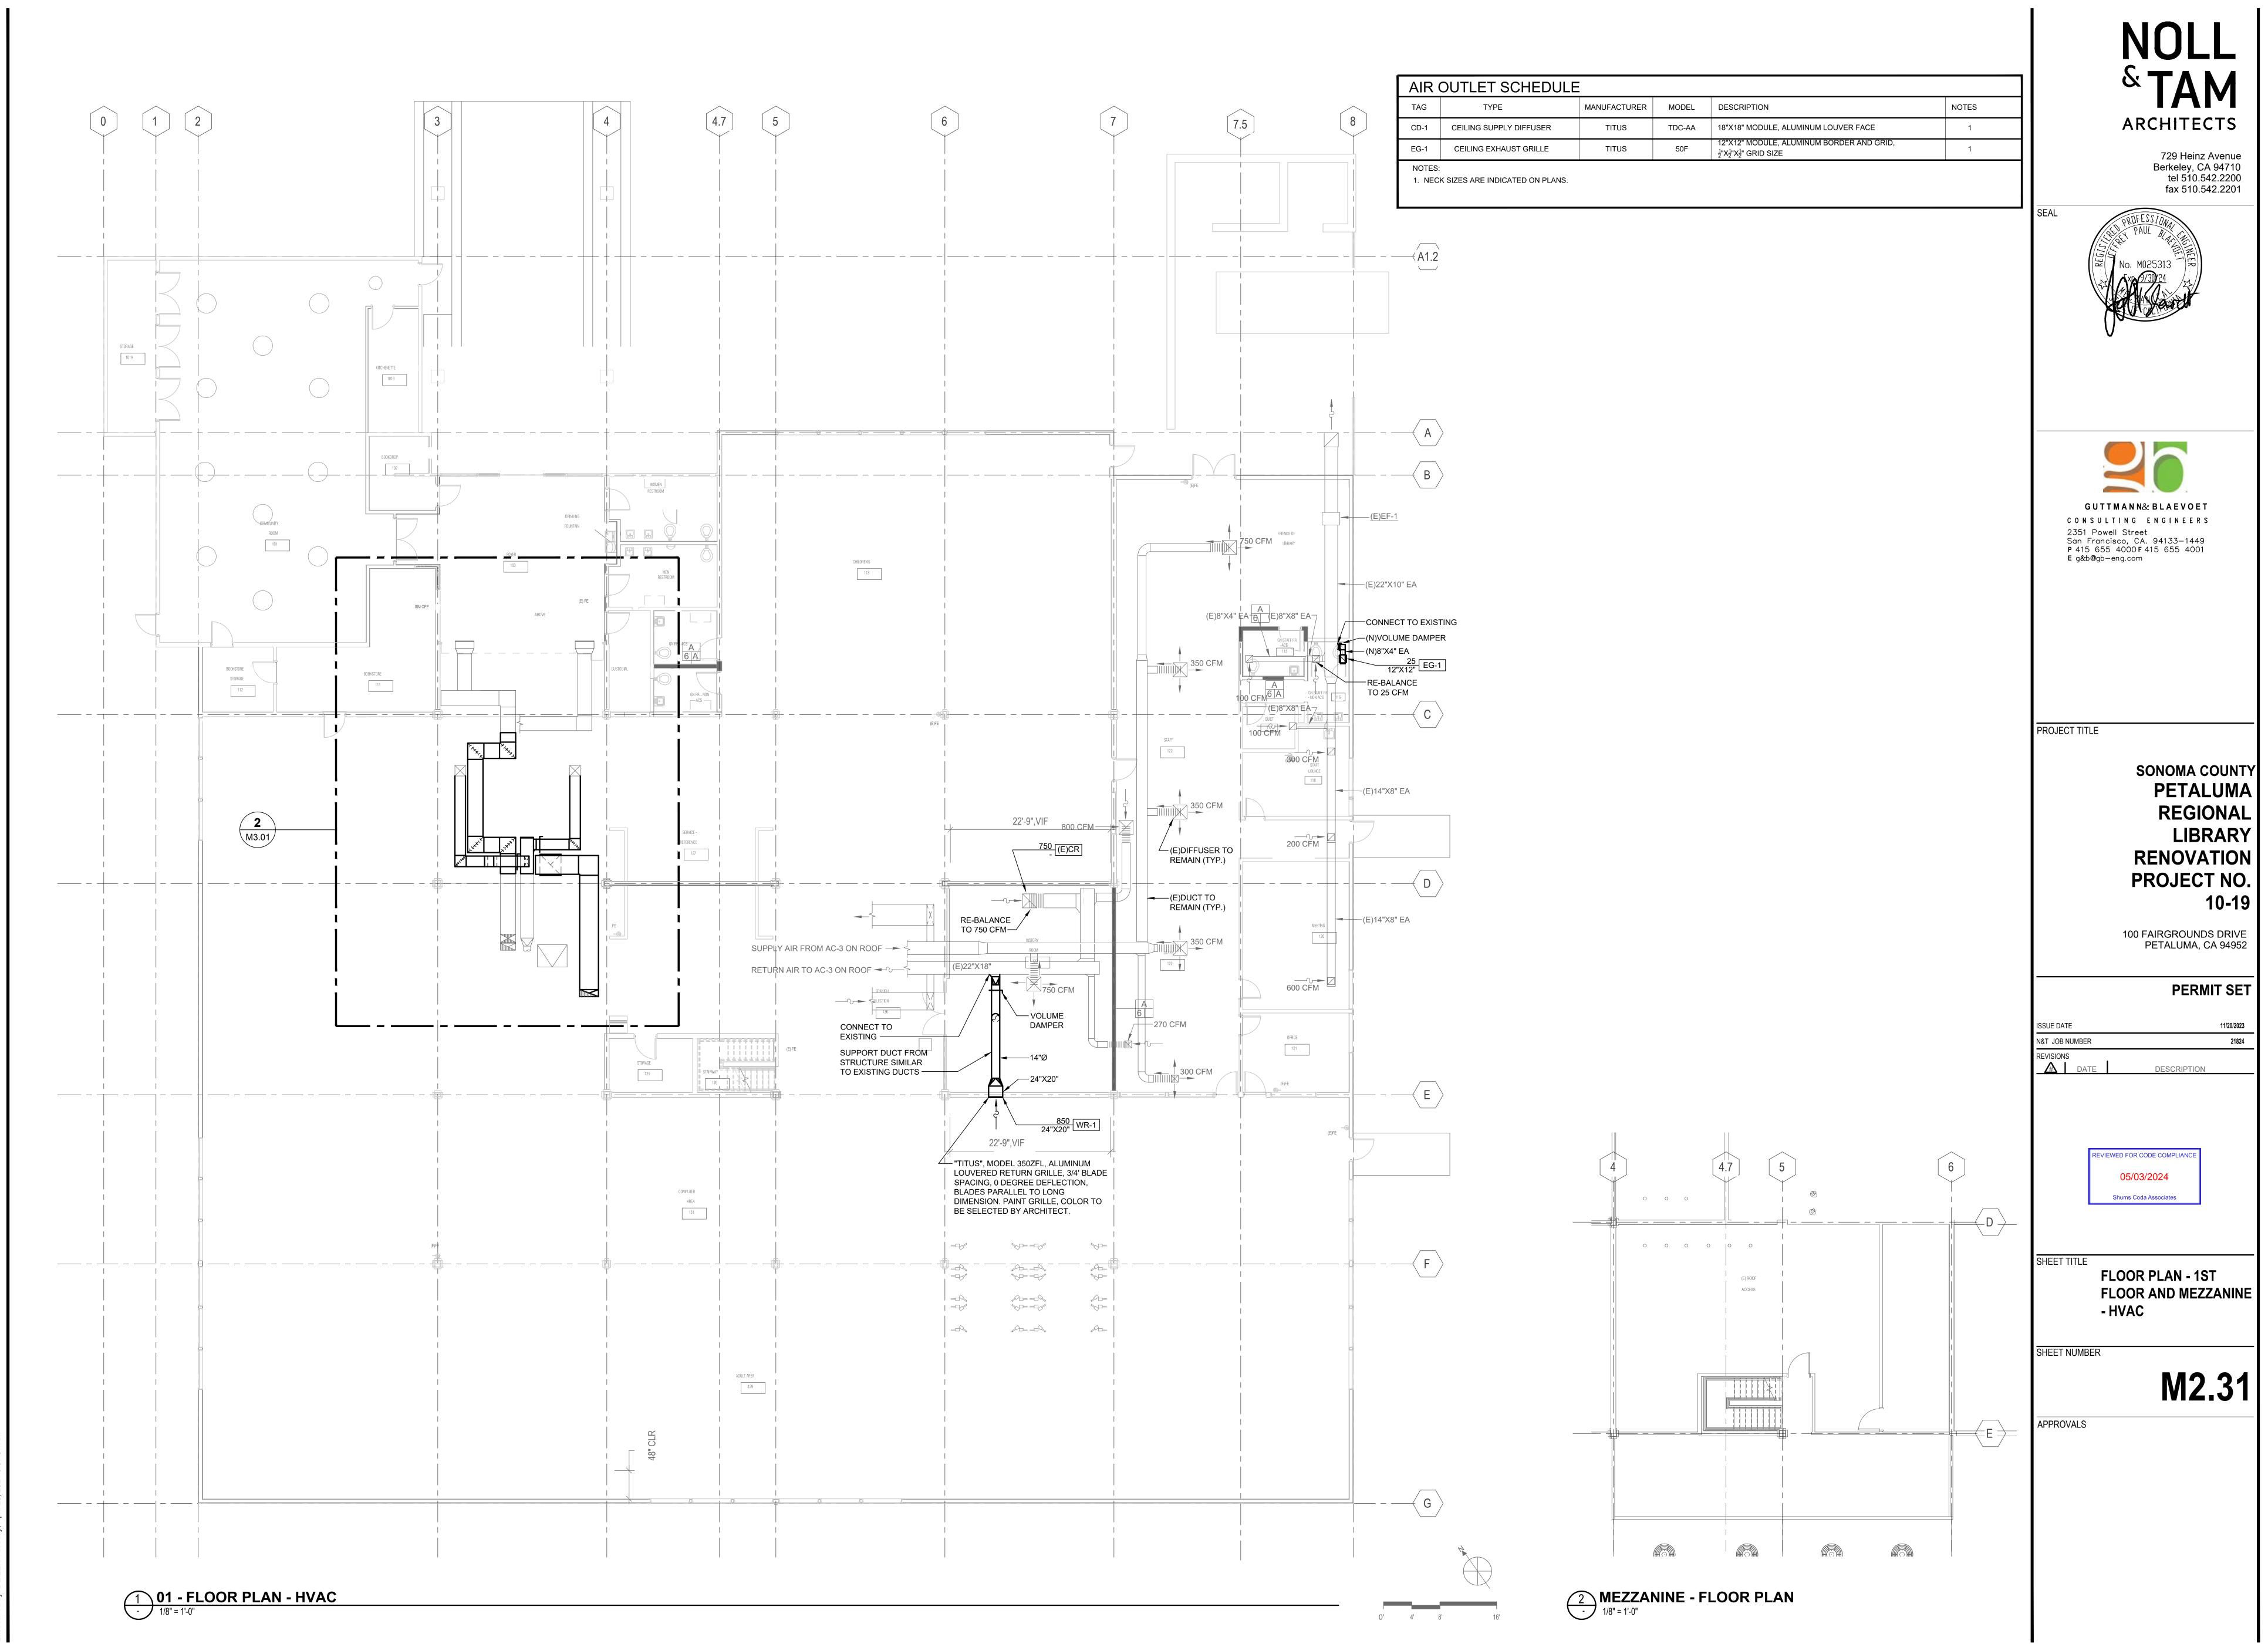
ARCHIVE MECHANICAL
PLAN FOR REFERENC
ONLY

SHEET NUMBER


SECTION SCALE 1/8 2 1500 M1.32

APPROVALS

ARCHIVE MECHANICAL DRAWING SHOWN FOR REFERENCE ONLY



FLOOR AND MEZZANINE

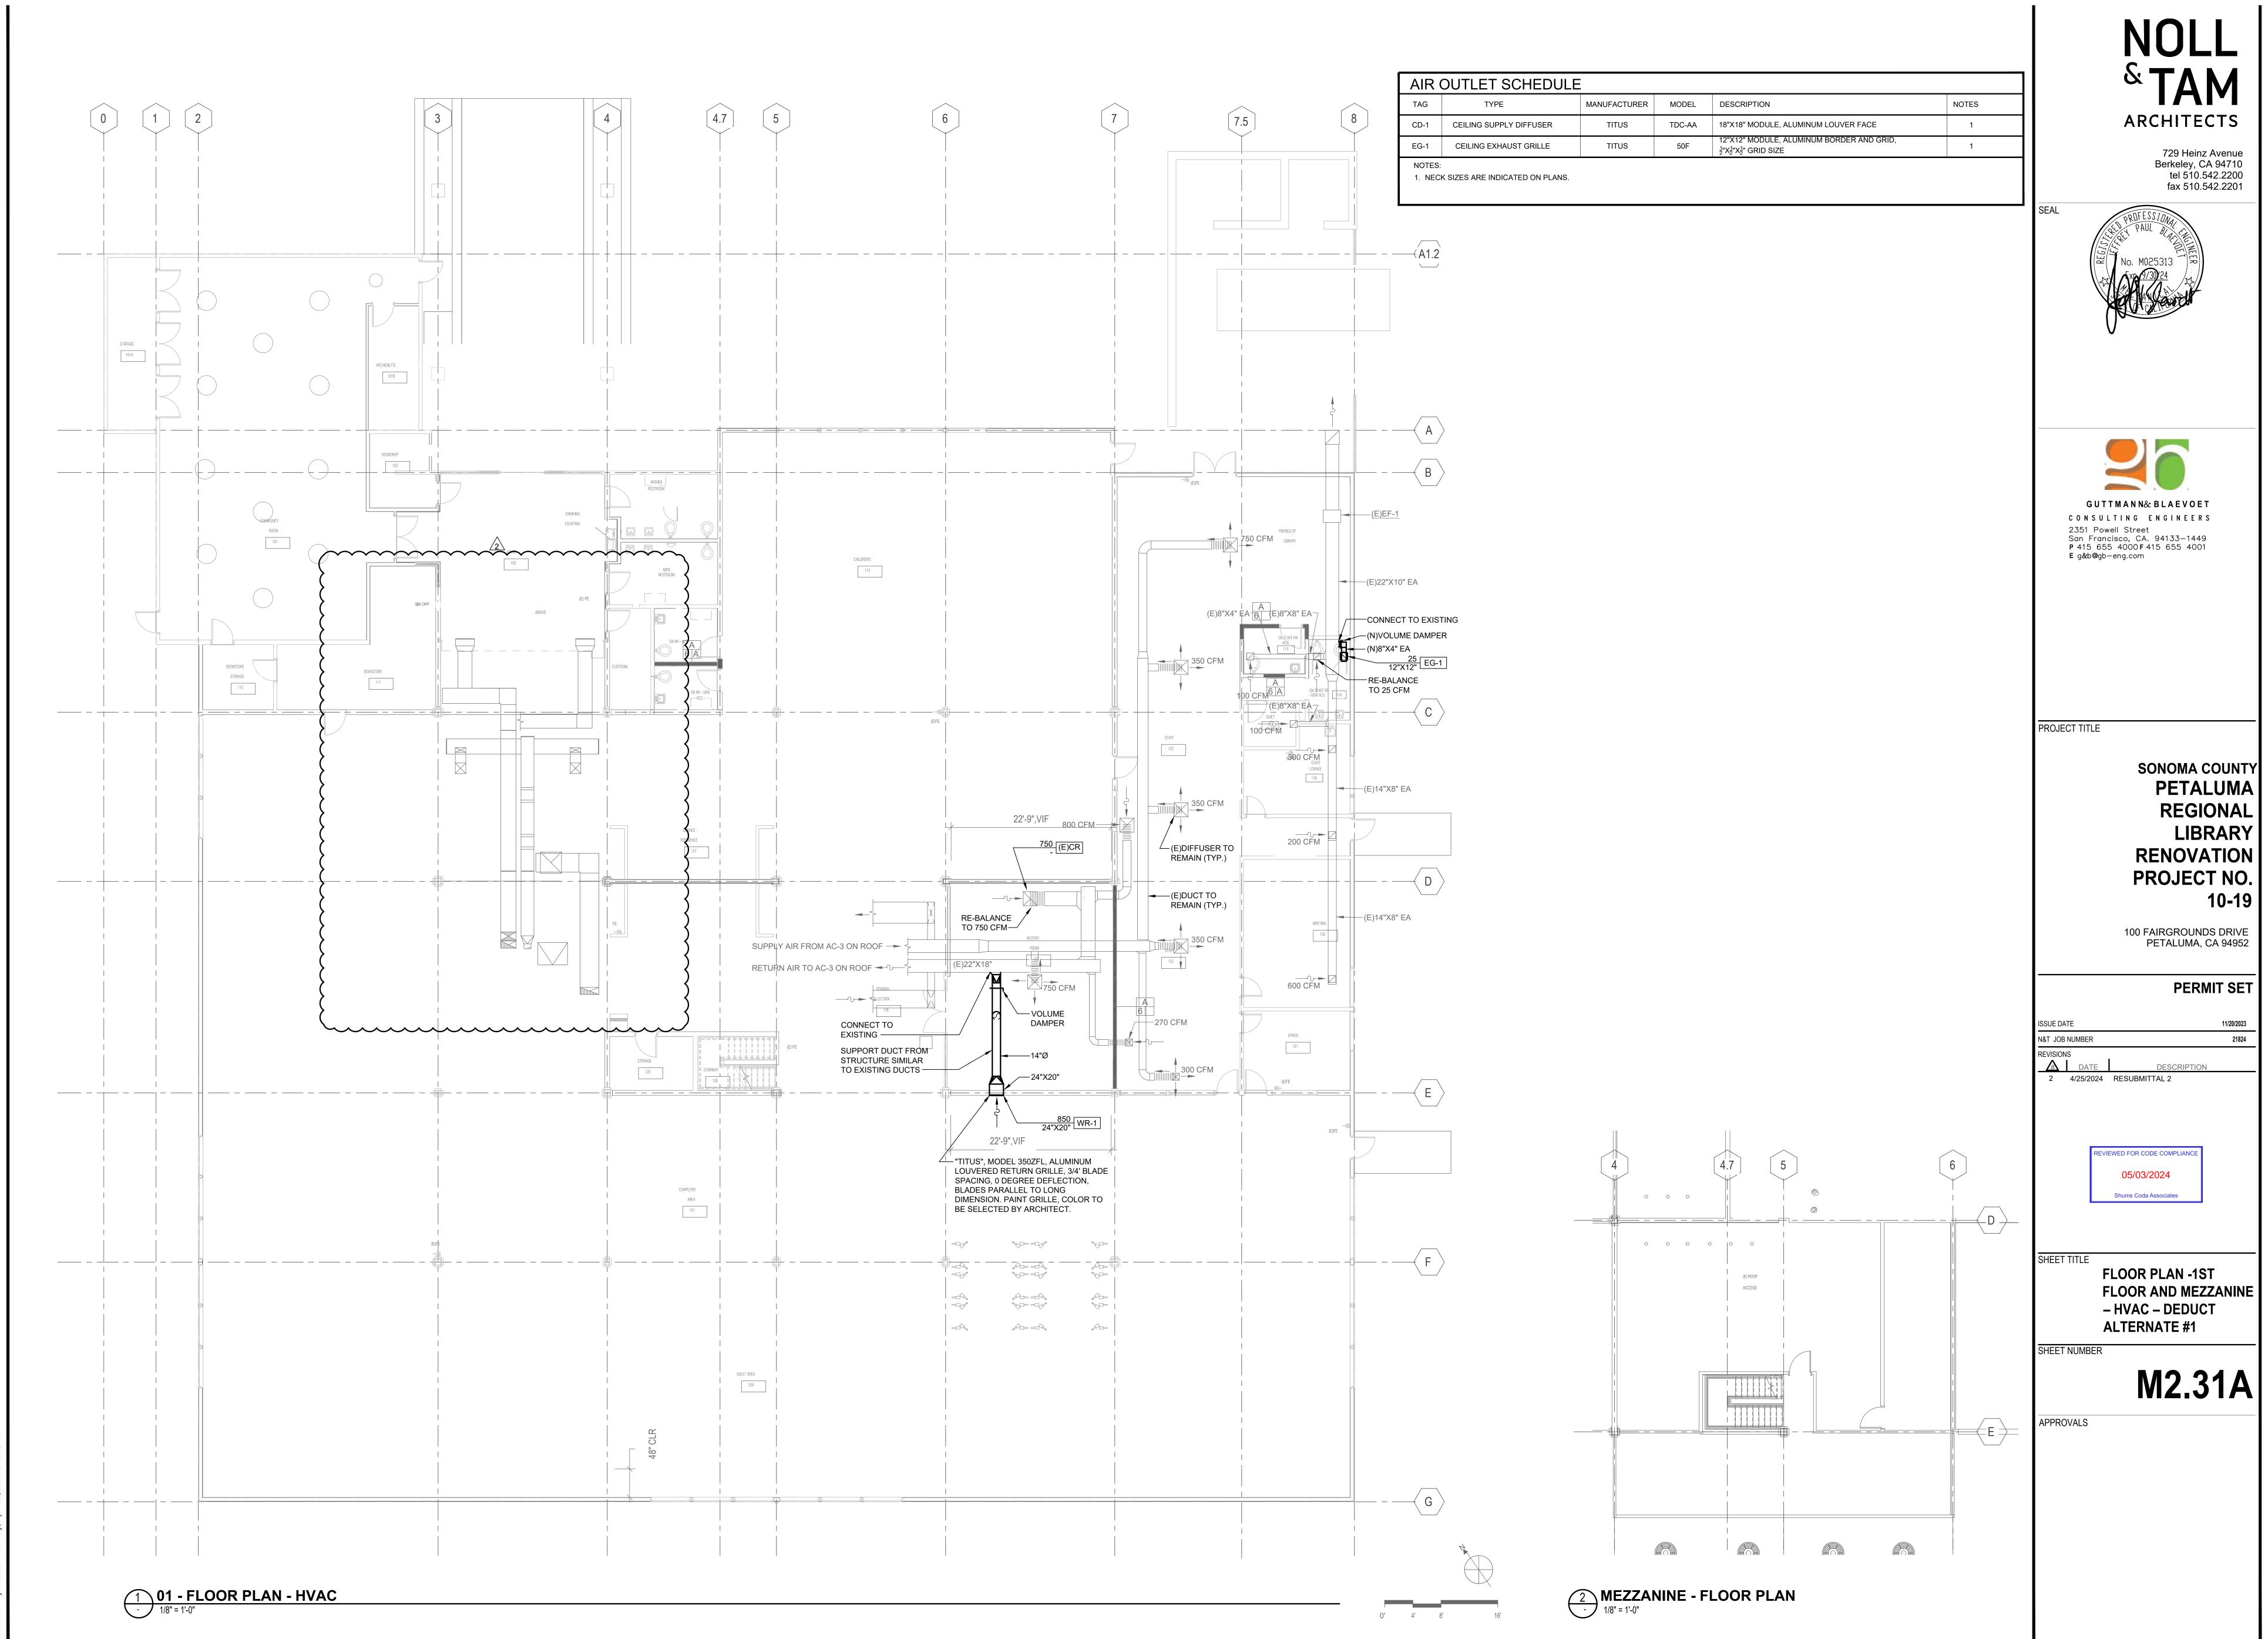

AIR BALANCE NOTES:

 BALANCE THE SUPPLY AND RETURN AIR FLOWS OF THE AFFECTED SUPPLY AND RETURN GRILLES IN THIS SCOPE OF WORK AND SET TO THE MEASURED PRE-BALANCE CFM'S.


GENERAL NOTES:

A. MOUNT NEW DUCTS A MININUM OF 12" ABOVE NEW LIGHT FIXTURES.

B. AFTER COMPLETION OF WORK, TESTS ON THE HVAC SYSTEMS, INCLUDING A DUCT LEAKAGE TEST, AND AN AIR BALANCE PERFORMANCE TEST SHALL BE PERFORMED IN ACCORDANCE WITH AN APPROVED METHOD PER CMC 314.1.

SHEET NOTES:

- 1 CONNECT NEW DUCT TO EXISTING.
- (2) CONNECT NEW DUCT TO EXISTING SUPPLY AIR DIFFUSER.
- 3 DUCT LATERAL AND LONGITUDINAL SEISMIC BRACING. SEE DETAILS 3 AND 4 ON SHEET M4.01 FOR ADDITIONAL INFORMATION.

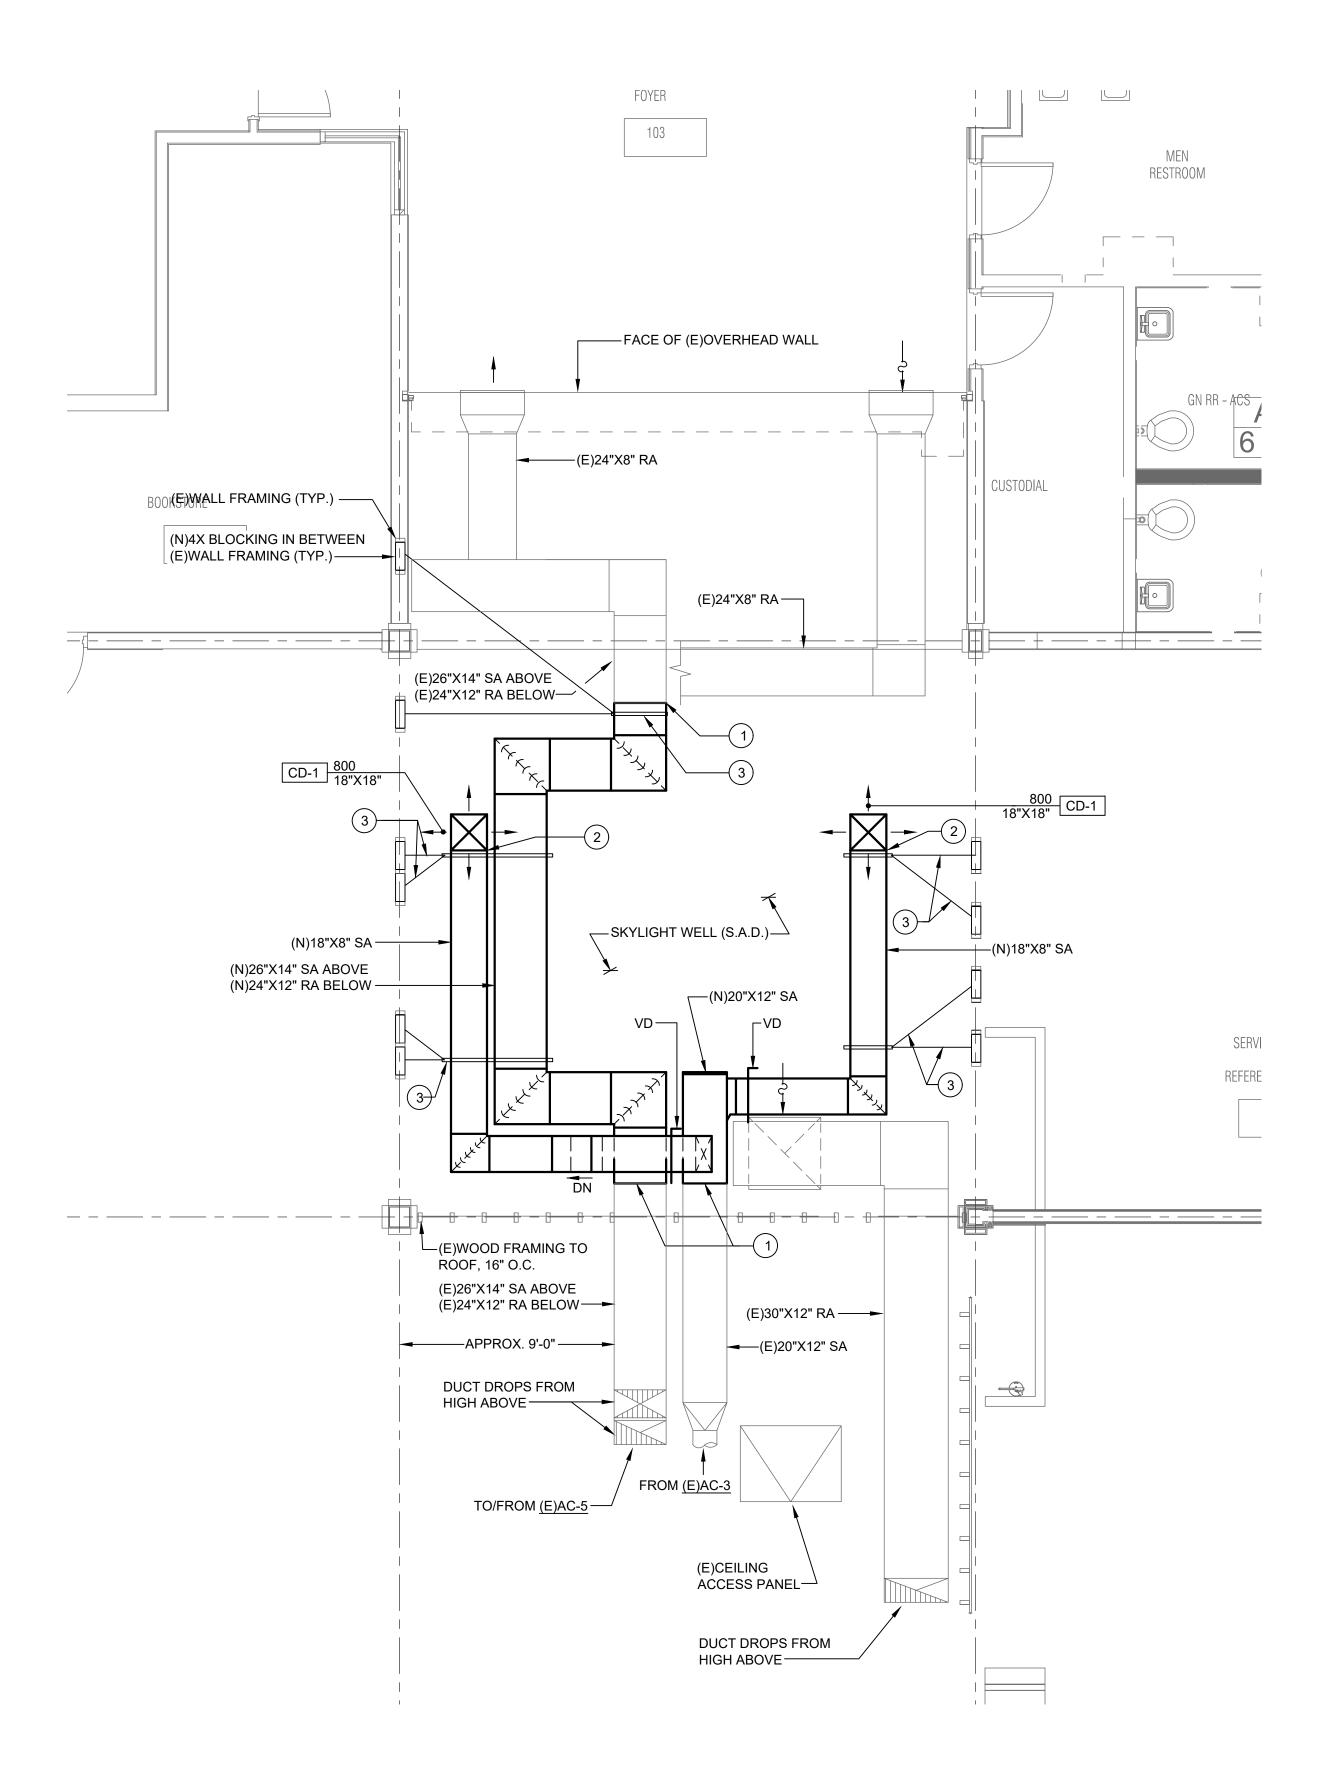

2 ENLARGED FLOOR PLAN - HVAC
1/4" = 1'-0"

AIR PRE-BALANCE NOTES:

1 CONTRACTOR SHALL PROVIDE AN AIR PRE-BALANCE REPORT FOR THE AC-3 AND AC-5 DIFFUSERS AND GRILLES IN THIS SCOPE OF WORK PRIOR TO ANY DEMOLITION AND SUBMIT TO THE ENGINEER OF RECORD.

DEMOLITION SHEET NOTES:


REMOVE AND DISCARD EXISTING 26"X14" SUPPLY AIR DUCT (ABOVE) AND EXISTING 24"X12" RETURN AIR DUCT (BELOW).

2 REMOVE AND DISCARD EXISTING 18"X8" SUPPLY DUCT.


3 REMOVE AND DISCARD EXISTING 18"X18" FACE SUPPLY AIR GRILLE.

4 REMOVE AND DISCARD EXISTING 26"X12" SUPPLY DUCT.


5 PREPARE EXISTING DUCTS FOR CONNECTION TO NEW.

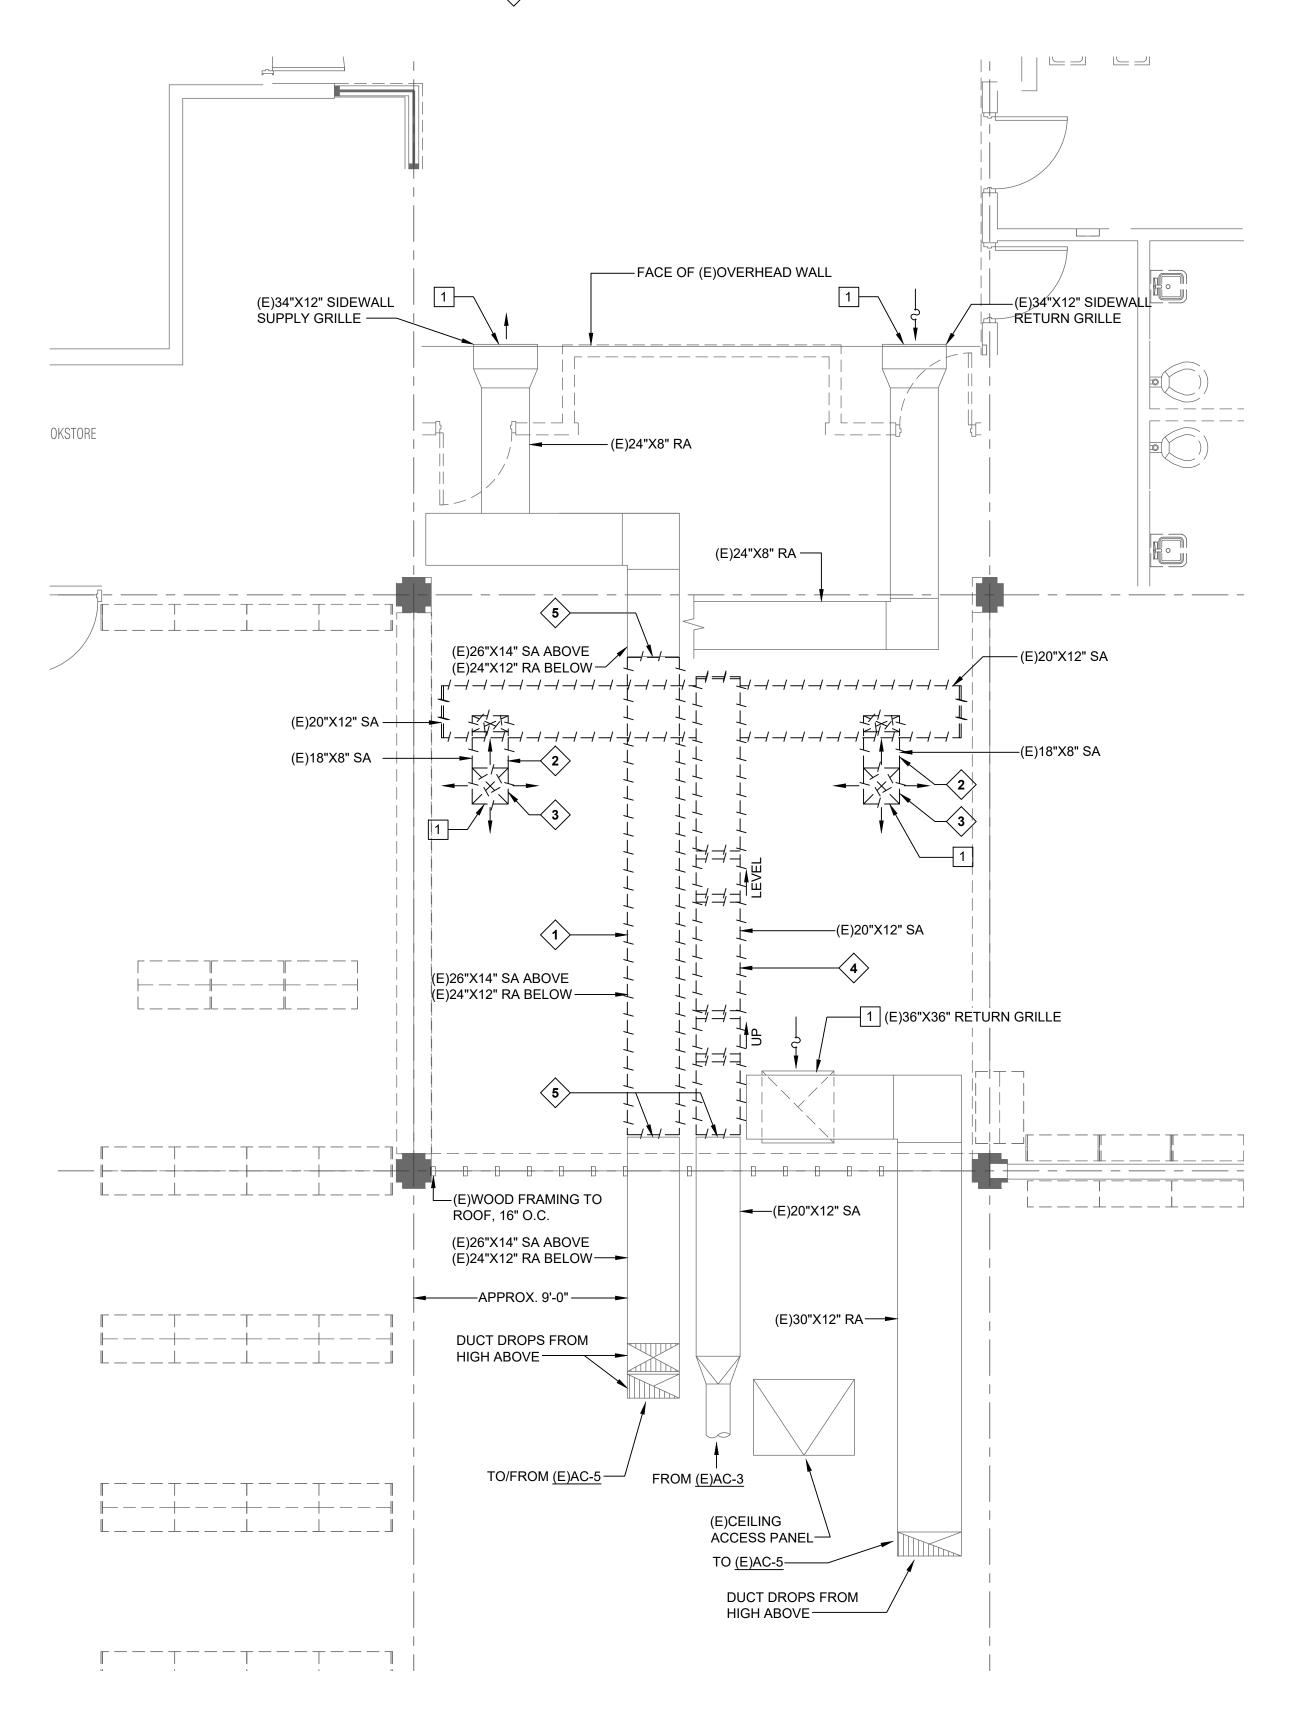

1 ENLARGED FLOOR PLAN - HVAC DEMOLITION
1/4" = 1'-0"

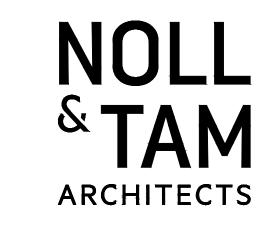

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N&T JOB NUMBER
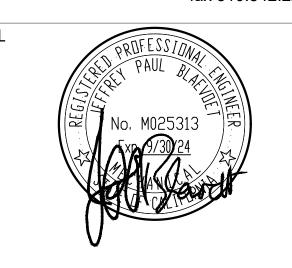
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05/03/2024

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SHEET TITL


ENLARGED PLANS -HVAC

SHEET NUMBER

M3.01

APPROVALS

0' 2' 4' 8'

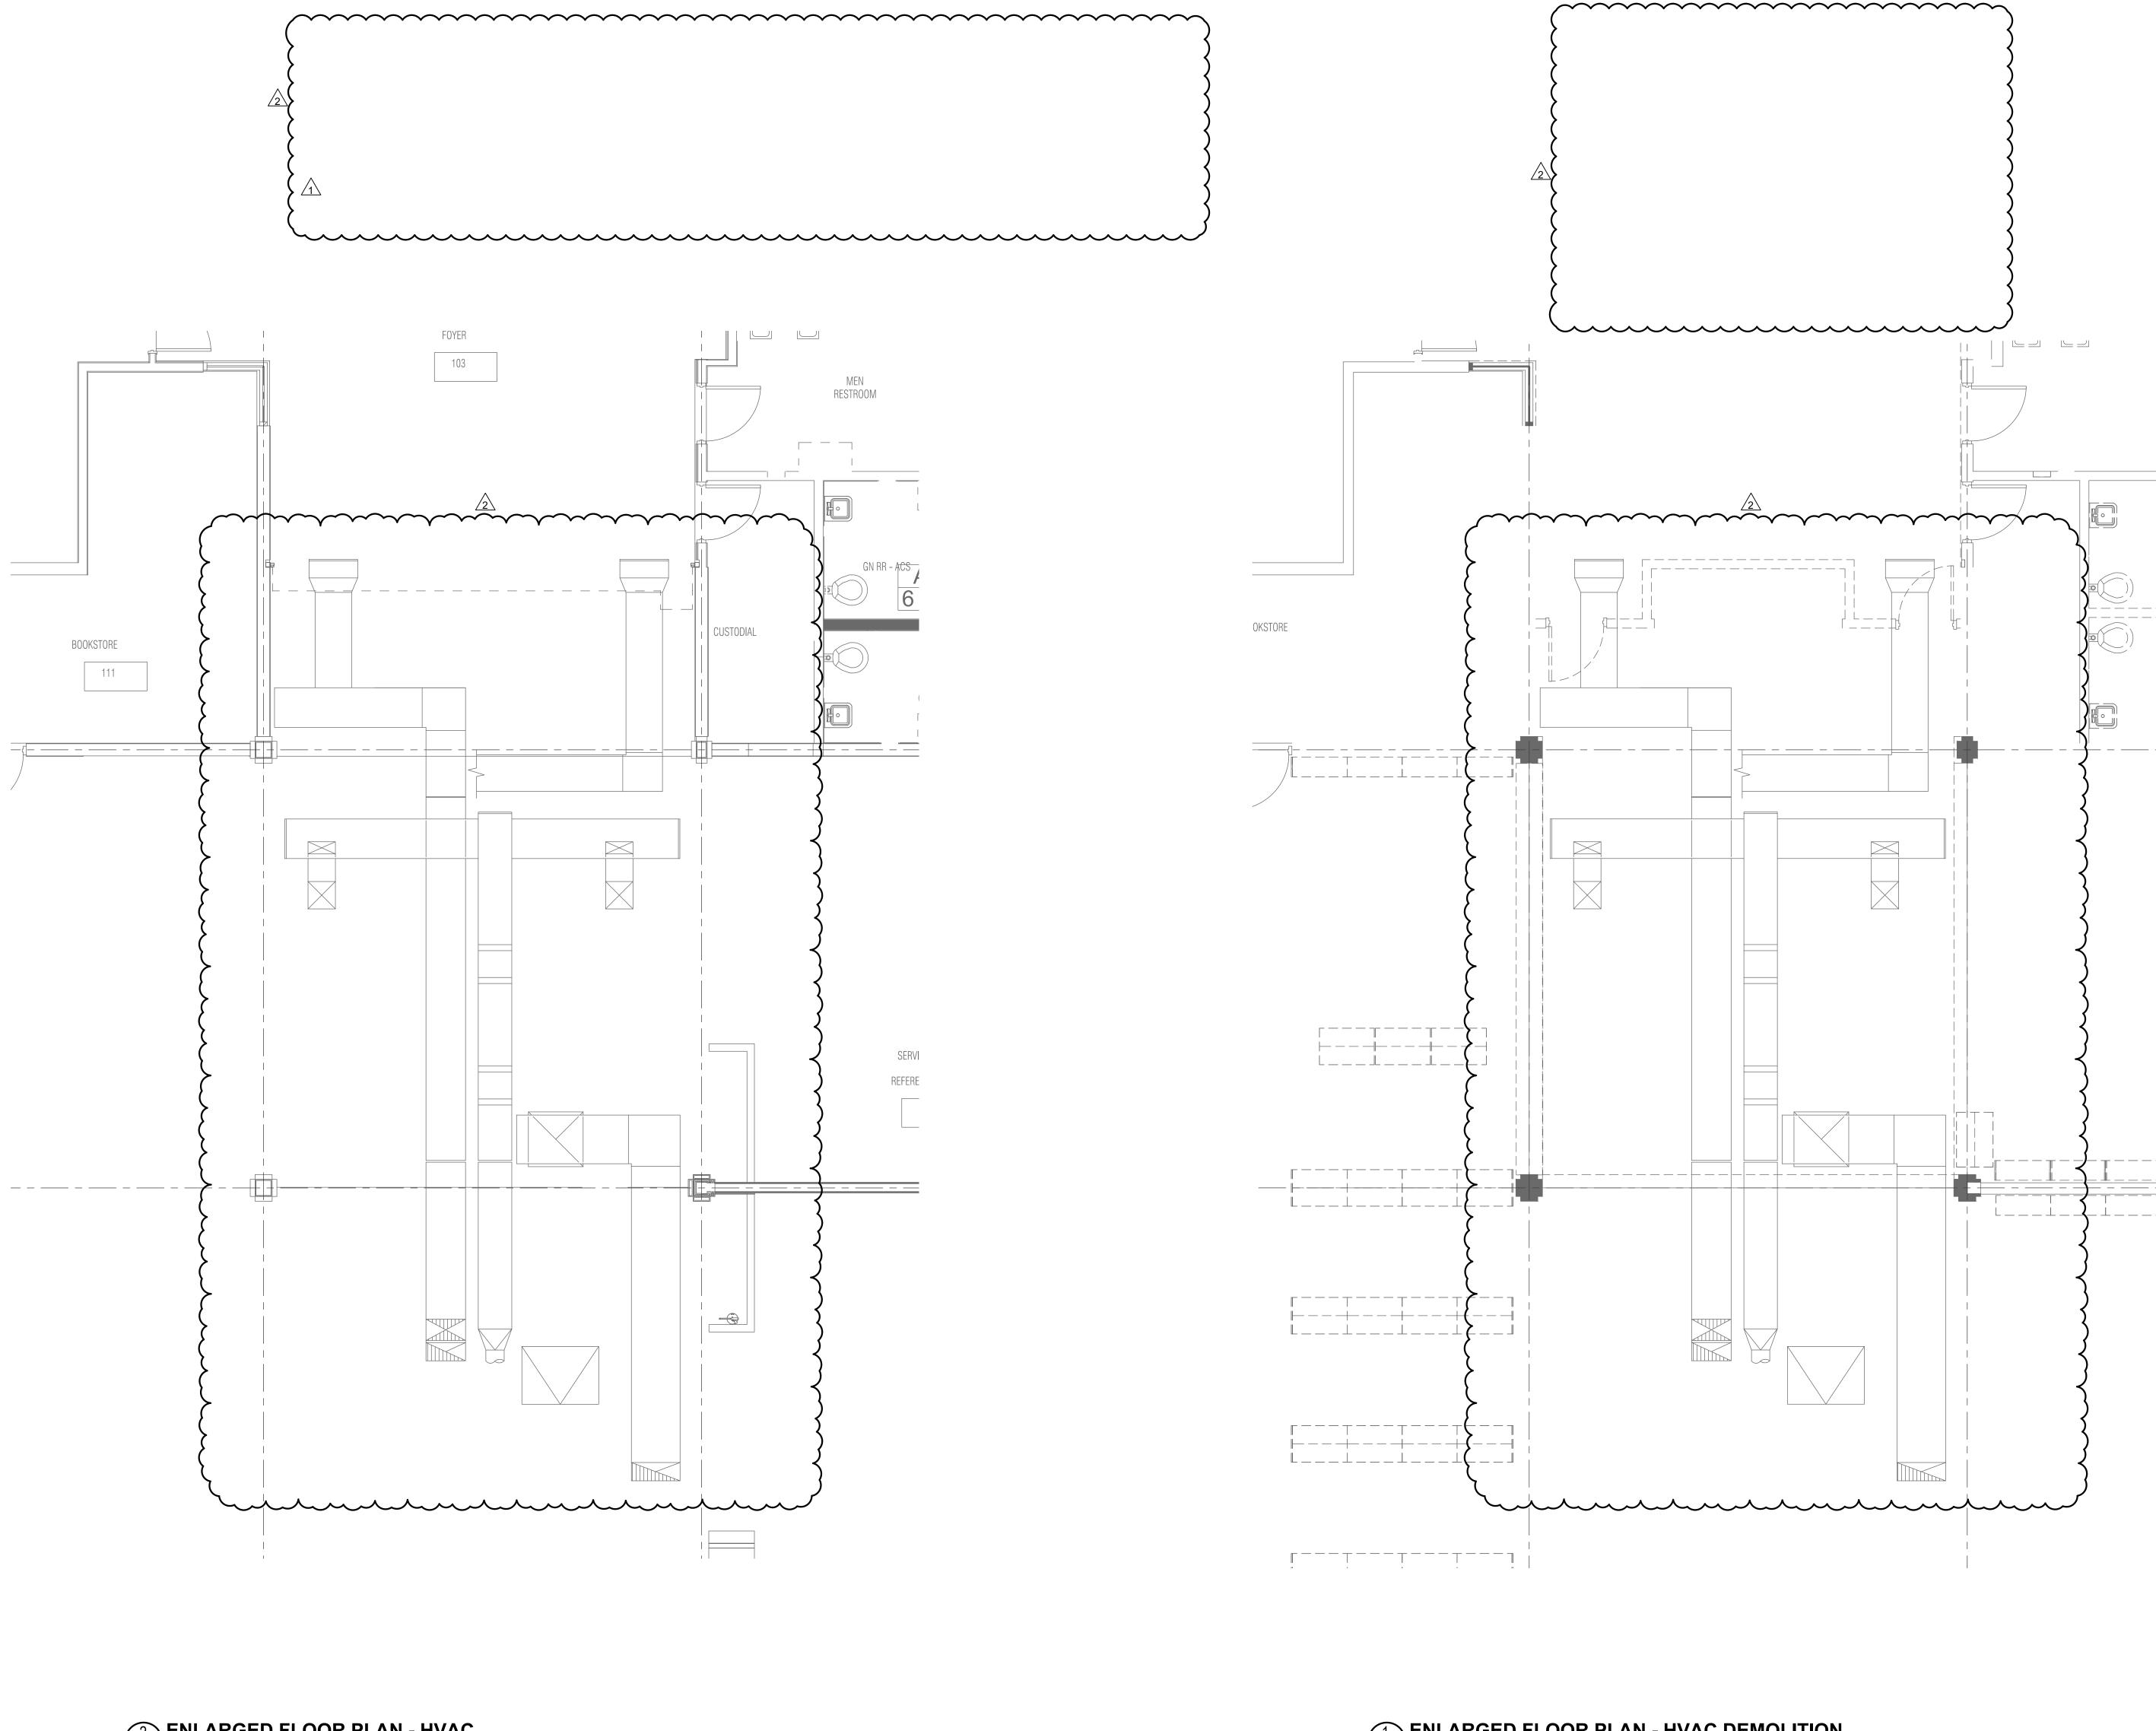

2 ENLARGED FLOOR PLAN - HVAC
1/4" = 1'-0"

1 ENLARGED FLOOR PLAN - HVAC DEMOLITION
1/4" = 1'-0"



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SONOMA COUNTY **PETALUMA REGIONAL LIBRARY RENOVATION** PROJECT NO.

100 FAIRGROUNDS DRIVE PETALUMA, CA 94952

PERMIT SET

DESCRIPTION 1 1/22/2024 RESUBMITTAL

2 4/25/2024 RESUBMITTAL 2

N&T JOB NUMBER


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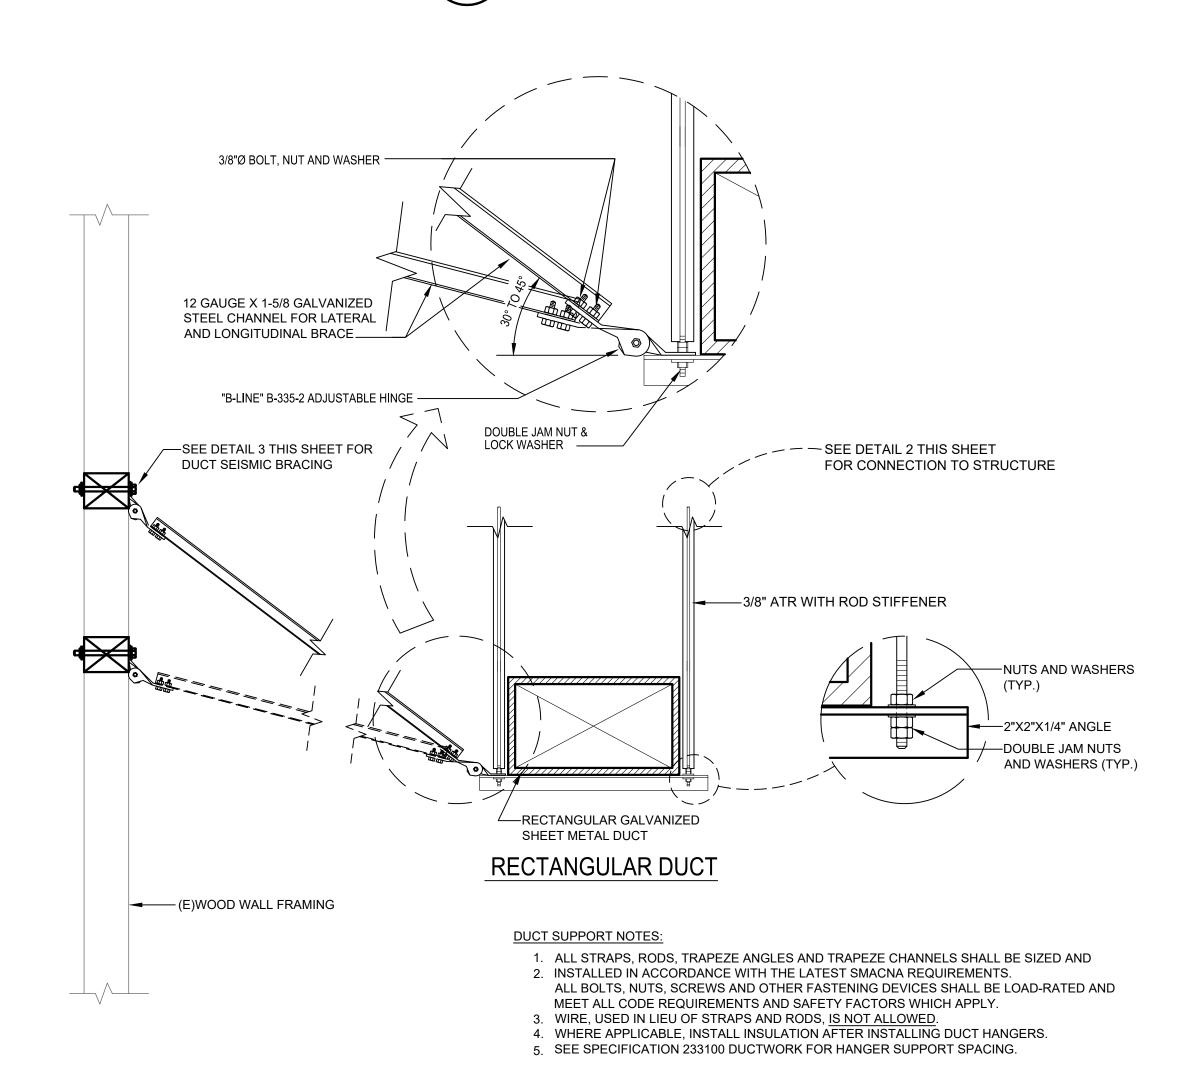
SHEET TITLE **ENLARGED PLANS –** HVAC – DEDUCT **ALTERNATE #1**

SHEET NUMBER


M3.01A






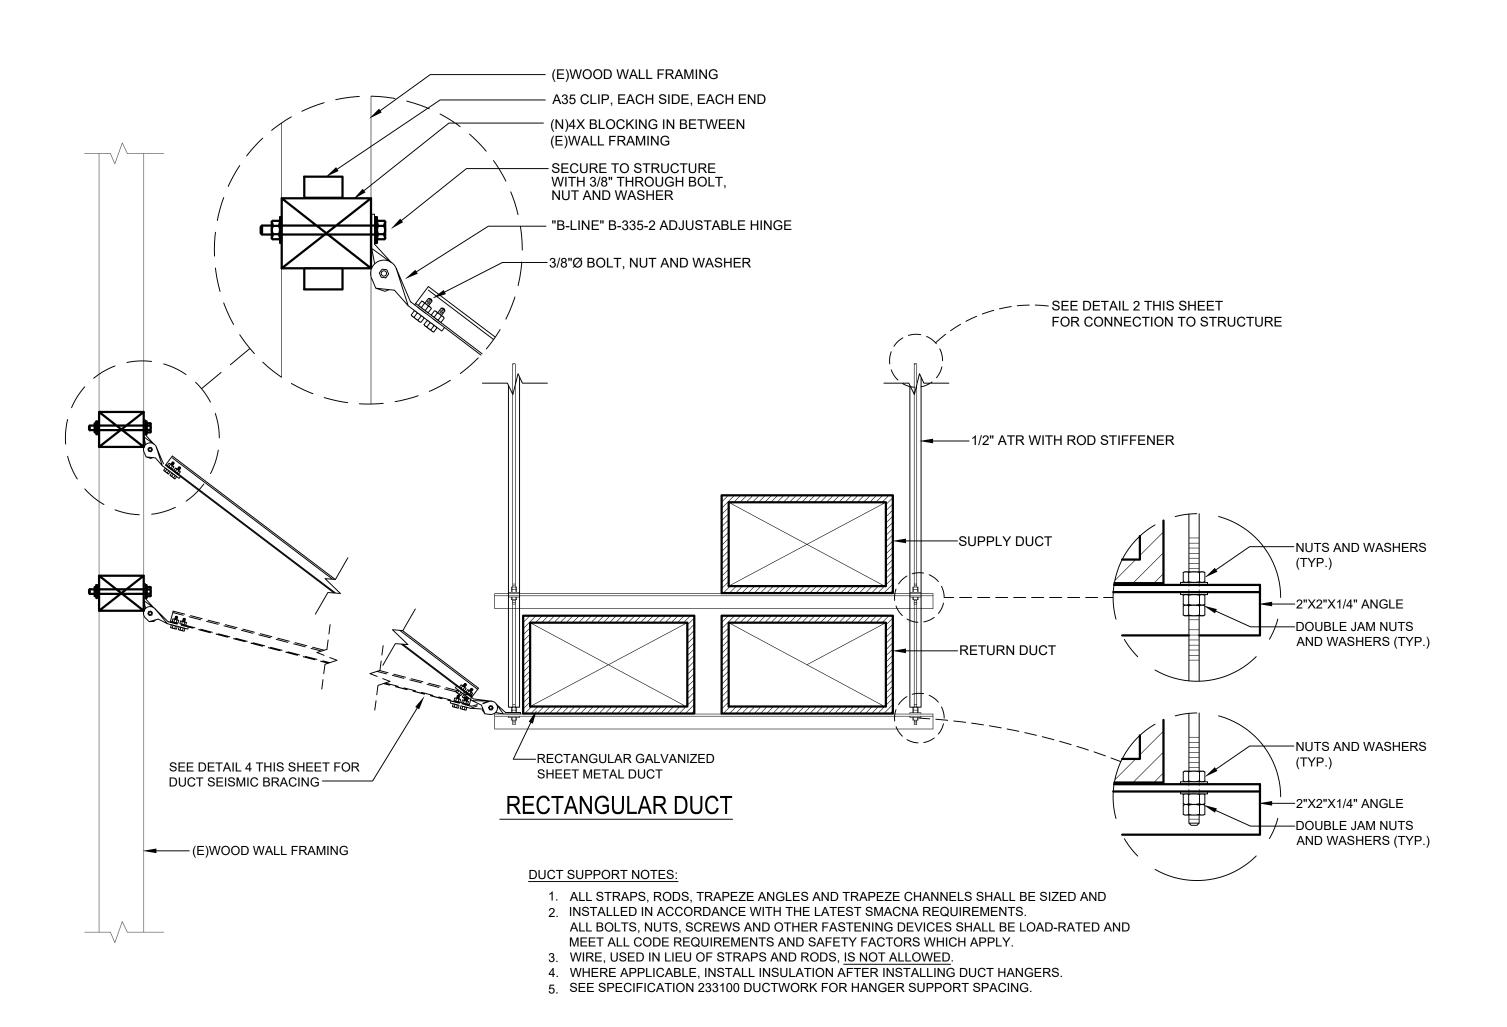



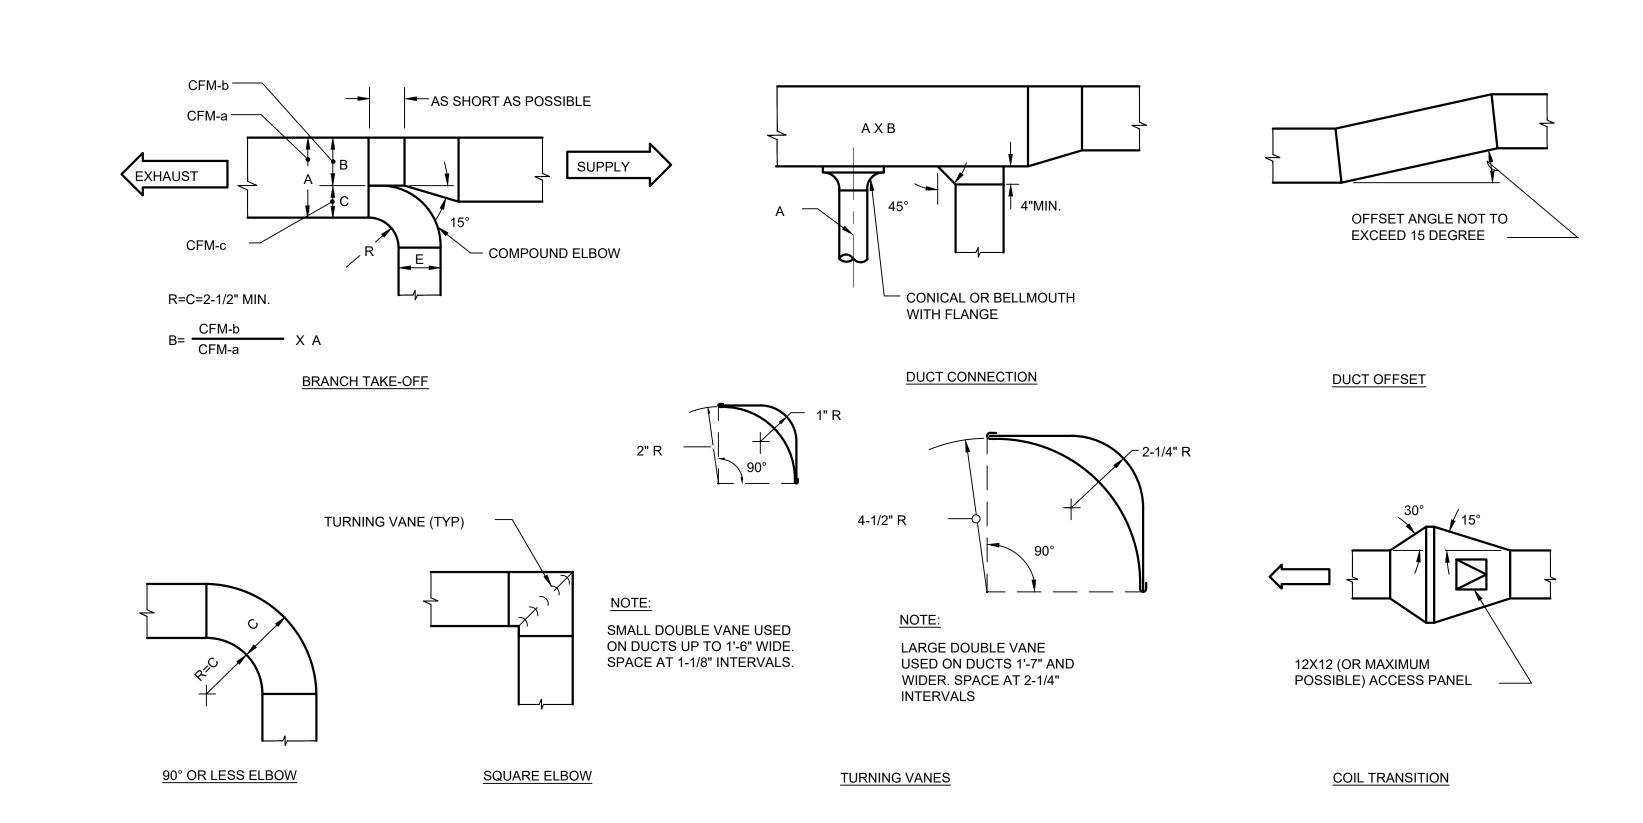



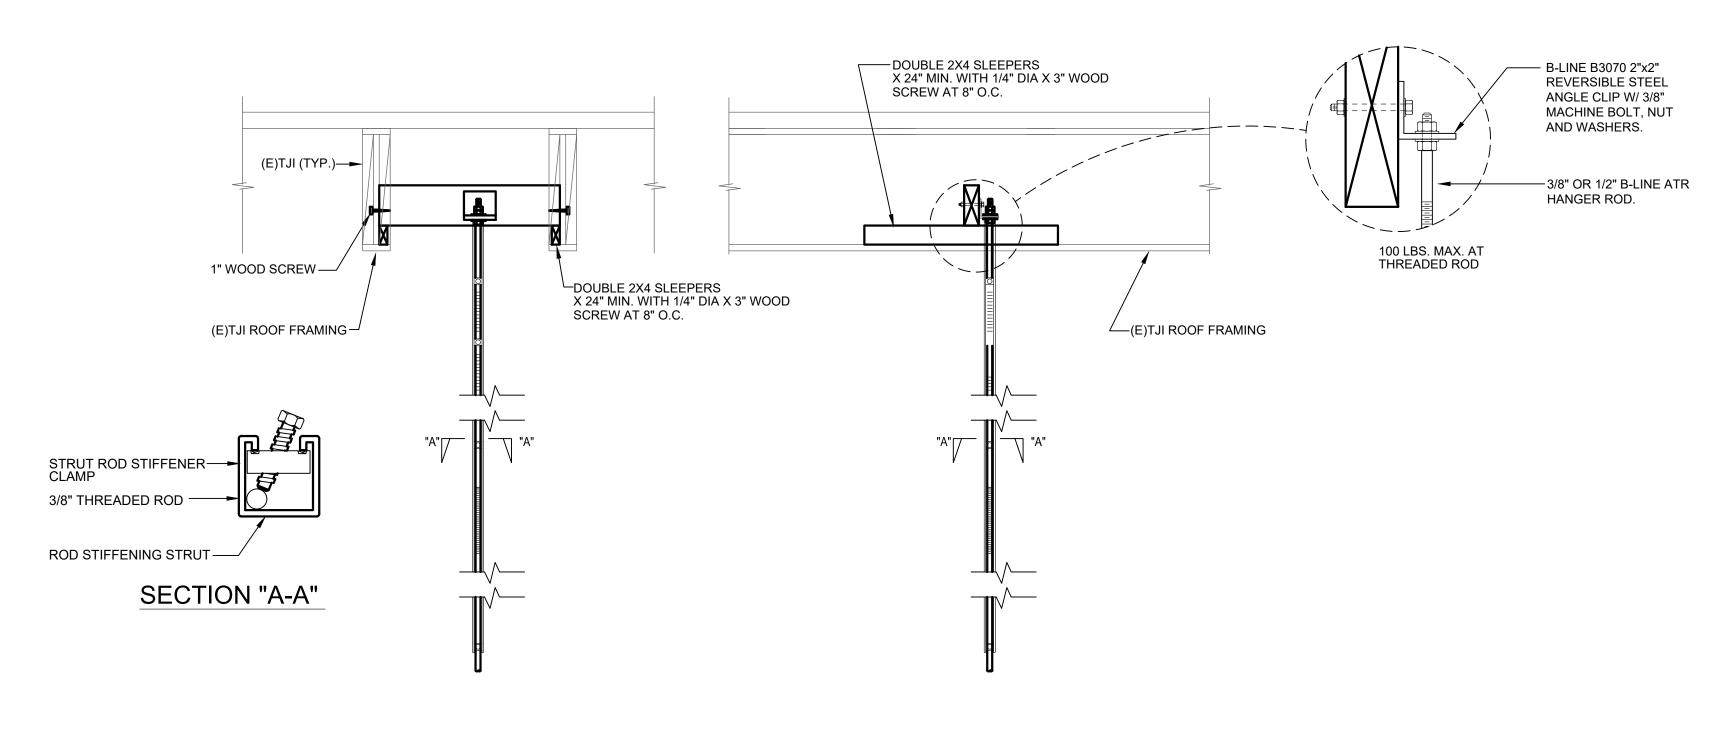


SUPPORT @ (E)TJI FRAMING (PARALLEL)

SUPPORT @ (E)TJI FRAMING (PERPENDICULAR)





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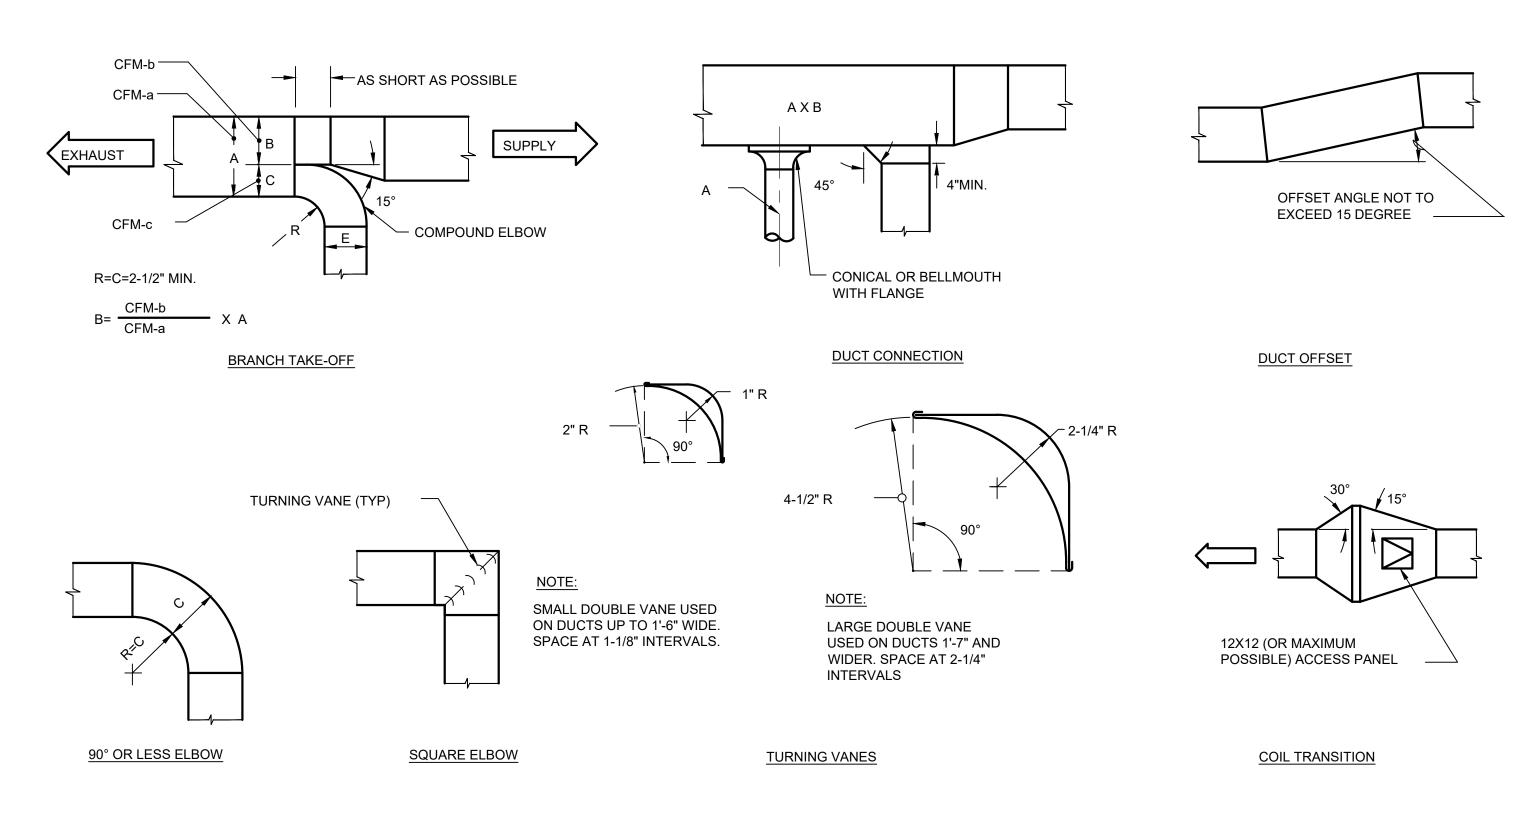
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SHEET TITLE

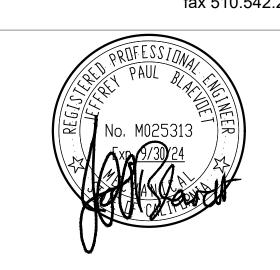
DETAILS

SHEET NUMBER

M4.01






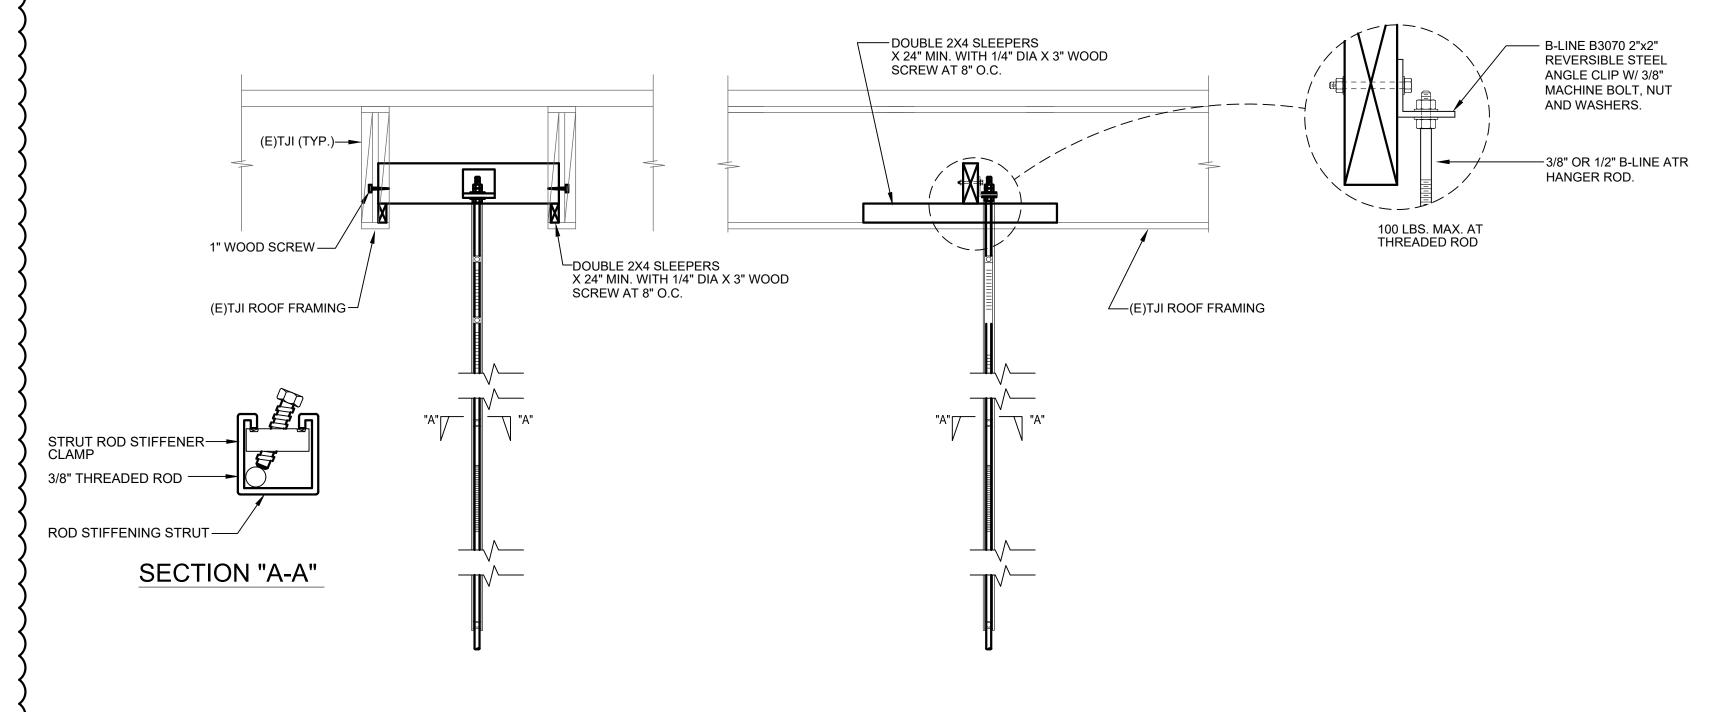


SUPPORT @ (E)TJI FRAMING (PARALLEL)

SUPPORT @ (E)TJI FRAMING (PERPENDICULAR)

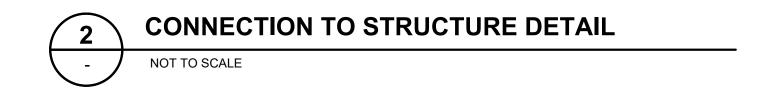



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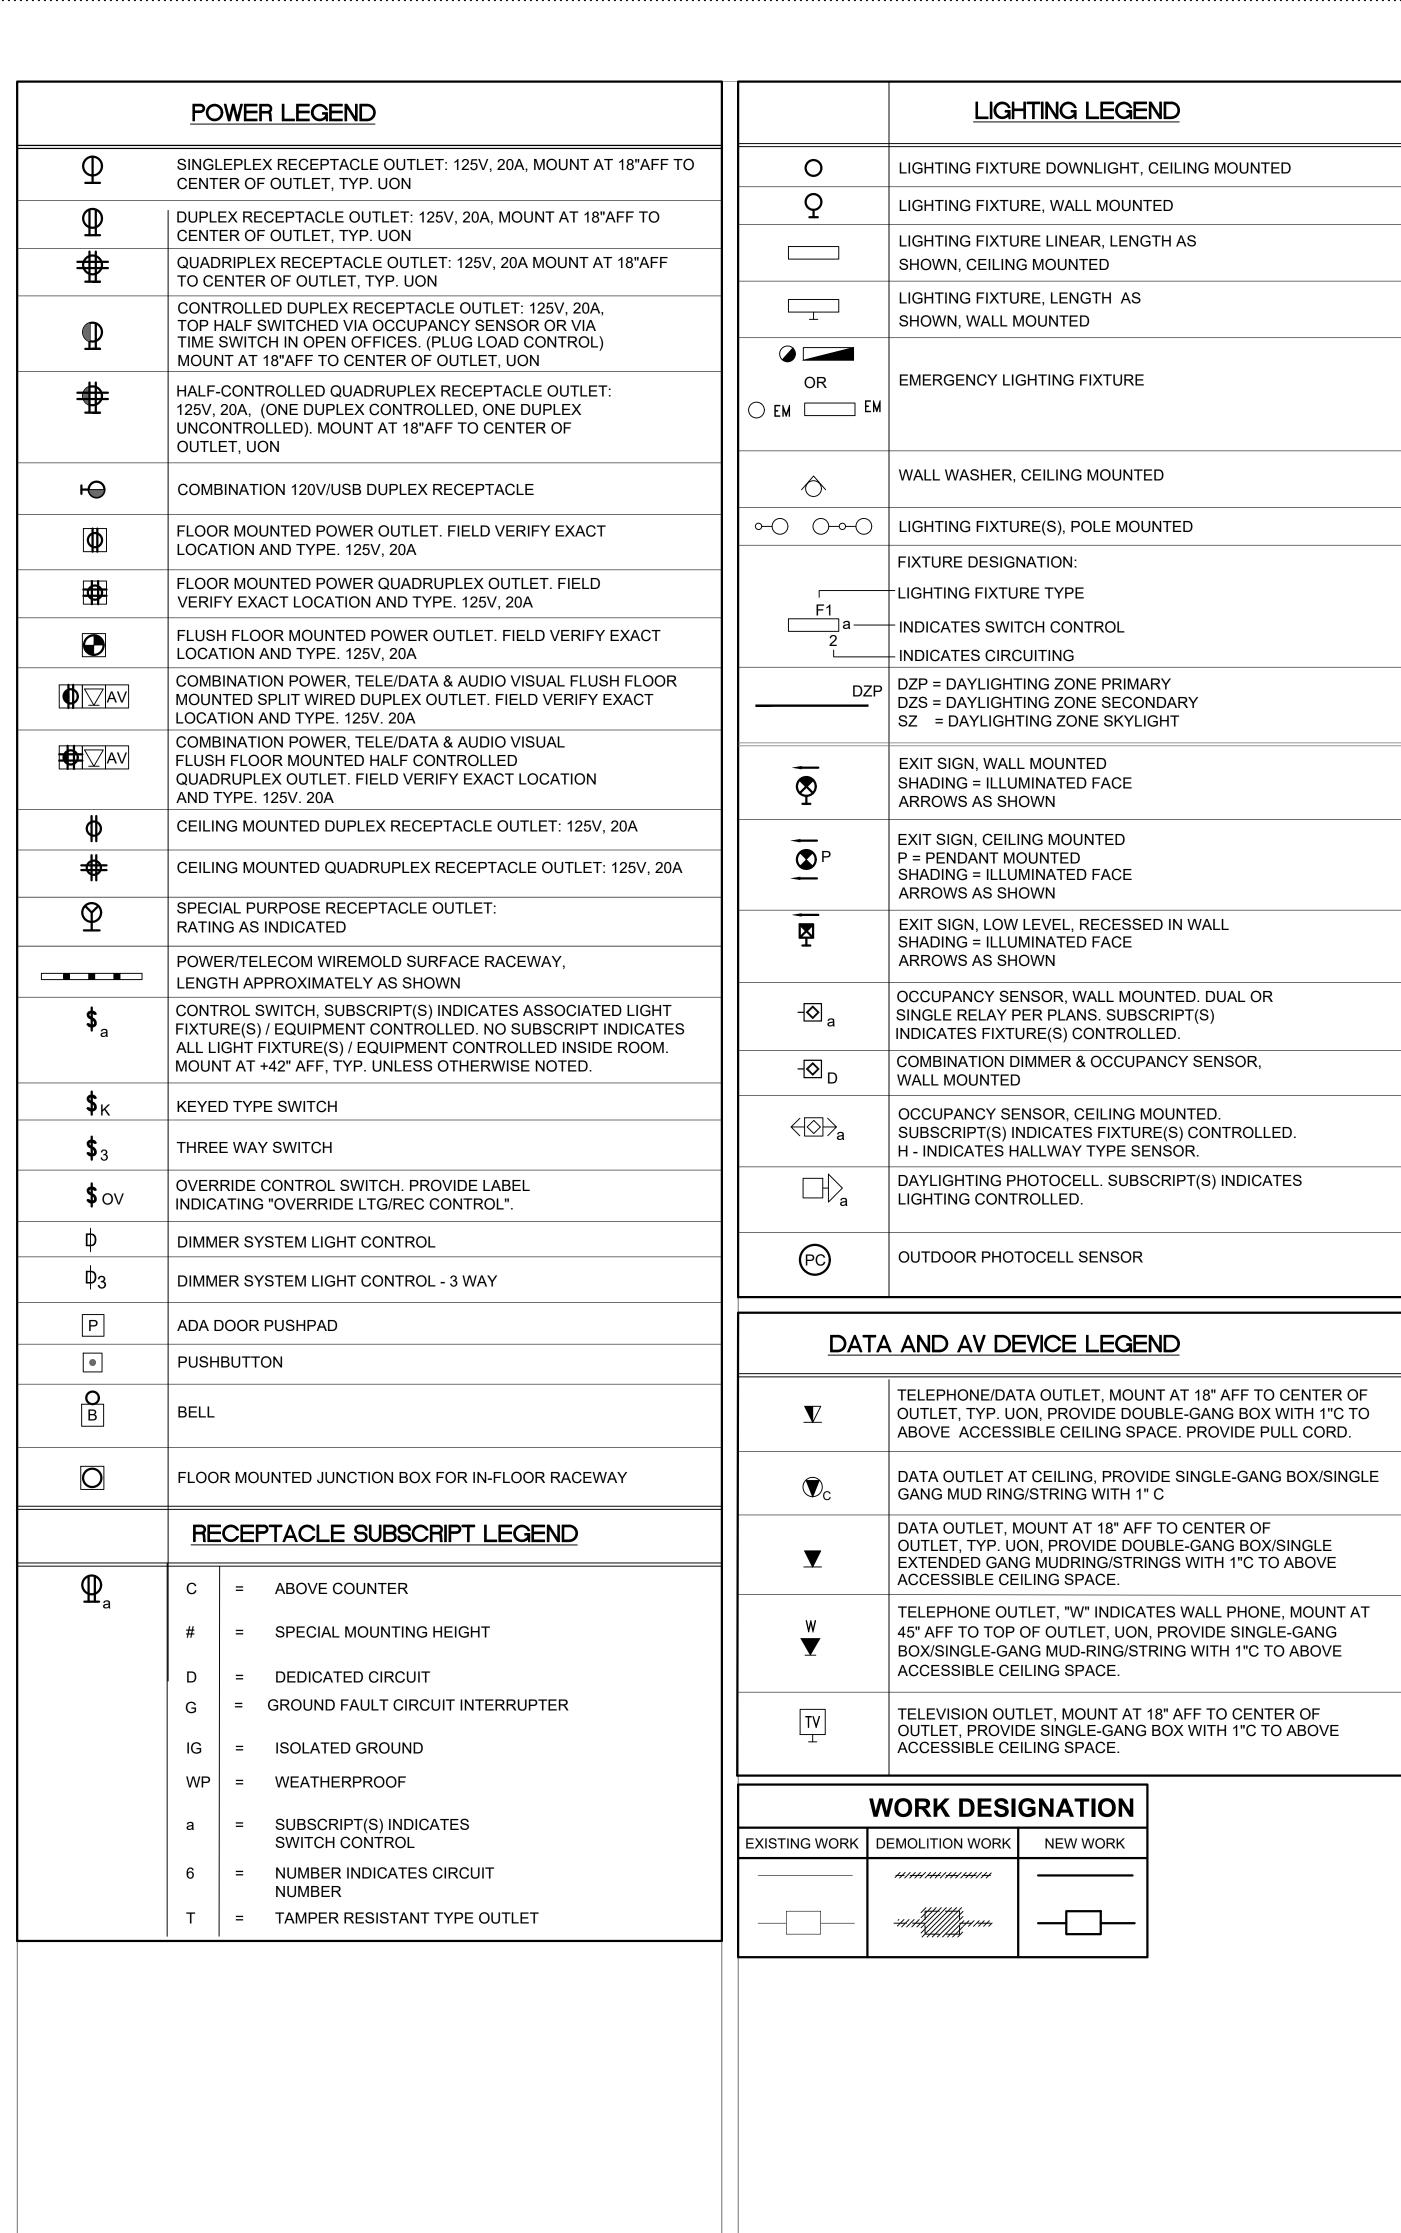
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DETAILS – DEDUCT ALTERNATE #1

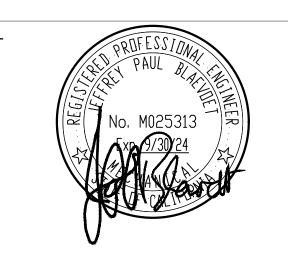SHEET NUMBER

M4.01A

APPROVALS



NOTE: MOUNT AT 18" AFF TO CENTER OF BOX. UON, REFER TO ARCHITECTURAL DRAWINGS FOR MOUNTING HEIGHT.

NOTE: NOT ALL SYMBOLS ARE USED

	POWER AND SIGNAL DEVICE LEGENI
	ELECTRICAL EQUIPMENT
	CONTROL PANEL SURFACE MOUNTED EXAMPLES: LCP, SECURITY, BMS
	CONTROL PANEL RECESSED MOUNTED
	EXAMPLES: LCP, SECURITY, BMS
	PANELBOARD SURFACE MOUNTED
	PANELBOARD RECESSED MOUNTED
	BUSWAY RISER WITH PLUG IN UNIT
	BUSWAY HORIZONTAL
СТВ	CABLE TAP BOX
Т	STEP DOWN TRANSFORMER
	HEAVY DUTY DISCONNECT SWITCH
	HEAVY DUTY DISCONNECT SWITCH WITH FUSE
\boxtimes	MOTOR STARTER
⊠ ¹	COMBINATION MOTOR STARTER/DISCONNECT SWITCH
V	VARIABLE FREQUENCY DRIVE
G	GENERATOR
CR	ACCESS CONTROL CARD READER BACK BOX
	MS = MOTORIZED SHADE CONTROLLER (FBO)
\$ xx	PS = PROJECTION SCREEN CONTROLLER (FBO)
.	
\$ T	THERMAL OVERLOAD/DISCONNECT SWITCH
EPO	RED PUSH BUTTON MUSHROOM TYPE WITH CLEAR LEXAN PROTECTIVE SHROUD COVER. EPO = EMERGENCY POWER OFF
M	MOTOR CONNECTION
j J	JUNCTION BOX, WALL / CEILING MOUNTED
	J-HOOK PATHWAY
$\overline{}$	GROUND BUS BAR
•	GROUND ROD
	CIRCUIT BREAKER
· ·	
	SWITCH AND FUSE
<	DRAWOUT TYPE CIRCUIT BREAKER
< <u></u> <	DRAWOUT TYPE SWITCH AND FUSE
СВ	CIRCUIT BREAKER IN ENCLOSURE
<u>{</u> M	CURRENT TRANSFORMER AND KWH METER
—GFP	GROUND FAULT PROTECTION RELAY
SPD	SURGE PROTECTIVE DEVICE
	NORMALLY OPEN CONTACT
	NORMALLY CLOSED CONTACT
\$\frac{1}{2} \tag{1}{2} \tag{1}{2} \tag{1}{2} \tag{1}{2} \tag{2} \tag{1}{2} \tag{2} \t	TRANSFORMER
No oE	AUTOMATIC TRANSFER SWITCH
	1

ABBREVIATIONS ABOVE COUNTER JUNCTION BOX AMPERES INTERRUPTING CAPACITY KILOVOLT KILOVOLT - AMPERE ANNUNCIATOR KILOWATT AMMFTFR A OR AMP AMPERE LIGHTING MAX MAXIMUM ARC FAULT CURRENT INTERUPT MOTOR CONTROL CENTER MOTOR CIRCUIT PROTECTOR ARCHITECTURAL MECH MECHANICAL AUTOMATIC TRANSFER SWITCH MTD MOUNTED MOUNTING AUTOMATIC AUXILIARY NEUTRAL AUDIO VISUAL NORMALLY CLOSED BUILDING NOT IN CONTRACT CLOCK OR CONDUIT NUMBER CABINET NORMALLY OPEN CATALOG NAMEPLATE CIRCUIT BREAKER NOT TO SCALE CLOSED CIRCUIT TELEVISION +6" OVERCOUNTER OR BACKSPLASH CURRENT LIMITING FUSE OUTSIDE DIAMETER CLG CEILING OVERLOAD POLE CKT CIRCUIT PUBLIC ADDRESS COMBINATION CONCRETE PULL BOX or PUSHBUTTON POWER FACTOR CONNECTION CONT CONTACTOR PHASE CONTR CONTRACTOR PILOT LIGHT CURRENT TRANSFORMER PANEL DECIBEL PAIR DIRECT CURRENT PRIMARY DETAIL POLYVINYL CHLORIDE RECESSED or RECEPTACLE DIAMETER DIAGRAM REFERENCE DIMENSION REGULATOR DISCONNECT REQUIRED DISTRIBUTION REVISION DIVISION ROOM REMOVE AND REINSTALL SCHED SCHEDULE DOUBLE POLE DOUBLE THROW SMOKE DETECTOR DOUBLE POLE SINGLE THROW SECONDARY or SECURITY SOLID NEUTRAL SOLENOID DAYLIGHTING ZONE PRIMARY SOL SPARE SPACE SINGLE POLE DOUBLE THROW ELECTRICAL CONTRACTOR SPDT ELECTRICAL SPST SINGLE POLE SINGLE THROW ELEVATION SPEC SPECIFICATION SUPV SUPERVISORY EMERGENCY ENCLOSURE SQ.FT. SQUARE FOOT EQUIPMENT STA STATION ELECTRIC WATER COOLER STANDARD ELECTRIC WATER HEATER SUSP SUSPENDED **EXISTING** SWITCH EXPOSED SWBD SWITCHBOARD FIRE ALARM SWGR SWITCHGEAR FOOTCANDLE SYNCHRONIZATION SYNC FIXTURE SYST SYSTEM FIGURE DAYLIGHTING ZONE SKYLIGHT FLOOR T or TEL TELEPHONE FULL LOAD AMPERE TEMPERATURE FLEXIBLE THERMAL OVERLOAD FLEX FLUOR FLUORESCENT TPS TWISTED PAIR SHIELDED TELEPHONE TERMINAL CABINET FUT FUTURE TELEVISION GENERATOR (TYP.) TYPICAL UNIT HEATER GROUND FAULT UNIT VENTILATOR CIRCUIT INTERRUPTER VOLT HEIGHT VOLT AMPERE HIGH INTENSITY DISCHARGE HORIZ HORIZONTAL VERT VERTICAL HORSEPOWER VESTIBULE HEATER VOLTMETER HEATING, VENTILATION VERMIN RESISTANT AND AIR CONDITIONING VOLUME HIGH VOLTAGE WATT HERTZ WEATHER PROOF XP EXPLOSION PROOF IMPEDANCE INCH OR INCHES XFMR TRANSFORMER

PROJECT SCOPE

- DEMO EXISTING LIGHTING AS REQUIRED FOR INSTALLATION OF NEW SKYLIGHTS AND
- DEMO EXISTING POWER AS REQUIRED FOR NEW FURNITURE LAYOUT.
- PROVIDE NEW CIRCUITING, AS REQUIRED, FOR LIGHTING AND POWER TO NEW FURNITURE. EXISTING IN-FLOOR RACEWAY SHALL BE USED WHERE IDENTIFIED.

NG LIST
E - POWER
E - LIGHTING
OWER
SHTING
T ALTERNATE #1
1 CALCULATIONS
JLES

GENERAL NOTES

- A. DRAWINGS ARE DIAGRAMMATIC AND INDICATE GENERAL ARRANGEMENT OF SYSTEMS AND WORK INCLUDED. FOLLOW DRAWINGS IN LAYING OUT WORK AND CHECK DRAWINGS OF OTHER TRADES RELATING TO WORK TO VERIFY SPACE IN WHICH WORK WILL BE INSTALLED. MAINTAIN HEADROOM AND MINIMUM CODE REQUIRED WORKING CLEARANCES AT ALL TIMES.
- B. HASH MARKS INDICATING NUMBER OF CONDUCTORS ARE SHOWN ONLY FOR HOMERUNS. CONTRACTOR IS RESPONSIBLE FOR INSTALLING CONDUCTORS AS REQUIRED TO ACHIEVE FUNCTIONS INDICATED.
- C. ALL EQUIPMENT, DEVICES AND LIGHT FIXTURES LOCATED OUTDOORS SHALL BE UL LISTED FOR WET LOCATIONS OR BE ENCLOSED IN A NEMA 3R ENCLOSURE.
- D. WHERE WIRE SIZES ARE INDICATED ON THE PLANS FOR INDIVIDUAL CIRCUITS, THE WIRE SIZE INDICATED SHALL BE CARRIED THROUGH TO CIRCUIT TERMINATION POINT UON.
- E. ALL POWER, LIGHTING AND RECEPTACLE BRANCH CIRCUITS, AND ALL FEEDERS SHALL INCLUDE A GROUND CONDUCTOR SIZED ACCORDING TO CEC.
- F. PROVIDE ACOUSTICAL TREATMENT FOR ALL CONDUIT AND OUTLET BOX PENETRATIONS IN ACOUSTICAL PARTITIONS.
- G. REFER TO ARCHITECTURAL DRAWINGS FOR EXACT CEILING TYPE AND OCATIONS OF FIXTURES AND OTHER CEILING DEVICES PRIOR TO ROUGH-IN.
- H. PROVIDE SEPARATE NEUTRAL CONDUCTOR FOR ALL DIMMING CIRCUITS AND RECEPTACLE CIRCUITS FOR COMMUNICATIONS, SECURITY AND SOUND EQUIPMENT
- CONTRACTOR SHALL VERIFY THE EXACT LOCATION OF ALL MECHANICAL, PLUMBING AND ALL OTHER USER EQUIPMENT REQUIRING ELECTRICAL CONNECTIONS PRIOR TO ANY
- CONTRACTOR SHALL EXTEND WIRING FROM ALL JUNCTION BOXES, SWITCHES, ETC. AND MAKE FINAL CONNECTION AS REQUIRED TO ALL EQUIPMENT REQUIRING ELECTRICAL CONNECTIONS.
- K. ALL MOUNTING HEIGHTS SHOWN ARE TO CENTER LINE OF OUTLET OR DEVICE AND SHALL APPLY UNLESS INDICATED OTHERWISE. SEE ARCHITECTURAL ELEVATIONS FOR EXACT LOCATIONS.
- WALL OUTLET BOXES FOR SWITCHES, RECEPTACLES ETC WITH TACK BOARDS, CABINETS, CHALKBOARDS, FURNITURE, EQUIPMENTS ETC. TO AVOID CONFLICT.


L. CONTRACTOR SHALL COORDINATE THE LOCATION OF ALL

- M. WHERE ELECTRIC MOTORS OR HEATERS ARE INSTALLED IN HUNG CEILING, PROVIDE DISCONNECT SWITCH IN HUNG CEILING WITHIN REACH FROM ACCESS POINT.
- N. PROVIDE PULL WIRE IN EACH RACEWAY RUN OVER 10 FEET IN LENGTH, IN WHICH PERMANENT WIRING IS NOT INSTALLED.
- O. SEE MECHANICAL DRAWINGS FOR ADDITIONAL CONNECTION REQUIREMENTS TO CONTROL PANELS AND TRANSFORMERS, 120V FOR CONTROL SYSTEM, CONTROL SYSTEM, EP AND PE SWITCHES, TIME CLOCK, VALVES, RELAYS LOCATION, ETC. INDICATED ON CONTROL WIRING DIAGRAMS. VERIFY FINAL CONTROL WIRING REQUIREMENTS WITH DIVISION 23 PRIOR TO ANY WORK AND PROVIDE ALL NECESSARY WIRING, DEVICES AND CONNECTIONS AS REQUIRED.
- P. LIGHTING, POWER, TELEPHONE AND COMMUNICATIONS OUTLETS SHALL NOT BE PLACED BACK TO BACK. OUTLETS SHALL BE SEPARATED MIN. OF 24" IN FIRE-RATED WALLS AND MIN. 18" IN NON-RATED WALLS.
- Q. ALL CONDUIT SHALL BE RUN CONCEALED IN HUNG CEILING SPACE, IN WALLS, OR UNDER FLOOR, UNLESS SPECIFICALLY INDICATED OTHERWISE.
- R. PROVIDE PULLBOXES WHEREVER NECESSARY TO FACILITATE PULLING OF CONDUCTORS. COORDINATE LOCATIONS OF BOXES WITH OTHER TRADES TO AVOID CONFLICT. PULLBOXES SHALL BE ACCESSIBLE. THE SIZE OF EACH PULLBOX SHALL COMPLY WITH CEC REQUIREMENTS.
- S. OUTLET BOXES FOR FIXTURES RECESSED IN HUNG CEILING SHALL BE ACCESSIBLE THROUGH OPENING CREATED BY REMOVAL OF FIXTURES.
- T. USE OF AC OR MC TYPE CABLES FOR BRANCH CIRCUIT WIRING ARE PERMISSABLE IN ALL AREAS.
- U. ALL ELECTRIC MATERIAL SHALL BE LISTED BY "UL" FOR THE TYPE OF APPLICATION AND "UL" LABEL SHALL APPEAR ON ALL ELECTRICAL EQUIPMENT.
- V. WHERE RECEPTACLES WITH GFCI LOCATED ADJACENT TO A SINK, MOUNT 6" ABOVE COUNTER OR BACKSPLASH.

ARCHITECTS



729 Heinz Avenue

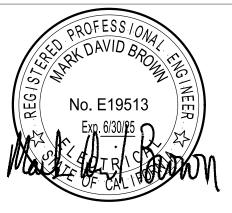



P 415 655 4000 F 415 655 4001

E g&b@gb-eng.com

PROJECT TITLE

SONOMA COUNTY **PETALUMA REGIONAL LIBRARY RENOVATION** PROJECT NO.

100 FAIRGROUNDS DRIVE PETALUMA, CA 94952

PERMIT SET

DESCRIPTION

I&T JOB NUMBER

1/22/2024 RESUBMITTAL 2 4/25/2024 RESUBMITTAL 2

> REVIEWED FOR CODE COMPLIANCE 05/03/2024

> > Shums Coda Associates

LEGEND, SYMBOLS, **GENERAL NOTES &** DRAWING LIST

SHEET NUMBER

E0.01

Report Version: 2022.0.000

Schema Version: rev 20220101

Compliance ID: EnergyPro-5490-0124-0511

Report Generated: 2024-01-22 14:20:21

CA Building Energy Efficiency Standards - 2022 Nonresidential Compliance


Report Version: 2022.0.000

Schema Version: rev 20220101

CA Building Energy Efficiency Standards - 2022 Nonresidential Compliance

NOLL & TAM ARCHITECTS

> 729 Heinz Avenue Berkeley, CA 94710 tel 510.542.2200 fax 510.542.2201

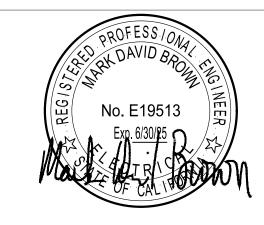



PROJECT TITLE

PETALUMA
REGIONAL
LIBRARY
RENOVATION
PROJECT NO.
10-19

100 FAIRGROUNDS DRIVE PETALUMA, CA 94952

PERMIT SET

SSUE DATE 11/2 N&T JOB NUMBER

DATE DESCR

1/22/2024 RESUBMITTAL

REVIEWED FOR CODE COMPLIANCE

05/03/2024

Shums Coda Associates

SHEET TITLE

LIGHTING TITLE 24 CALCULATIONS

SHEET NUMBER

Compliance ID: EnergyPro-5490-0124-0511

Report Generated: 2024-01-22 14:20:21

E0.02


APPROVALS

Login: DAIN EILER
Drawing File:NAT02203zE002.dwg
Plotting Date: 1/23/2024 4:53 PM

Schema Version: rev 20220101

							NRCC-LTO		
Project Name: PETALUMA	REGIONAL LIBRARY REFRESH		Report Page:						
			Date Prepared:				1/22/202		
				,		,			
H. OUTDOOR LIGHTING	CONTROLS								
existing to remain (ie untou the permit application. Outdoor lighting for nonres	mpliance with controls requirements for uched) and luminaires which are remove sidential buildings, parking garages and controlled from the inside of a dwelling	red and reinstalled (wirii d common service areas	ng only) do not need	d to be included in	this table even if th	ey are within the sp	aces covered by		
	onresidential Occupancies, Parking Ga		in Multifamily Bui	ildings		·			
01	02	03		04		05			
Area Description	Area Description Shut-Off Auto-S 130.2(c)1 / 160.5(c) 130.2(c)2		30740	Motion Ser		Field Inspector			
			(c)	130.2(c)3 / 16	90.5(c)	Pass	Fail		
FOOTNOTE To 12 1	breviated, please refer to Table 160.5-A to a								
his table includes areas us	OWANCE (per 140.7 / 170.2(e)) sing allowance calculations per 140.7 / r Table 140.7-4/Table 170.2-R while "U			material and a second	01				
Hardscape Allowance is per Table 140.7-A/Table 170.2-R while "Use it or lose it" Allowances are per Table 140.7-B /Table 170.2-S. Indicate which allowances are being				"Use it or lose	all that apply) (select all that apply)				
used to expand sections for lose it" allowances shall no Outdoor lighting attached dwelling unit are included in Dutdoor lighting is included	☐ General Hardscape Allowance Table I (below)	☐ Per Application Table J	☐ Sales Frontage Table K	☐ Ornamental Table L	☑ Per Specific Area Table M				
. LIGHTING ALLOWANC	E: PER APPLICATION								
This section does not apply	to this project.								
K. LIGHTING ALLOWANG	E: SALES FRONTAGE								
This section does not apply	to this project.								
· · · · · · · · · · · · · · · · · · ·	,			;		·			
		Gene	rated Date/Time:			Documentation S	Software: EnergyPr		
				Version: 2022.0.000 Version: rev 20220101			Compliance ID: EnergyPro-5490-0124-0513 Report Generated: 2024-01-22 14:27:04		
	Standards - 2022 Nonresidential Compliar		rt Version: 2022.0.00 ma Version: rev 20220		C				
CA Building Energy Efficiency	Standards - 2022 Nonresidential Compliar					Report Generated: 2	2024-01-22 14:27:0		
CA Building Energy Efficiency STATE OF CALIFORNIA Dutdoor Lighting					C	Report Generated: 2	2024-01-22 14:27:04 ERGY COMMISSIC		
CA Building Energy Efficiency STATE OF CALIFORNIA Outdoor Lighting CERTIFICATE OF COMPLIANCE					C	Report Generated: 2	2024-01-22 14:27:0		

Schema Version: rev 20220101

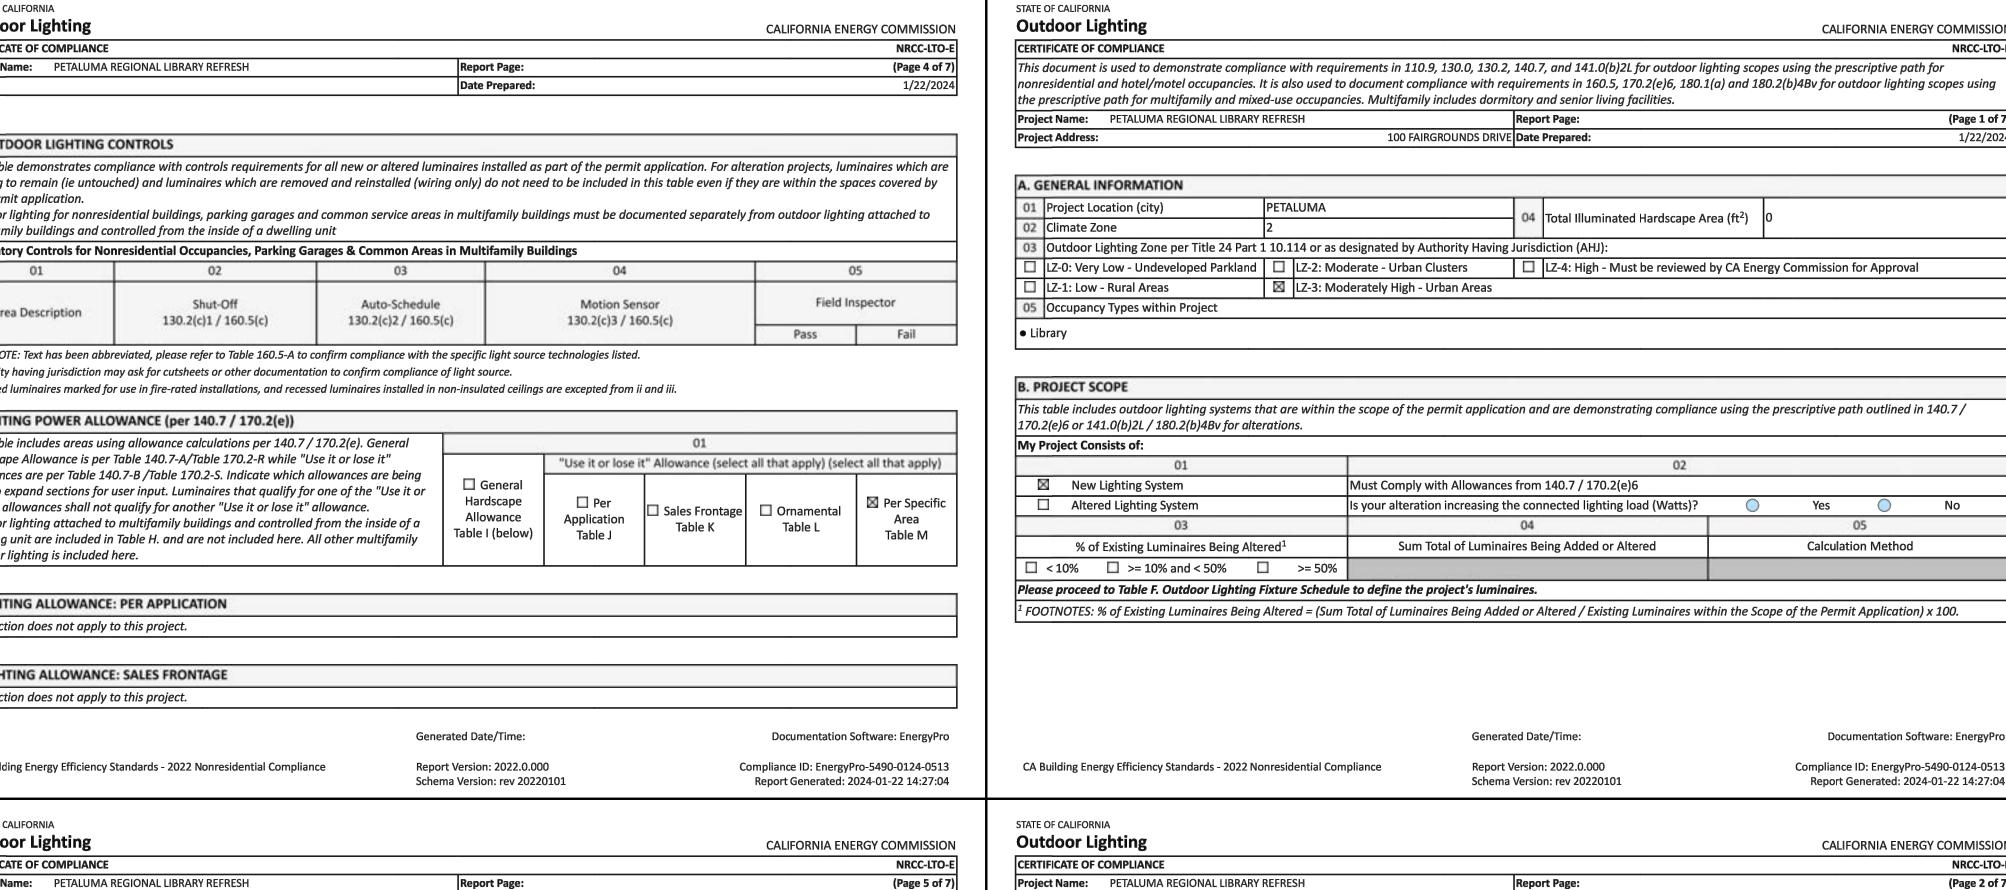

Compliance ID: EnergyPro-5490-0124-0513

C. COMPLIANCE RESULTS

140.7(d)2 / 170.2(e)6

(See Table J)

Allowance

170.2(e)6

(See Table I)

D. EXCEPTIONAL CONDITIONS

140.7(d)1/

to Table D. Exceptional Conditions for guidance or see applicable Table referenced below.

Frontage

140.7(d)2

(See Table K)


Calculations of Total Allowed Lighting Power (Watts) 140.7 / 170.2(e)6 or 141.0(b)2L / 180.2(b)4Bv

140.7(d)2 / 170.2(e)6

(See Table L)

This table is auto-filled with uneditable comments because of selections made or data entered in tables throughout the form.

Shielding Compliance (See Table G for Details) Controls Compliance (See Table H for Details

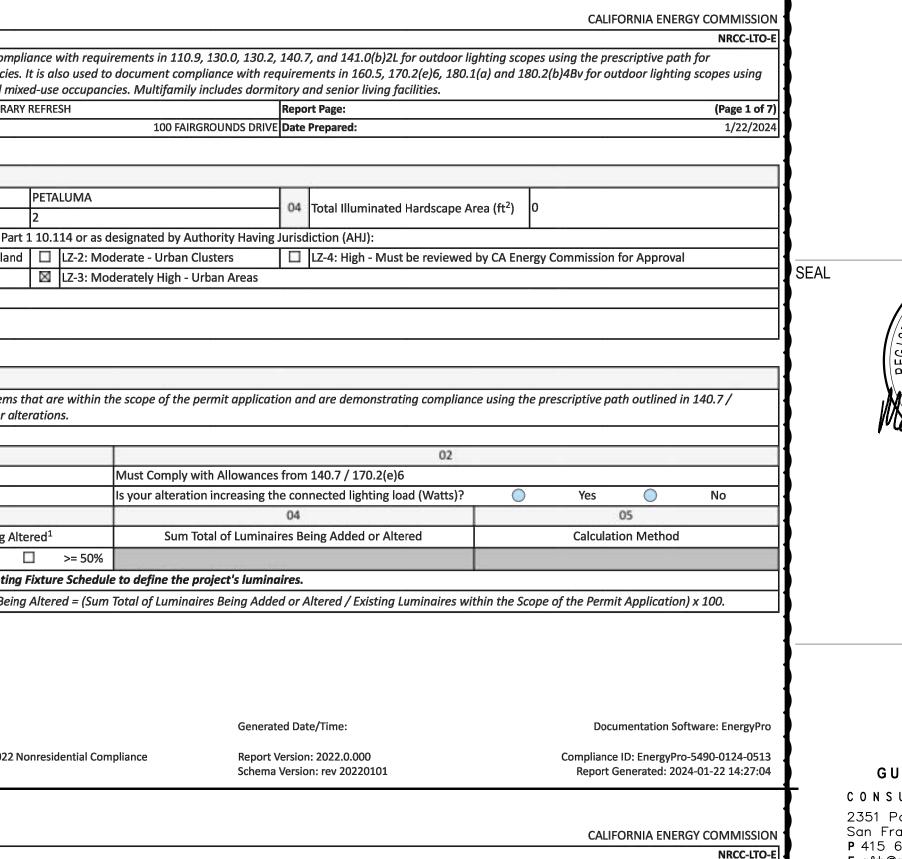



(Page 2 of 7

07 must be >= 08

COMPLIES

Not applicabl

PROJECT TITLE

Compliance Results

Total Actual

(Watts)

198

729 Heinz Avenue

tel 510.542.2200

fax 510.542.2201

Berkeley, CA 94710

SONOMA COUNTY **PETALUMA REGIONAL LIBRARY**

100 FAIRGROUNDS DRIVE PETALUMA, CA 94952

PERMIT SET

OB NUMBER 1/22/2024 RESUBMITTAL

05/03/2024 Shums Coda Associates

REVIEWED FOR CODE COMPLIANCE

LIGHTING TITLE 24 CALCULATIONS

ET NUMBER

E0.03

ROVALS

	Area Description	Area Description Shut-Off 130.2(c)1 / 160.5(c)			Motion Sensor 130.2(c)3 / 160.5(c)				Field Inspector				
ce (responsible designer)		¹ FOOTNOTE: Text has been abbreviated, please refer to Table 160.5-A to confirm compliance with the specific light source technologies listed. ² Authority having jurisdiction may ask for cutsheets or other documentation to confirm compliance of light source.								Pass Fail			
e of Compliance conform to the requirements nce documents, worksheets, calculations,		or use in fire-rated installations, and recesse	ed luminaires installed i	n non-insula	ted ceilings are	excepted from ii	and iii.						
the enforcement agency for all applicable ng owner at occupancy.	This table includes areas usi	ing allowance calculations per 140.7 / 1					01						
	Allowances are per Table 14	Table 140.7-A/Table 170.2-R while "Us 10.7-B /Table 170.2-S. Indicate which all 10.7-B /Table 170.2-S.	lowances are being	□G	eneral "'	Jse it or lose i	t" Allowance (selec	ct all that ap	ply) (select	all that apply			
	lose it" allowances shall not Outdoor lighting attached to	user input. Luminaires that qualify for a qualify for another "Use it or lose it" a o multifamily buildings and controlled f n Table H. and are not included here. Al here.	llowance. from the inside of a	Hardscape Allowance		☐ Per Application Table J ☐ Sales Frontage Table K		e		☑ Per Specit Area Table M			
	J. LIGHTING ALLOWANCE	: PER APPLICATION											
	This section does not apply to this project. K. LIGHTING ALLOWANCE: SALES FRONTAGE												
	This section does not apply												
Documentation Software: EnergyPro			Ge	nerated Date	e/Time:			Docun	nentation Sof	tware: EnergyF			
liance ID: EnergyPro-5490-0124-0513 port Generated: 2024-01-22 14:27:04	CA Building Energy Efficiency S	Standards - 2022 Nonresidential Compliand		port Version: nema Versior	2022.0.000 n: rev 20220101					-5490-0124-05 4-01-22 14:27:			
	STATE OF CALIFORNIA Outdoor Lighting							CALIFO	PRNIA ENER	GY COMMISS			
	CERTIFICATE OF COMPLIANCE Project Name: PETALUMA	REGIONAL LIBRARY REFRESH		Repor	t Page:				NRCC-LT				
				Date F	repared:					1/22/2			
	L. LIGHTING ALLOWANCE	:: ORNAMENTAL											
	This section does not apply												
	M. LIGHTING ALLOWANG	E: PER SPECIFIC AREA	grag from Table 140	7 P /Table	170.2.5 More	than one spec	ific area allowance	may he tal	kon in a sina	la project if			
		le specific area allowances may not be				06							
		Specific Area Type per T	CALCULAT	ED ALLOW	ANCE (Watts)	Luminaire	DESIGN V			Addition			
	Area Description	140.7-B	Specific Area (ft²)¹	Density (W/ft²)	1 1000000000000000000000000000000000000		Watts per Luminaire	# of Luminaires	Design Wa	Allowand (Watts			
	NS Canopy	NonSalesCanopy	1220	0.3	329.4	ZS1	33 Ital Design Watts fo	6	198	198			
									atts) All Are	as: 198			
		based on information provided in this of documents must be provided to the built	lding inspector during	g constructi	_		cant, an explanatio	on should be	e included in	Table E.			
	NRCI-LTO-E - Must be submi	itted for all buildings		Form/Title									
	CA Building Energy Efficiency	ce Re	Generated Date/Time: Report Version: 2022.0.000 Schoma Version: roy 20220101				Documentation Software: EnergyP Compliance ID: EnergyPro-5490-0124-05						
	Schema Version: rev 20220101 Report Generated: 2024-01												
	Outdoor Lighting	STATE OF CALIFORNIA Outdoor Lighting CERTIFICATE OF COMPLIANCE NRCC-											
	Project Name: PETALUMA	Project Name: PETALUMA REGIONAL LIBRARY REFRESH Report Page: Date Prepared: Date Prepared:								(Page 6 o			
	P. DECLARATION OF REQUE	UIRED CERTIFICATES OF ACCEPTAN	CE										
	There are no NRCA forms re	quirea for this project.				.							
				nerated Date				Documentation Software: EnergyF					
	CA Building Energy Efficiency	Standards - 2022 Nonresidential Compliand		port Version:	2022.0.000 n: rev 20220101		1	Compliance I Report Ge		-5490-0124-05			

													}
		E. ADDITIONAL REMARKS This table includes remarks made by the permit applicant to the Authority Having Jurisdiction.											ł
	i nis table include	es remarks made by the p	ermit applicant to	tne Autnority Ho	iving Jurisaictic	on.							ł
												•	ł
hould be included in Table E.												•	ł
7												•	{
												•	
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												•	
Documentation Software: EnergyPro						Generated Date/Time:				Documentation Software: EnergyPro			
pliance ID: EnergyPro-5490-0124-0513 eport Generated: 2024-01-22 14:27:04	CA Building Energ	CA Building Energy Efficiency Standards - 2022 Nonresidential Compliance				Report Version: 2022.0.000 Schema Version: rev 20220101				Compliance ID: EnergyPro-5490-0124-0513 Report Generated: 2024-01-22 14:27:04			
													F
CALIFORNIA ENERGY COMMISSION	STATE OF CALIFORNIA Outdoor Lig								CALI	FORNIA ENERG	Y COMN	AISSION ¹	100115 5
NRCC-LTO-E	CERTIFICATE OF CO								CALI	TOTAL ENERG		CC-LTO-E	ISSUE D
(Page 6 of 7)	Project Name:	PETALUMA REGIONAL LIBRA	ARY REFRESH			Report Page:				(Page 3 of			
1/22/2024						Date Prepared:	1/22/20				REVISIO		
												•	
	F. OUTDOOR LI	GHTING FIXTURE SCH	DULE										1
		ed lighting systems demoi											}
		ed by the permit applicat			_		-	-		•		_	}
		installed and replacement luminaires being installed as part of the project scope are included (ie, existing luminaires remaining or existing luminaires being moved are not included). Outdoor lighting attached to multifamily buildings and controlled from the inside of a dwelling unit are included in Table H. and are not included here. All other multifamily outdoor											
	lighting is include		-	-	-		:)
	Designed Watta			03	04	05	oc.	0.7	0.0	00		0)
	01	01 02			04	05 Total Number	06 r Luminaire	07 Excluded per	08	09 Cutoff Req. > 6,200 initial	_	.0)
	Name or Item	me or Item			How is						Field Inspector		1
	Tag	Lomplete Luminaire Des		Watts per luminaire ^{1, 2}	Wattage determined	Luminaires ²	S. B. C. S.	140.7(a) / 170.2(e)6A	Design Watts	130.2(b) / 160.5(c)1 ⁴			}
	ZS1	ZS1	Linear	33	Mfr. Spec	6	New		198	NA: < 6200 lumens			}
	* NOTES: Selection	* NOTES: Selections with a * require a note in the space below explaining how compliance is achieved											
		* NOTES: Selections with a * require a note in the space below explaining how compliance is achieved. EX: Luminaire is lighting a statue; EXCEPTION 2 to 130.2(b)										SHEE	
		FOOTNOTES: Authority Having Jurisdiction may ask for Luminaire cut sheets to confirm wattage used for compliance per 130.0(c) / 160.5(b)											
		² For linear luminaires, wattage should be indicated as W/lf instead of Watts/luminaire. Total linear feet should be indicated in column 05 instead of number of luminaires. ³ Select "New" for new luminaires in a new outdoor lighting project, or for added luminaires in an alteration. Select "Altered" for replacement luminaires in an alteration. Select "Existing to Remain"											
	for existing luminal	for existing luminaires within the project scope that are not being altered and are remaining. Select "Existing Reinstalled" for existing luminaires which are being removed and reinstalled as part of											
		the project scope. 4 Compliance with mandatory shielding requirements is required for luminaires with initial lumen output >= 6,200 unless exempted by 130.2(b)/ 160.5(c)											
	,												
	G. SHIELDING I	G. SHIELDING REQUIREMENTS (BUG)										SHEE	
	This section does not apply to this project.												
		The second depth of the project											
												•	
												•	
												•	
ocumentation Coftware Face Pro	Consended Data (Figure									APPR			
ocumentation Software: EnergyPro		Generated Date/Time:					e: Documentation Software: Energ					ergyPro	{
nce ID: EnergyPro-5490-0124-0513	CA Building Energ	y Efficiency Standards - 202	2 Nonresidential Cor	mpliance		Version: 2022.0.00 Version: rev 2022				e ID: EnergyPro-5			{
port Generated: 2024-01-22 14:27:04					Juleilla	. version, rev 2022			Λεροιτ	Generated: 2024	· ψ1-22 Ι΄	T.27.U4	-
													4

Results in this table are automatically calculated from data input and calculations in Tables F through N. Note: If any cell on this table says "COMPLIES with Exceptional Conditions" refer

140.7(d)2/

170.2(e)6

(See Table M)

Allowance

141.0(b)2L/


180.2(b)48v

(See Table N)

Total Allowed

(Watts)

198

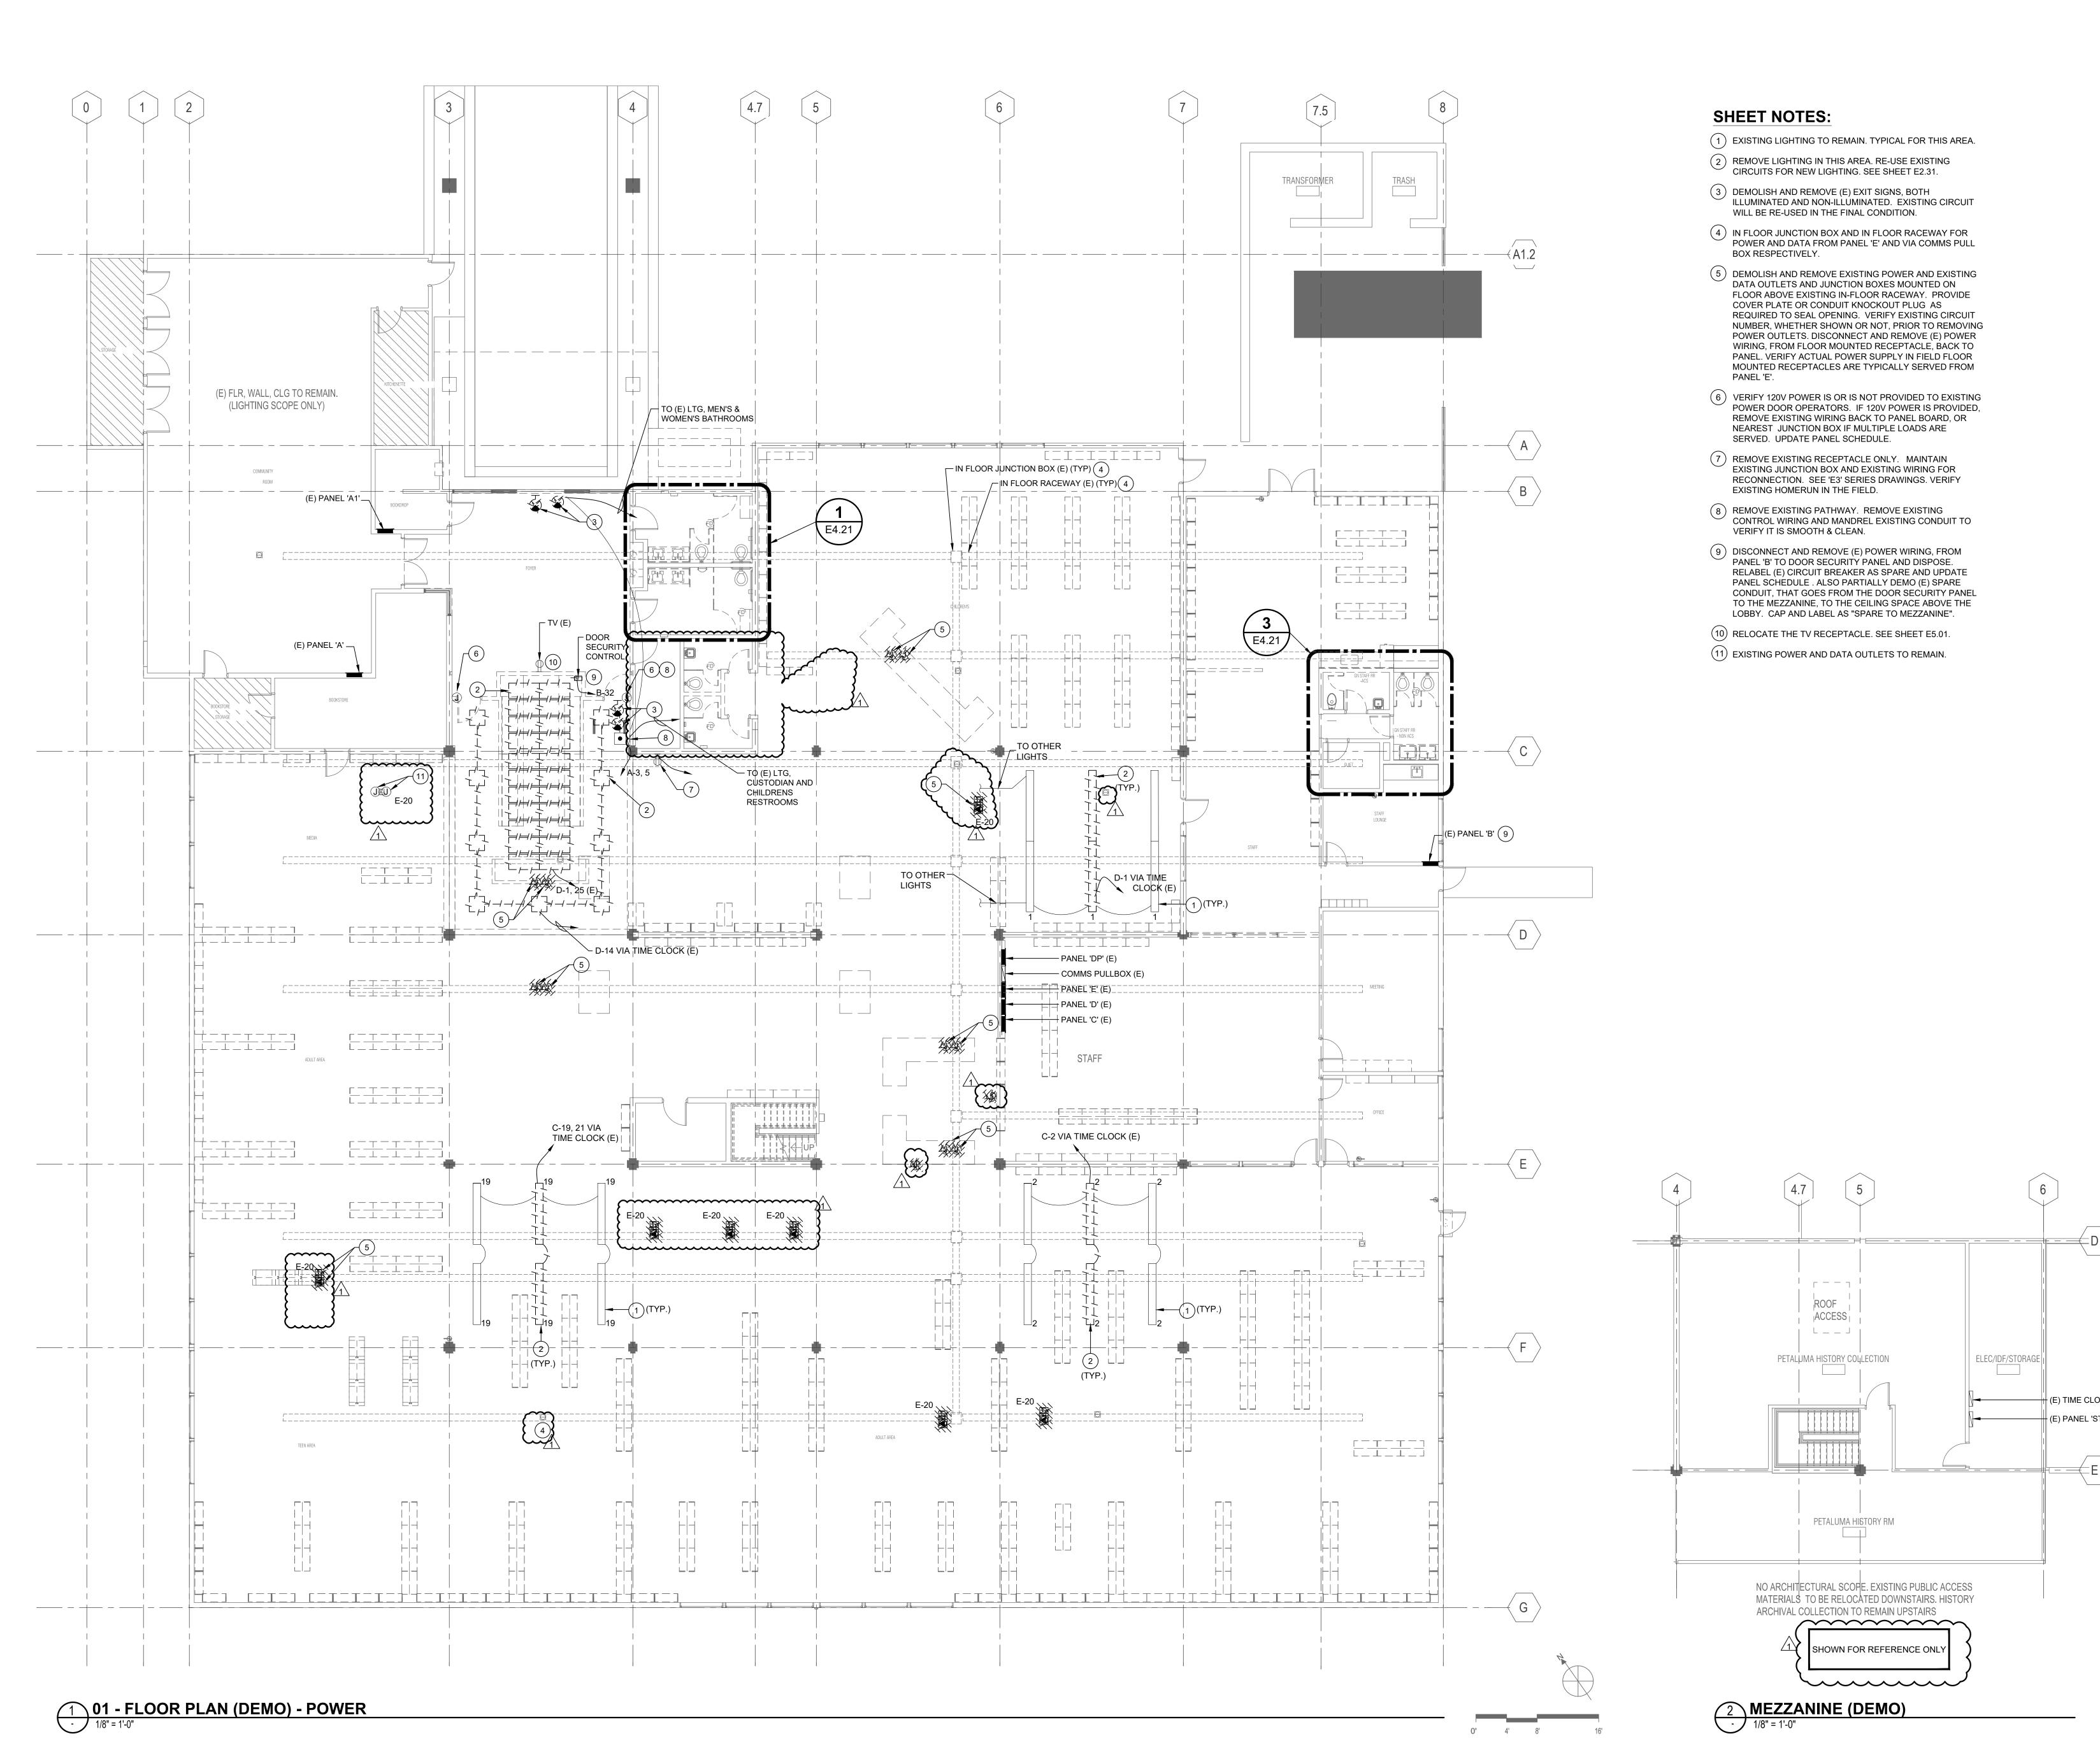

SHEET NOTES:

- (1) EXISTING LIGHTING TO REMAIN. TYPICAL FOR THIS AREA.
- 2 REMOVE LIGHTING IN THIS AREA. RE-USE EXISTING CIRCUITS FOR NEW LIGHTING. SEE SHEET E2.31.
- (3) DEMOLISH AND REMOVE (E) EXIT SIGNS, BOTH ILLUMINATED AND NON-ILLUMINATED. EXISTING CIRCUIT WILL BE RE-USED IN THE FINAL CONDITION.
- (4) IN FLOOR JUNCTION BOX AND IN FLOOR RACEWAY FOR POWER AND DATA FROM PANEL 'E' AND VIA COMMS PULL BOX RESPECTIVELY.
- (5) DEMOLISH AND REMOVE EXISTING POWER AND EXISTING DATA OUTLETS AND JUNCTION BOXES MOUNTED ON FLOOR ABOVE EXISTING IN-FLOOR RACEWAY. PROVIDE COVER PLATE OR CONDUIT KNOCKOUT PLUG AS REQUIRED TO SEAL OPENING. VERIFY EXISTING CIRCUIT NUMBER, WHETHER SHOWN OR NOT, PRIOR TO REMOVING POWER OUTLETS. DISCONNECT AND REMOVE (E) POWER WIRING, FROM FLOOR MOUNTED RECEPTACLE, BACK TO PANEL. VERIFY ACTUAL POWER SUPPLY IN FIELD FLOOR MOUNTED RECEPTACLES ARE TYPICALLY SERVED FROM PANEL 'E'.
- (6) VERIFY 120V POWER IS OR IS NOT PROVIDED TO EXISTING POWER DOOR OPERATORS. IF 120V POWER IS PROVIDED, REMOVE EXISTING WIRING BACK TO PANEL BOARD, OR NEAREST JUNCTION BOX IF MULTIPLE LOADS ARE SERVED. UPDATE PANEL SCHEDULE.
- EXISTING JUNCTION BOX AND EXISTING WIRING FOR RECONNECTION. SEE 'E3' SERIES DRAWINGS. VERIFY EXISTING HOMERUN IN THE FIELD. 8 REMOVE EXISTING PATHWAY. REMOVE EXISTING

(7) REMOVE EXISTING RECEPTACLE ONLY. MAINTAIN

VERIFY IT IS SMOOTH & CLEAN. (9) DISCONNECT AND REMOVE (E) POWER WIRING, FROM PANEL 'B' TO DOOR SECURITY PANEL AND DISPOSE. RELABEL (E) CIRCUIT BREAKER AS SPARE AND UPDATE PANEL SCHEDULE . ALSO PARTIALLY DEMO (E) SPARE

LOBBY. CAP AND LABEL AS "SPARE TO MEZZANINE".

CONTROL WIRING AND MANDREL EXISTING CONDUIT TO

CONDUIT, THAT GOES FROM THE DOOR SECURITY PANEL TO THE MEZZANINE, TO THE CEILING SPACE ABOVE THE

- (10) RELOCATE THE TV RECEPTACLE. SEE SHEET E5.01.
- (11) EXISTING POWER AND DATA OUTLETS TO REMAIN.


ROOF ACCESS

PETALUMA HISTORY COLLECTION


I PETALUMA HISTORY RM

ARCHIVAL COLLECTION TO REMAIN UPSTAIRS

NO ARCHITECTURAL SCOPE. EXISTING PUBLIC ACCESS MATERIALS TO BE RELOCATED DOWNSTAIRS. HISTORY

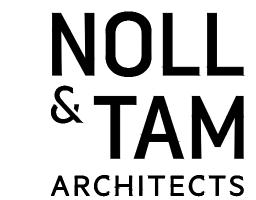

729 Heinz Avenue Berkeley, CA 94710 tel 510.542.2200 fax 510.542.2201

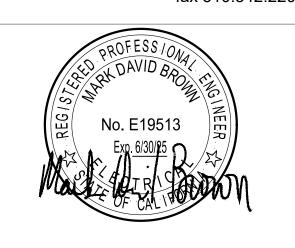



PROJECT TITLE

SONOMA COUNTY **PETALUMA REGIONAL LIBRARY** RENOVATION PROJECT NO.

100 FAIRGROUNDS DRIVE PETALUMA, CA 94952

PERMIT SET

N&T JOB NUMBER

1 1/22/2024 RESUBMITTAL

REVIEWED FOR CODE COMPLIANC 05/03/2024 Shums Coda Associates

DEMOLITION PLAN - 1ST FLOOR AND MEZZANINE

- POWER

SHEET NUMBER

E1.31


APPROVALS

SHOWN FOR REFERENCE ONLY 2 MEZZANINE (DEMO) 1/8" = 1'-0"

ELEC/IDF/STORAGE


(E) TIME CLOCK

(E) PANEL 'STS'

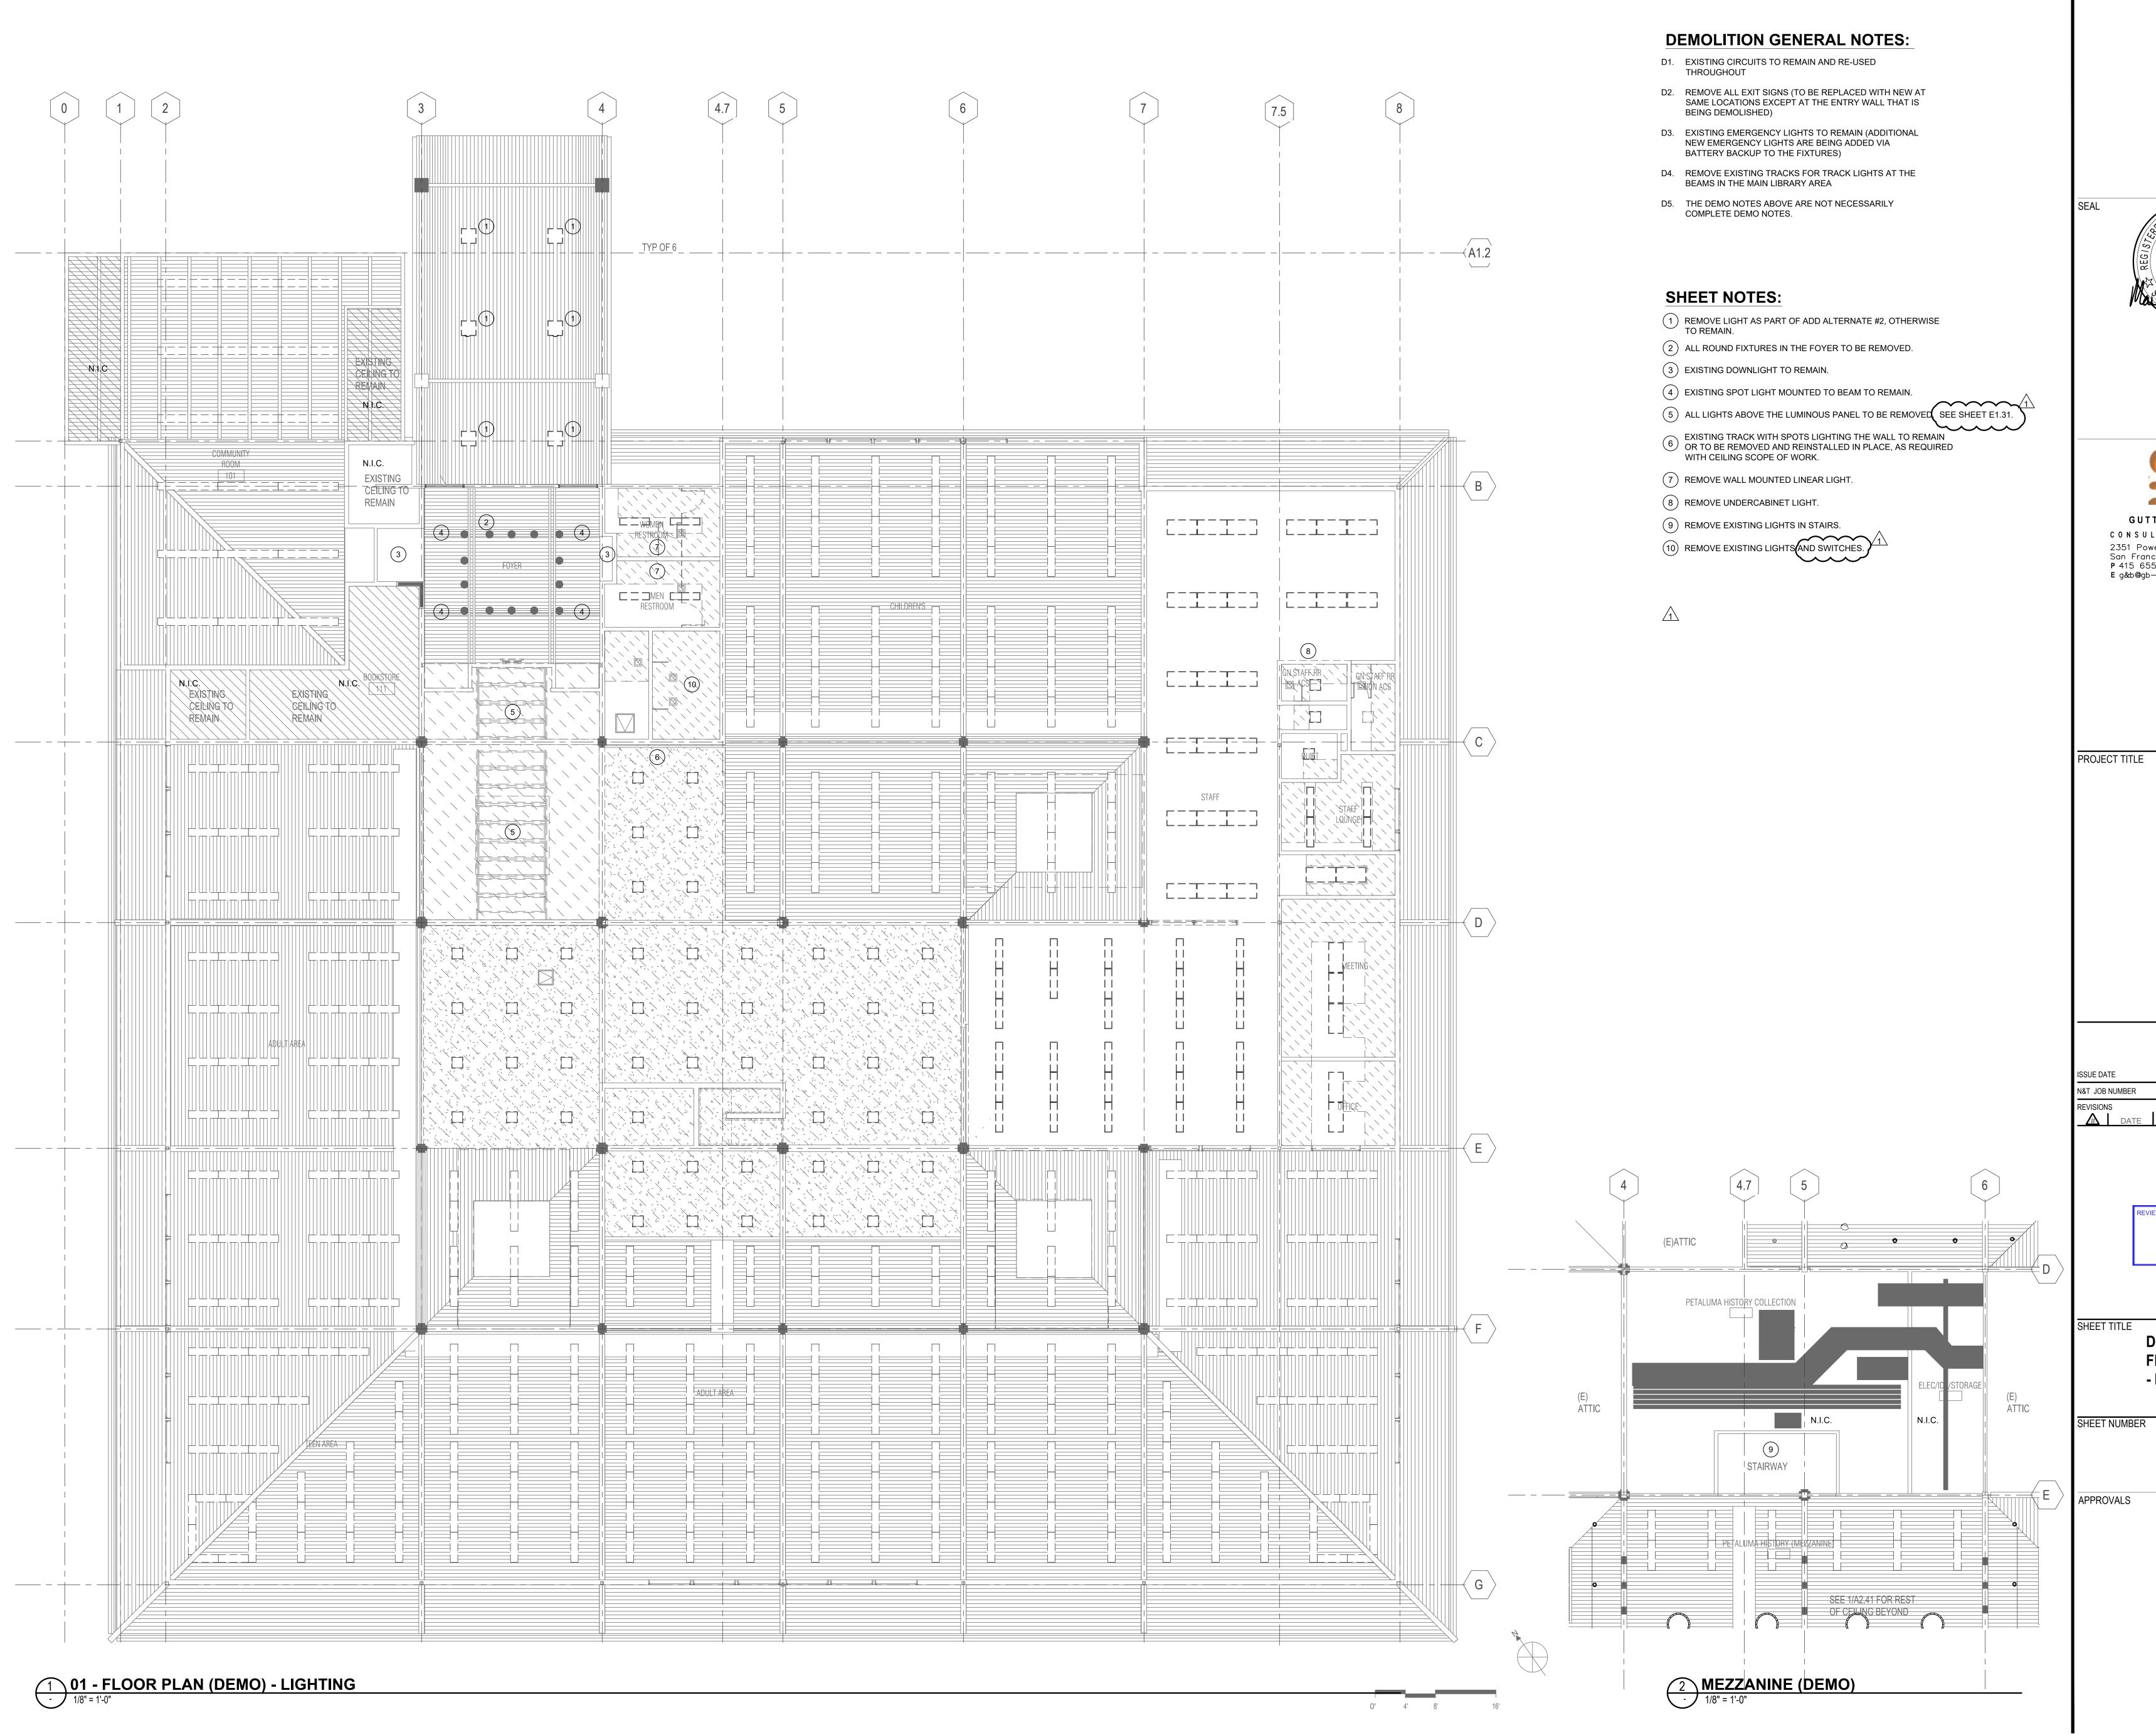

ARCHITECTS

729 Heinz Avenue Berkeley, CA 94710 tel 510.542.2200 fax 510.542.2201

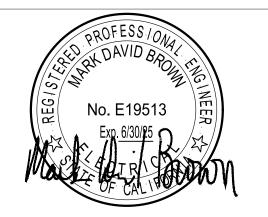



SONOMA COUNTY **PETALUMA REGIONAL LIBRARY RENOVATION** PROJECT NO.

100 FAIRGROUNDS DRIVE PETALUMA, CA 94952


PERMIT SET

DESCRIPTION

REVIEWED FOR CODE COMPLIANCE 05/03/2024 Shums Coda Associates

DEMOLITION PLAN - 1ST FLOOR AND MEZZANINE - LIGHTING

E1.41

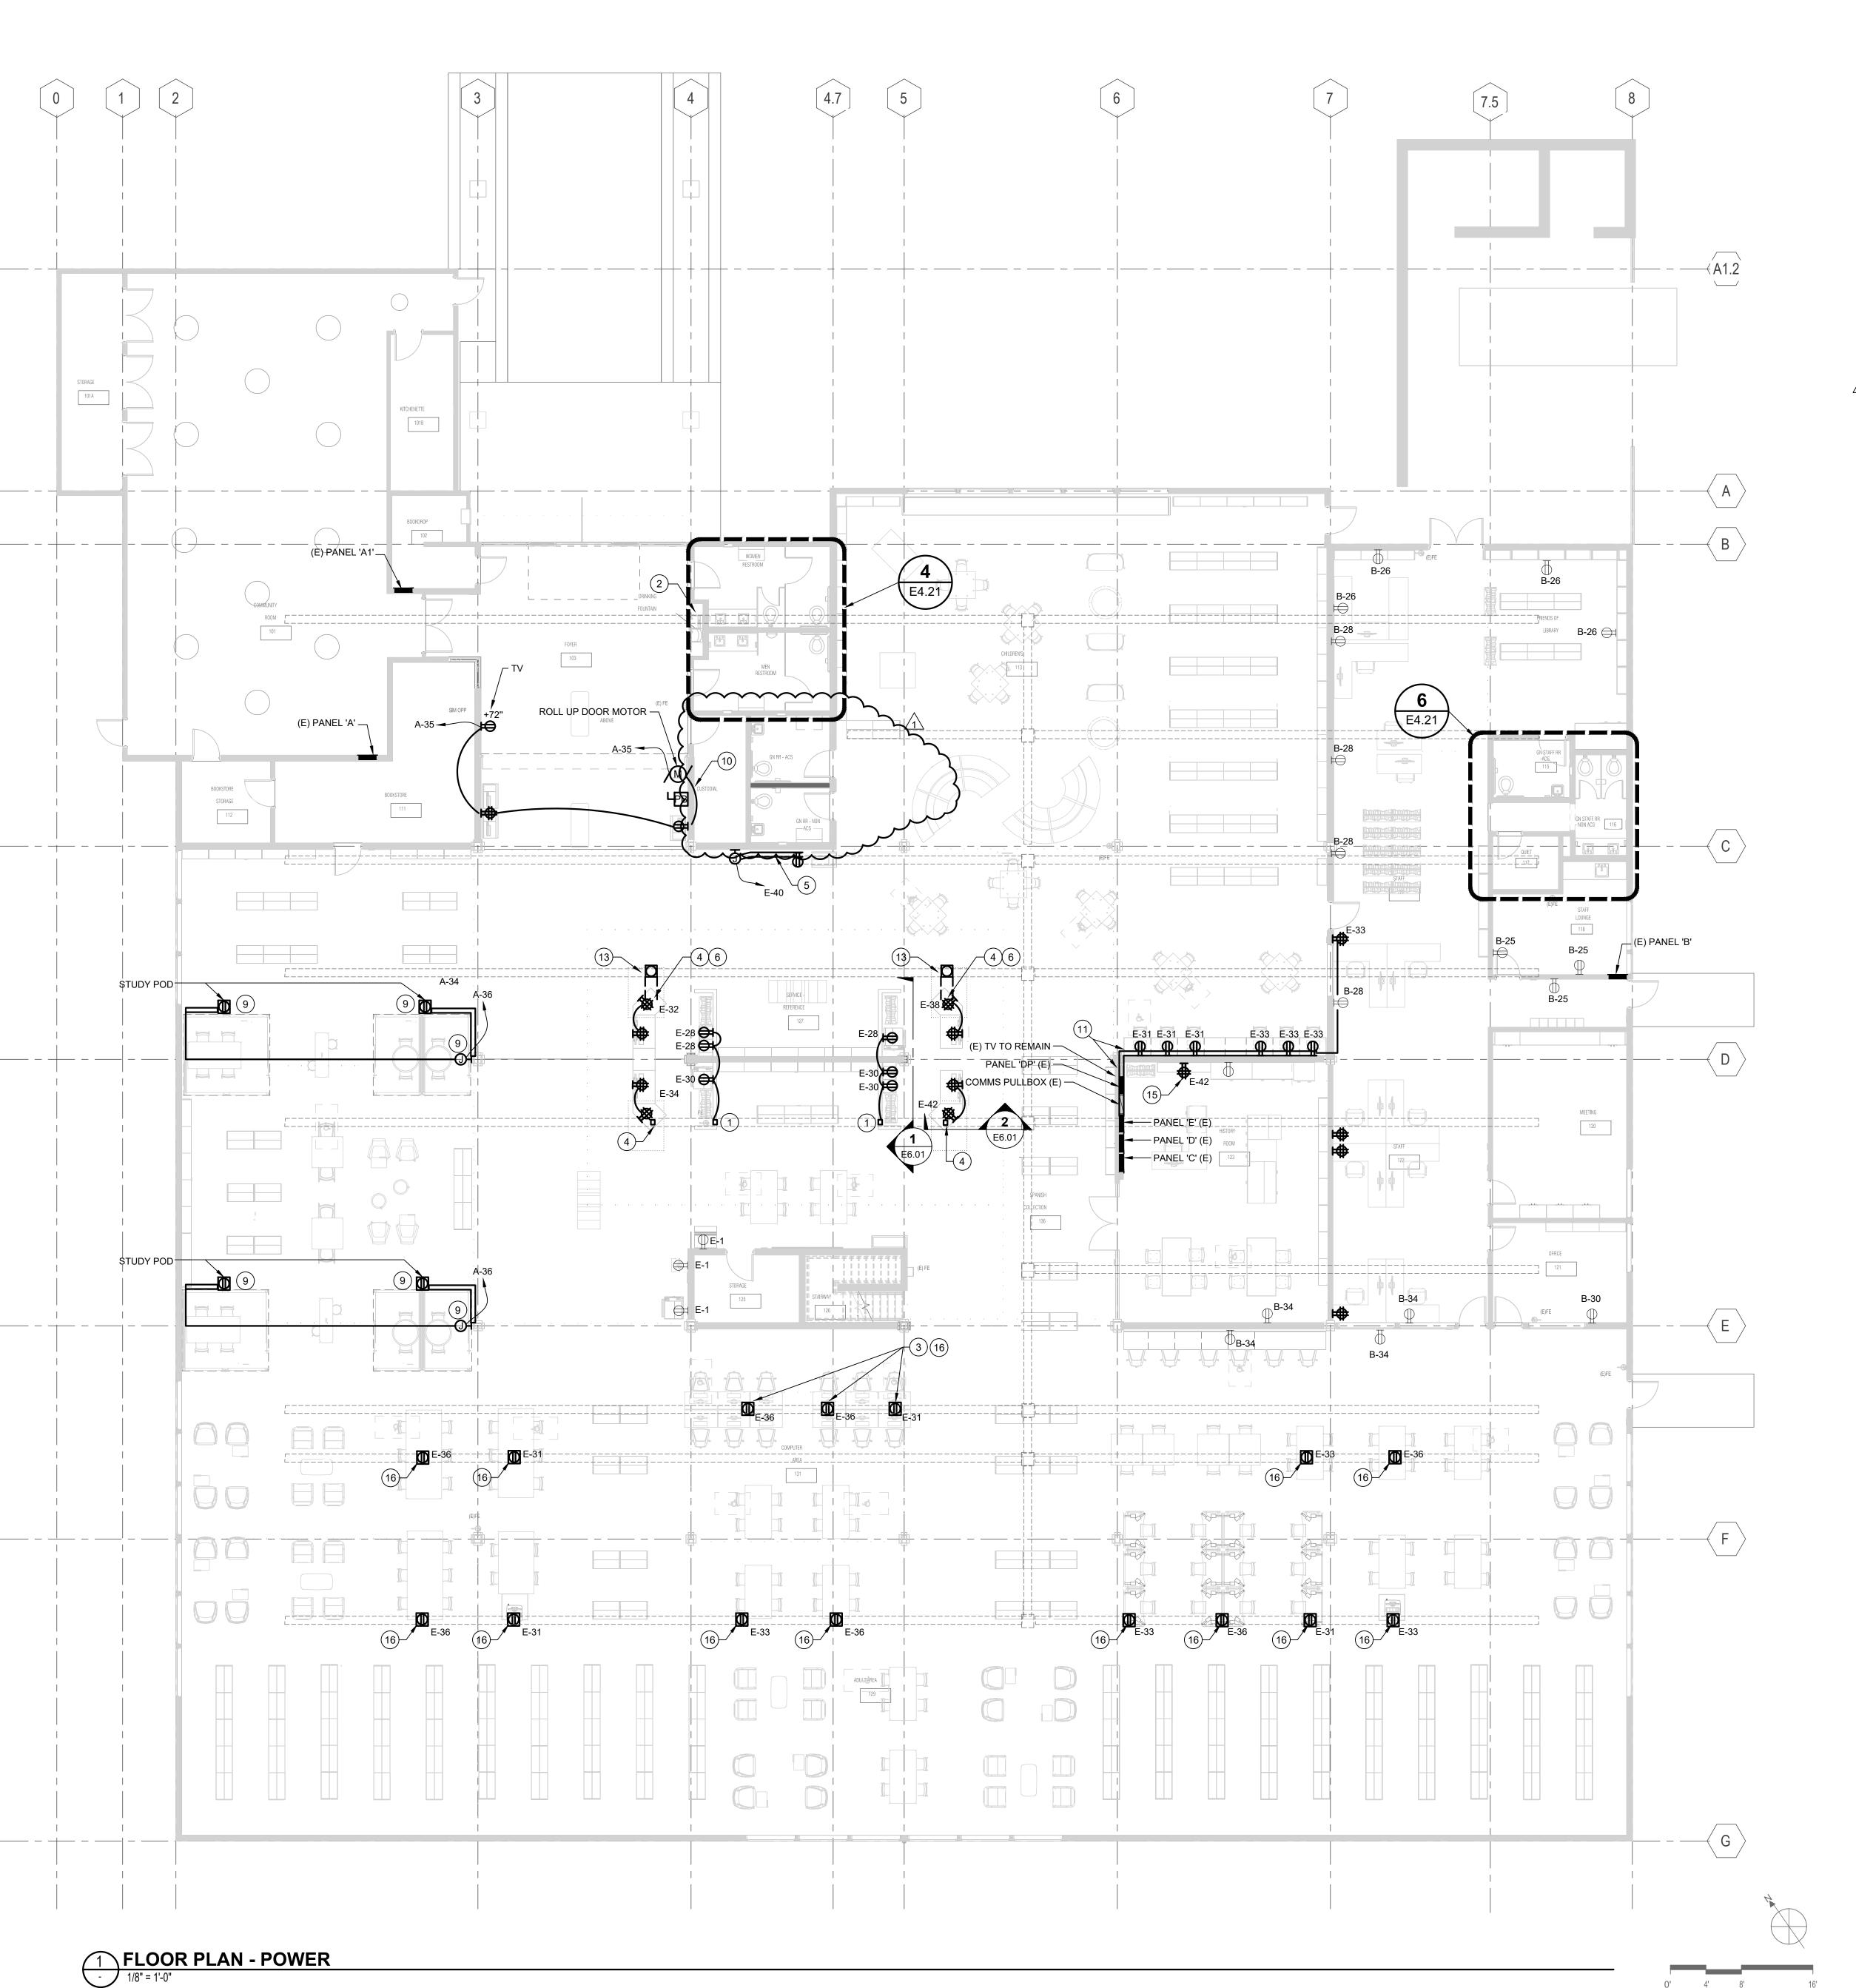

- 1 STUB CONDUIT UP WITHIN PARTIAL HEIGHT WALL AND ROUTE TO FLUSH-MOUNTED RECEPTACLES. SEE DETAIL 1/E6.01 FOR REQUIREMENTS.
- MOUNT RECEPTACLE ON WALL AND WITHIN VERTICAL FOOTPRINT ON DRINKING FOUNTAIN COORDINATE LOCATION WITH PLUMBING CONTRACTOR AND WITH FINAL LOCATION OF DRINKING FOUNTAIN IN FIELD.
- RELOCATE EXISTING FLOOR RECEPTACLES AS REQUIRED TO SERVE NEW COMPUTER AREA FLOOR PLAN. PROVIDE COVER PLATE OR CONDUIT KNOCKOUT PLUG AS REQUIRED.
- (4) STUB CONDUIT UP WITHIN SERVICE DESK AND ROUTE TO RECEPTACLES. SEE DETAIL 1/E6.01 FOR
- REQUIREMENTS.

 (5) PROVIDE SINGLE CHANNEL, SURFACE MOUNTED, ALUMINUM RACEWAY FROM JUNCTION BOX TO
- LOCATION SHOWN. PROVIDE DUPLEX RECEPTACLE IN RACEWAY. VERIFY EXISTING HOMERUN TO JUNCTION BOX.
- 6 INTERCEPT AND EXTEND EXISTING POWER AND DATA RACEWAY TO LOCATION SHOWN. TRENCH PROVIDED BY A SEPARATE DIVISION.
- (7) NOT USED.


8 NOT USED.

ROUTE CONDUIT FROM TRUSS-MOUNTED JUNCTION BOX (CONTAINING THE HOMERUN), ALONG TRUSS THAT'S OVER THE STUDY POD, DOWN THE COLUMN BETWEEN THE COLUMN AND STUDY POD, AND TRANSITION TO FLOOR-MOUNTED RACEWAY. TERMINATE FLOOR-MOUNTED RACEWAY IN FRONT OF STUDY POD POINT OF CONNECTION. SEE DETAILS. PROVIDE GFCI CIRCUIT BREAKER AT PANEL. PROVIDE P-TOUCH LABEL WITH THE FOLLOWING INFORMATION:
MINIMUM CURRENT: 12 AMPS
MAXIMUM VOLTAGE: 120 VAC MAX

- RE-USE EXISTING CONDUIT PATHWAY FOR CONTROL WIRING CONNECTION FROM ROLL-UP DOOR MOTOR TO KEY SWITCH. PROVIDE CONTROL WIRING AS REQUIRED.
- PROVIDE CONDUIT FROM PANEL 'E' AND STUB OUT 24" ABOVE TOP OF PANEL AND TRANSITION TO SURFACE MOUNTED RACEWAY. ROUTE RACEWAY HORIZONTALLY ACROSS WALL. PROVIDE CONDUIT PENETRATION OF WALL TO CHILDREN'S AREA, VERTICALLY ROUTE SURFACE MOUNTED RACEWAY DOWN TO HORIZONTAL, DUAL CHANNEL RACEWAY MOUNTED +18 A.F.F. TO BOTTOM OF RACEWAY.
- (12) NOT USED.
- (13) REMOVE EXISTING POWER AND DATA WIRING, TRENCH CUTTING AND RACEWAY CUTTING TO INSTALL FLOORBOX.
- (14) NOT USED.
- (15) SURFACE MOUNT QUADRAPLEX RECEPTACLE.
- PROVIDE RECEPTACLE MONUMENT AT LOCATION SHOWN. COORDINATE RECEPTACLE LOCATION WITH EXISTING POWER CHANNEL IN EXISTING IN-FLOOR WIREWAY. SECURE TO TOP OF RACEWAY AND PROVIDE REQUIRED PENETRATIONS INTO WIREWAY.

& TAM
ARCHITECTS

729 Heinz Avenue Berkeley, CA 94710 tel 510.542.2200 fax 510.542.2201

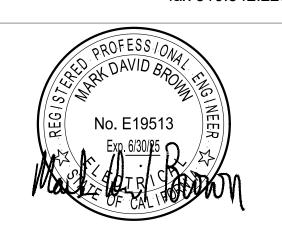



E g&b@gb—eng.com

PROJECT TITLE

SONOMA COUNTY
PETALUMA
REGIONAL
LIBRARY
RENOVATION
PROJECT NO.
10-19

100 FAIRGROUNDS DRIVE PETALUMA, CA 94952

PERMIT SET

SSUE DATE

N&T JOB NUMBER

DATE DESC

1 1/22/2024 RESUBMITTAL

REVIEWED FOR CODE COMPLIANCE

05/03/2024

Shums Coda Associates

SHEET TITLE

── (E) REMOTE BALLAST

(E) PANEL 'DS'


FLOOR PLAN - 1ST FLOOR AND MEZZANINE - POWER

SHEET NUMBER

E2.31

ROVALS

2 MEZZANINE - FLOOR PLAN
1/8" = 1'-0"

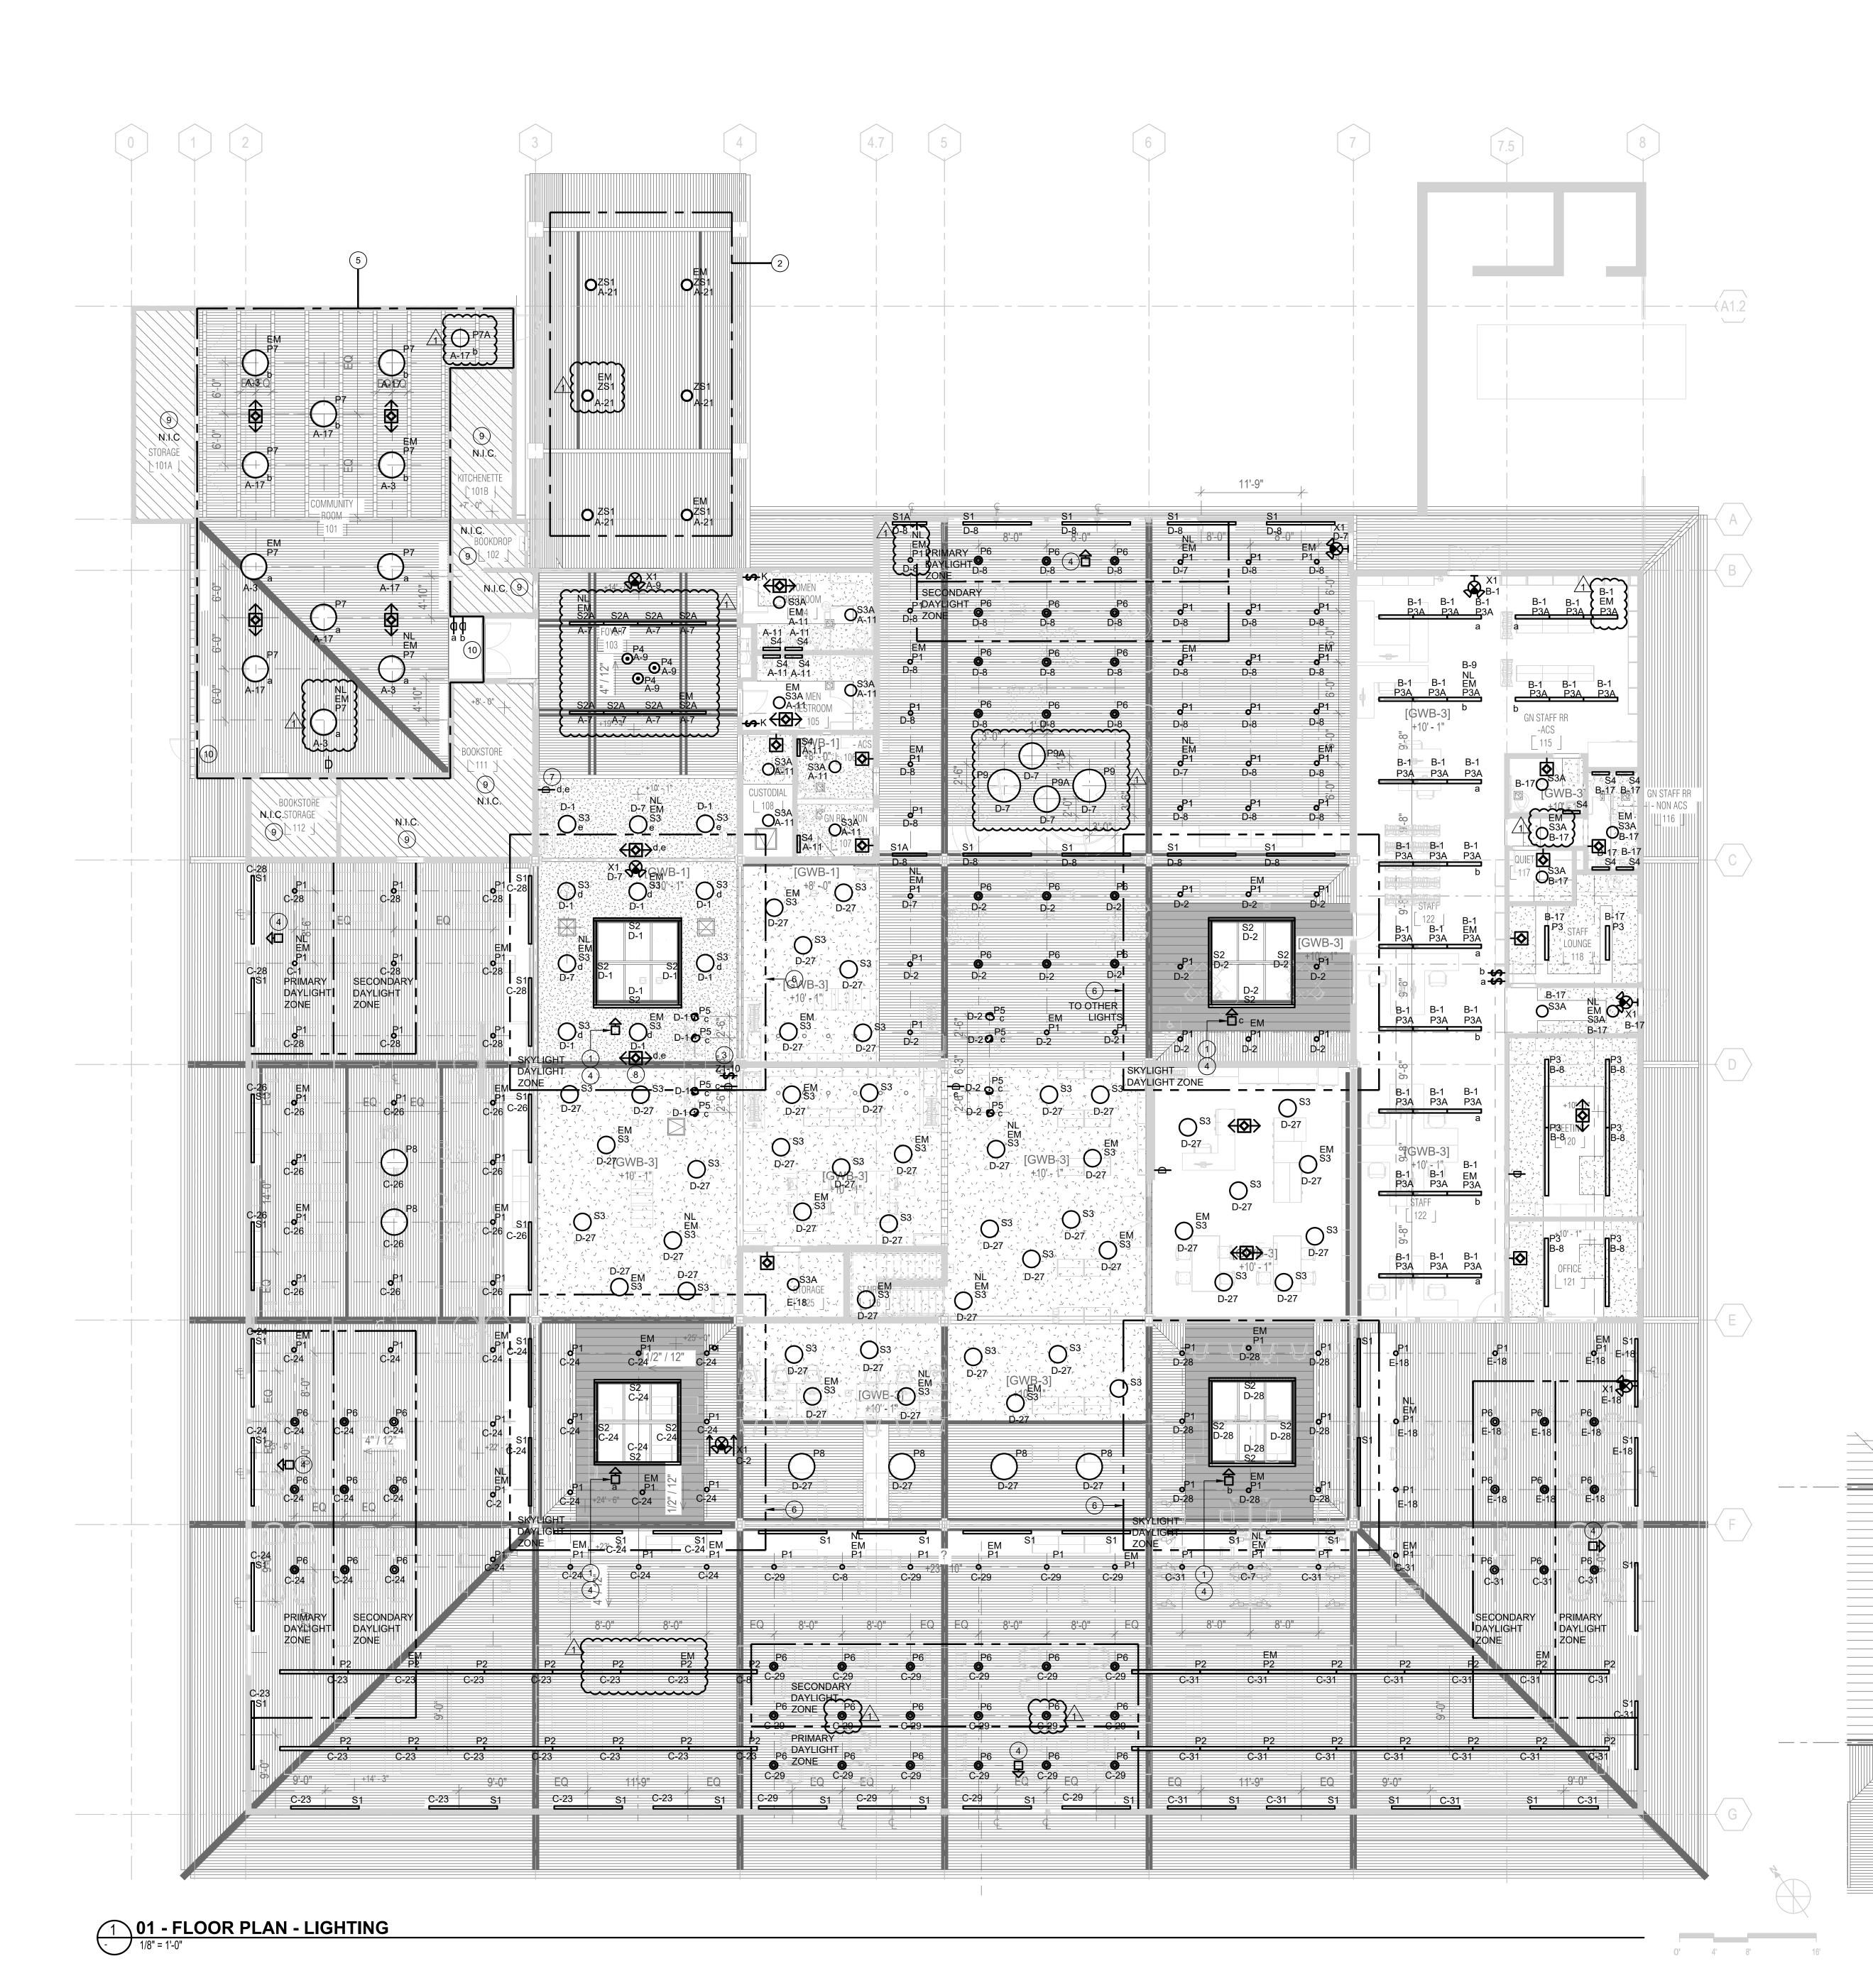

GENERAL NOTES:

- A. SWITCHES TO BE WHITE THROUGHOUT EXCEPT WHEN ON A WOOD WALL. A SWITCH ON A WOOD WALL SHOULD MATCH THE FINISH OF THE WALL AS CLOSELY AS POSSIBLE
- B. PROVIDE SEISMIC RETRAINTS TO PENDANT FIXTURES THAT CANNOT SWING AT 45 DEGREE WITHOUT HITTING ANOTHER OBJECT OR STRUCTURE/WALL.
- C. PROVIDE DIMMING OR ON/OFF CONTROLS PER FIXTURE TYPES PER DESIGN. FIELD VERIFY EXISTING WIRING/CIRCUITING AND PROVIDE DIMMING RELAYS AS REQUIRED. DESIGN INTENT CIRCUITING SHOWN PER AVAILABLE AS-BUILT DOCUMENTS.

SHEET NOTES:

- PROVIDE NEW WIRELESS DAYLIGHTING SENSOR (USE LUTRON VIVE "LRFZ" SERIES SENSOR). PROVIDE A POW PAK WIRELESS RELAY MODULE AS REQUIRED. FIELD VERIFY LOCATION. WIRE IN-SERIES WITH EXISTING CIRCUIT HOMERUN TO TIMECLOCK.
- 2 ALL TYPE ZS1 FIXTURES TO BE ADDED ONLY IF ADD ALTERNATE #2 IS APPROVED.
- 3 PROVIDE LCP OVERRIDE CONTROL SWITCH FOR 10 ZONES. REFER TO ZONE LEGEND BELOW.
- 4 SENSOR TO AUTOMATICALLY DIM NEW LIGHTS DOWN (INTEGRAL SENSOR AND DIMMING CONTROL) IN THE DAYLIT ZONE WHEN DAYLIGHT IS GREATER THAN 150% OF GENERAL LIGHTING.
- 5 LIGHTING IN COMMUNITY ROOM TO BE ADDED ONLY IF ADD ALTERNATE #3 IS APPROVED.
- 6 DAYLIGHTING ZONE SKYLIGHT. COORDINATE PROGRAMMING OF DAYLIGHTING SENSOR WITH CONTROLS VENDOR.
- 7 NEW WIRELESS DIMMER CONTORL (USE LUTRON VIVE "PICO" CONTROLLER 3-BUTTON WITH RAISE/LOWER).
- NEW WIRELESS OCCUPANCY SENSOR (USE LUTRON VIVE "LRF2" SERIES SENSOR). PROVIDE POW PACK WIRELESS RELAY
- MODULE AS REQUIRED. FIELD VERIFY LOCATION.

 9 NO LIGHTING/LIGHTING CONTROL WORK IN THIS AREA.

9) NO LIGHTING/LIGHTING CONTROL WORK IN THIS AREA 10 EXISTING EXIT SIGN TO REMAIN.

NEW EM LIGHTING AND CONTROLS NOTES:

- N1. PROVIDE NEW TIMECLOCK RELAY PANEL WITH OVERRIDE SWITCHES FOR THE MAIN LIBRARY LIGHTING. LOCATE OVERRIDE CONTROLS AT THE EXISTING PANELS LOCATIONS (TO REPLACE THE CURRENT OVERRIDE SWITCHES).
- N2. PROVIDE LIBRARY LUMINAIRES IN DAYLIT ZONES WITH INTEGRAL DAYLIT SENSORS.
- N3 PROVIDE 90 MIN. INTEGRAL BATTERY BACK UP TO LUMINAIRES IN PATH OF EGRESS (CHECK THAT CIRCUITS ARE NOT BEING CONTROLLED AND POWER IS ON 24x7)
- N4 PROVIDE INTEGRAL DAYLIT SENSOR TO THE ENTRY CANOPY LIGHTS
- N5 PROVIDE NEW EXIT SIGNS (TO REPLACE EXISTING) WITH INTEGRAL BATTERY BACK UP.
- N6 PROVIDE INTEGRAL BATTERY BACK UP TO LIGHTS AT EGRESS PATHWAYS

LCP OVERRIDE SWITCH CONTROL ZONE LEGEND:

ZONE #1 - ALL CEILING UPLIGHTS, TYPE S1.

ZONE #2 - ALL SKYLIGHT GRAZERS, TYPE S2.

ZONE #3 - GENERAL LIGHTING IN MEDIA AREA, TYPE P1

ZONE #4 - GENERAL LIGHTING IN TEEN AREA, TYPES P1, P6 AND P8


ZONE #5 - GENERAL LIGHTING IN ADULT AREA, TYPES P1 AND P6

ZONE #6 - GENERAL LIGHTING IN BOOKSTACKS, TYPE P2

ZONE #7 - GENERAL LIGHTING IN CHILDREN'S AREA, TYPES P1, P6, P9 AND P9A


ZONE #8 - GENERAL LIGHTING IN BAYS WITH SKYLIGHT, TYPE P1

ZONE #9 - GENERAL LIGHTING IN LOW CEILING AREA, TYPE S3

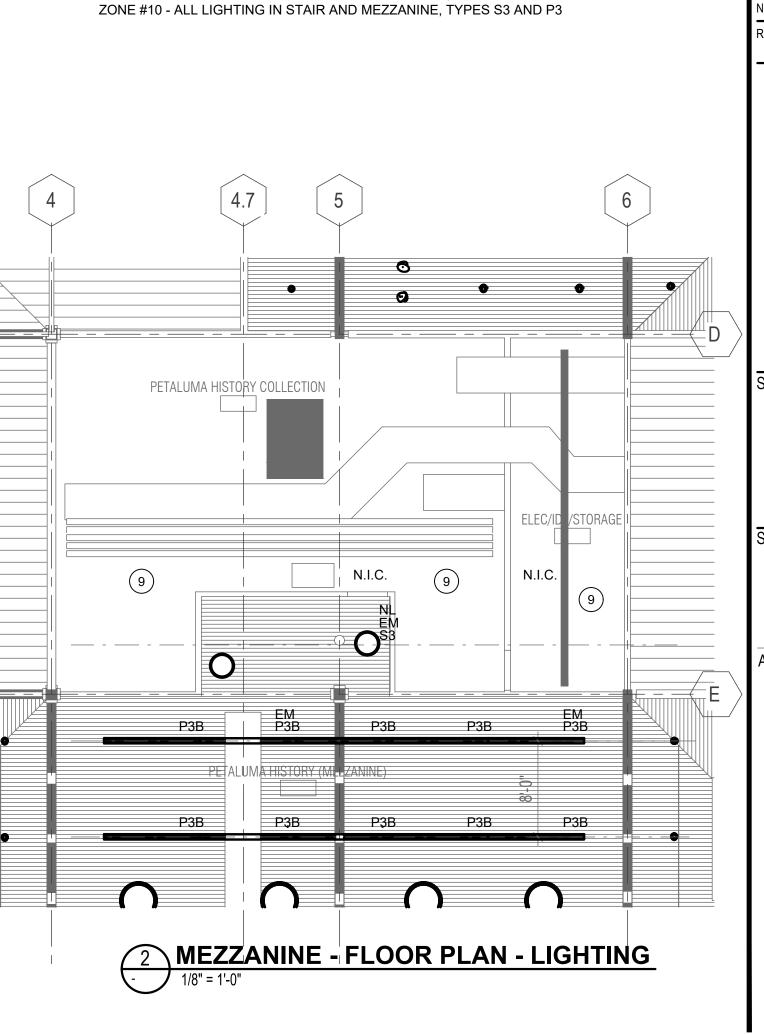

NOLL & TAM ARCHITECTS

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SSUE DATE 11/2
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SHEET TITLE

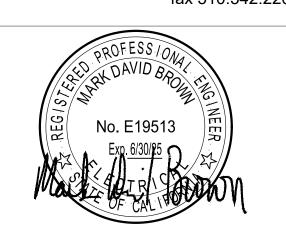
FLOOR PLAN - 1ST FLOOR AND MEZZANINE - LIGHTING

SHEET NUMBER

E2.41

APPROVALS

.ogin: DAN EILER Drawing File:NAT02203zE241.dwg Plotting Date: 1/24/2024 12:43 PM

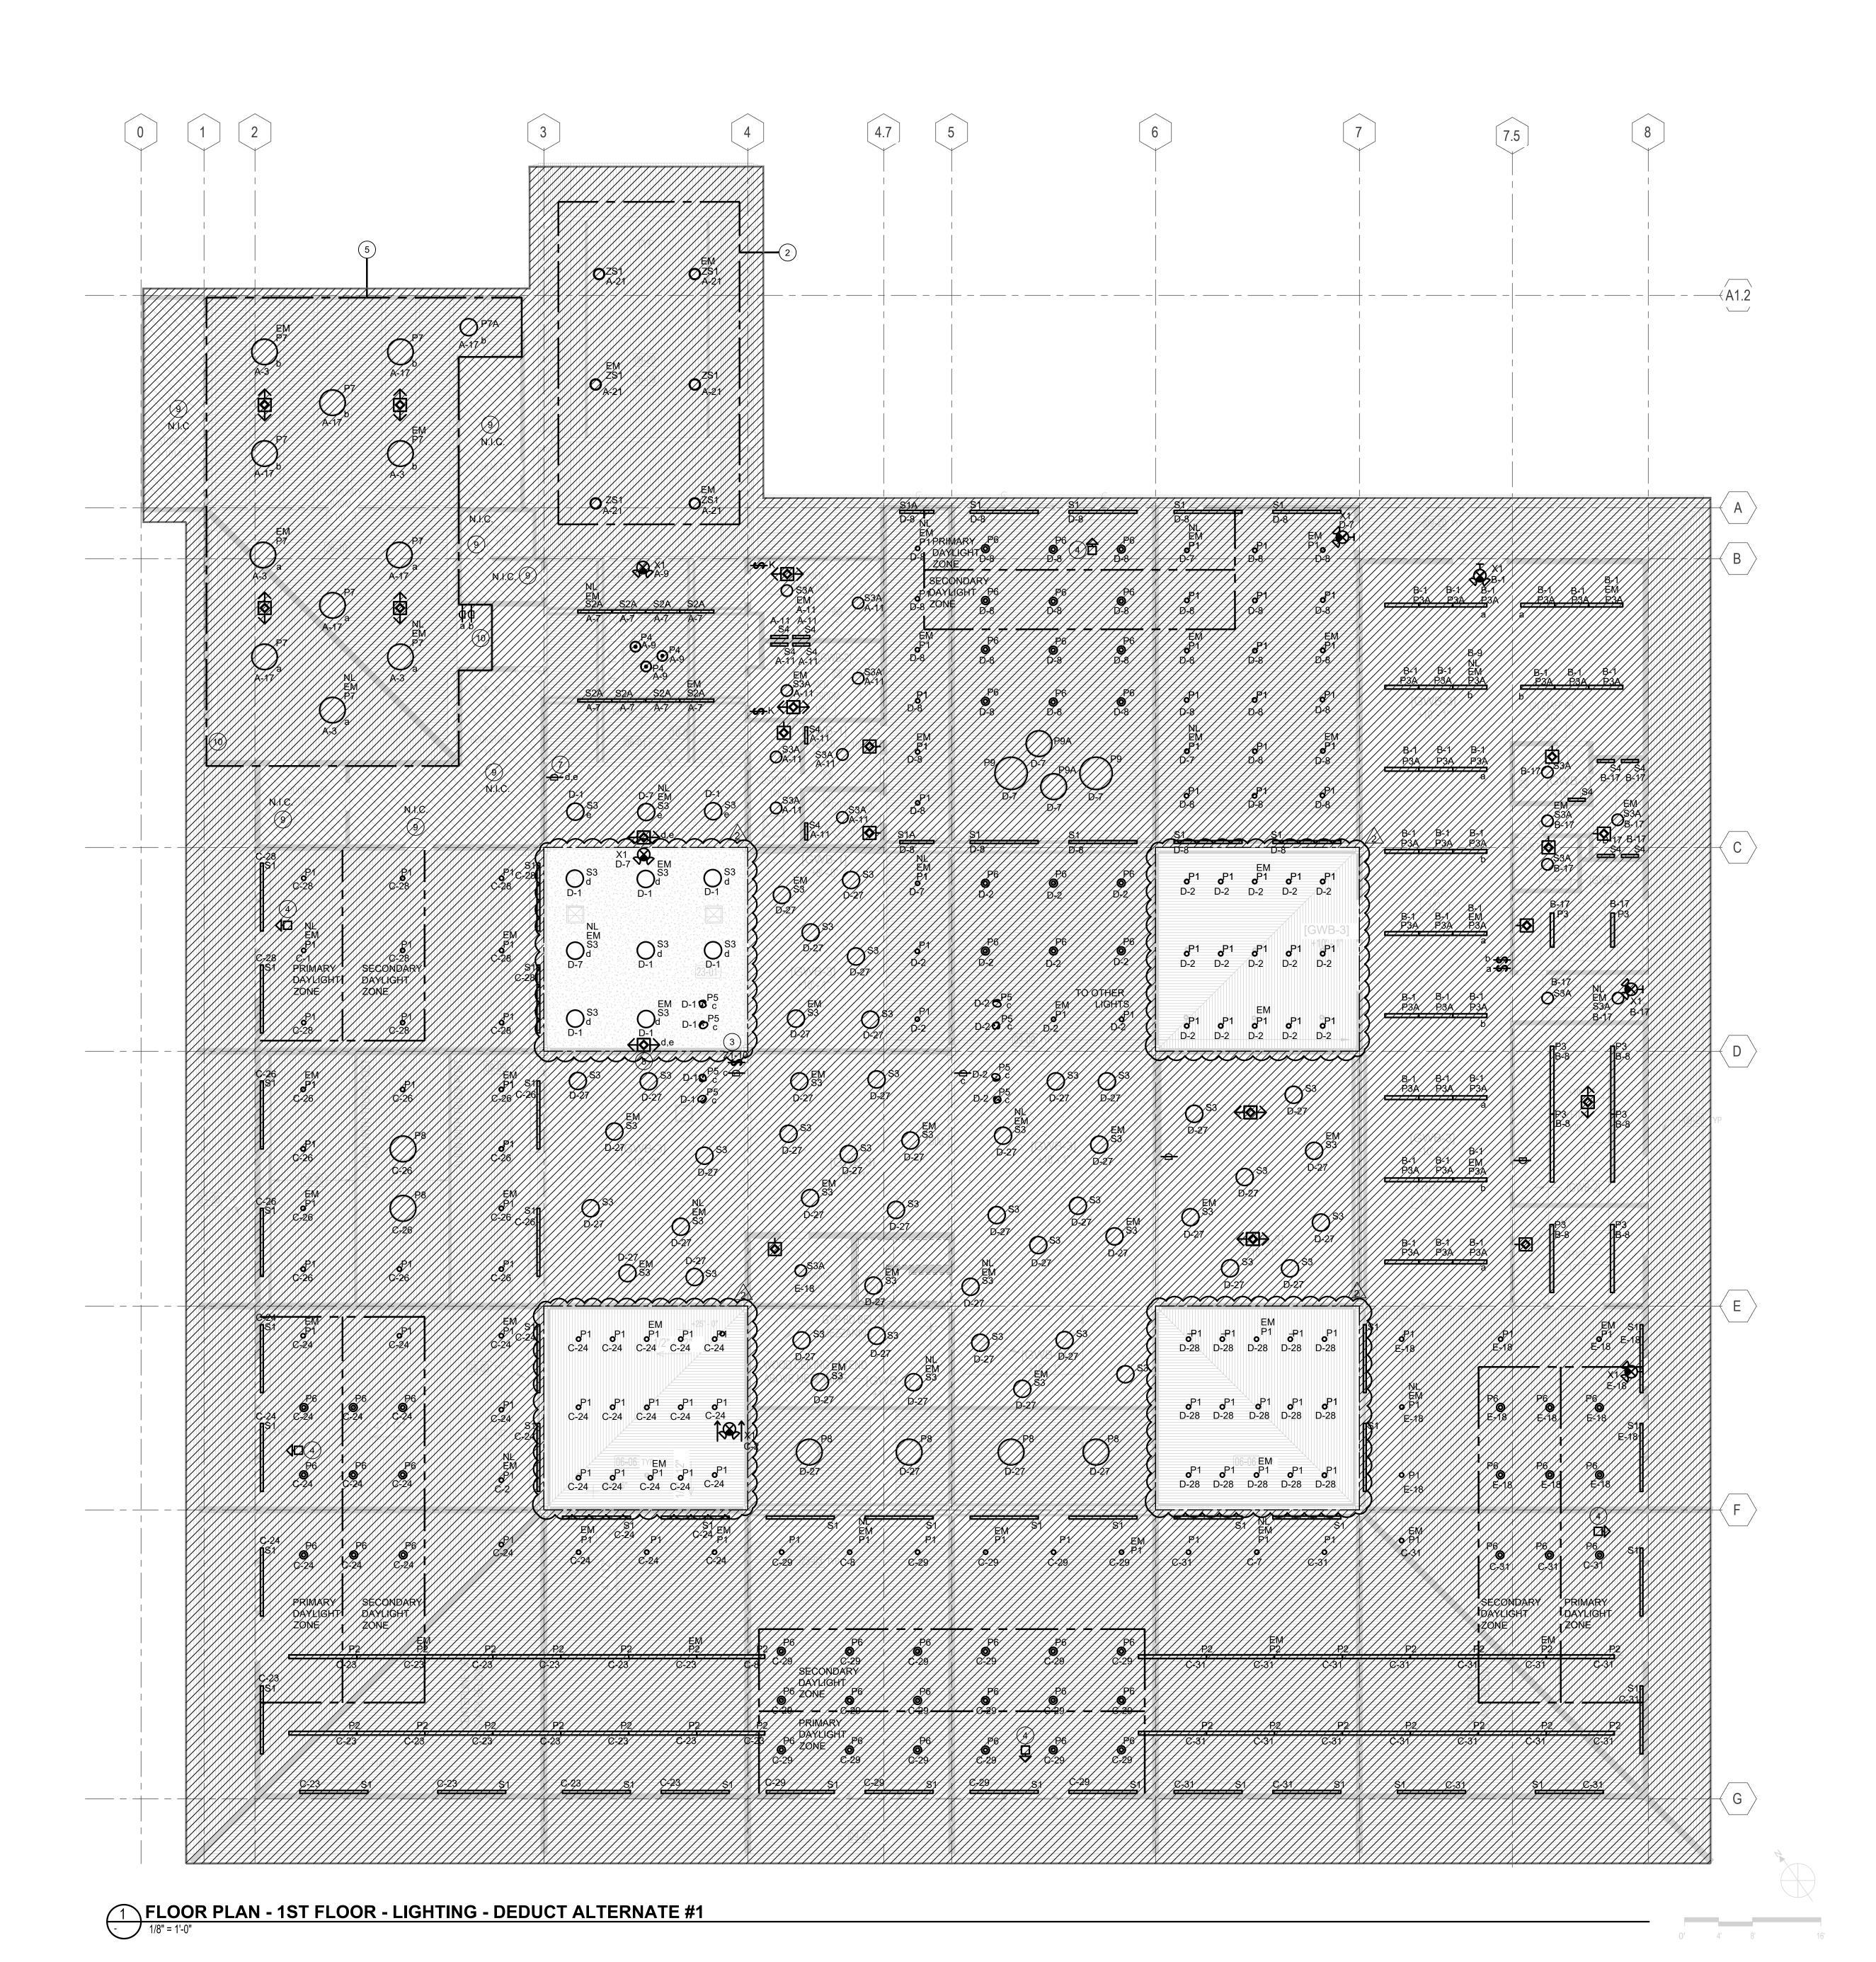

GENERAL NOTES:

- A. SWITCHES TO BE WHITE THROUGHOUT EXCEPT WHEN ON A WOOD WALL. A SWITCH ON A WOOD WALL SHOULD MATCH THE FINISH OF THE WALL AS CLOSELY AS POSSIBLE
- B. PROVIDE SEISMIC RETRAINTS TO PENDANT FIXTURES THAT CANNOT SWING AT 45 DEGREE WITHOUT HITTING ANOTHER OBJECT OR STRUCTURE/WALL.
- C. PROVIDE DIMMING OR ON/OFF CONTROLS PER FIXTURE TYPES PER DESIGN. FIELD VERIFY EXISTING WIRING/CIRCUITING AND PROVIDE DIMMING RELAYS AS REQUIRED. DESIGN INTENT CIRCUITING SHOWN PER AVAILABLE AS-BUILT DOCUMENTS.
- D. THIS IS AN ALTERNATE LIGHTING PLAN ONLY FOR THE BAYS THAT ARE NOT SHADED. ALL OTHER FIXTURES AND CONTROLS IN ALL OTHER AREAS TO BE THE SAME AS THAT SHOWN ON SHEET E2.41.

SHEET NOTES:

NOT USED. 2

- 2 ALL TYPE ZS1 FIXTURES TO BE ADDED ONLY IF ADD ALTERNATE #2 IS APPROVED.
- PROVIDE LCP OVERRIDE CONTROL SWITCH FOR 10 ZONES.
 REFER TO ZONE LEGEND BELOW.
- 4 SENSOR TO AUTOMATICALLY DIM NEW LIGHTS DOWN (INTEGRAL SENSOR AND DIMMING CONTROL) IN THE DAYLIT ZONE WHEN DAYLIGHT IS GREATER THAN 150% OF GENERAL
- 5 LIGHTING IN COMMUNITY ROOM TO BE ADDED ONLY IF ADD ALTERNATE #3 IS APPROVED.

 6 NOT USED. 2
- 7 NEW WIRELESS DIMMER CONTORL (USE LUTRON VIVE "PICO" CONTROLLER 3-BUTTON WITH RAISE/LOWER).
- 8 NEW WIRELESS OCCUPANCY SENSOR (USE LUTRON VIVE "LRF2" SERIES SENSOR). PROVIDE POW PACK WIRELESS RELAY MODULE AS REQUIRED. FIELD VERIFY LOCATION.
- 9 NO LIGHTING/LIGHTING CONTROL WORK IN THIS AREA.
- (10) EXISTING EXIT SIGN TO REMAIN.

NEW EM LIGHTING AND CONTROLS NOTES:

- N1. PROVIDE NEW TIMECLOCK RELAY PANEL WITH OVERRI SWITCHES FOR THE MAIN LIBRARY LIGHTING. LOCATE OVERRIDE CONTROLS AT THE EXISTING PANELS LOCATIONS (TO REPLACE THE CURRENT OVERRIDE SWITCHES).
- N2. PROVIDE LIBRARY LUMINAIRES IN DAYLIT ZONES WITH INTEGRAL DAYLIT SENSORS.
- N3 PROVIDE 90 MIN. INTEGRAL BATTERY BACK UP TO LUMINAIRES IN PATH OF EGRESS (CHECK THAT CIRCUITS ARE NOT BEING CONTROLLED AND POWER IS ON 24x7)
- N4 PROVIDE INTEGRAL DAYLIT SENSOR TO THE ENTRY CANOPY LIGHTS
- N5 PROVIDE NEW EXIT SIGNS (TO REPLACE EXISTING) WITH INTEGRAL BATTERY BACK UP.
- N6 PROVIDE INTEGRAL BATTERY BACK UP TO LIGHTS AT EGRESS PATHWAYS

LCP OVERRIDE SWITCH CONTROL ZONE LEGEND:

ONE #1 - ALL CEILING UPLIGHTS, TYPE S1.

NE #2 - NOT USED ONE #3 - GENERAL LIGHTING IN MEDIA AREA, TYPE P1. ONE #4 - GENERAL LIGHTING IN TEEN AREA, TYPES P1, P6 AND P8. ONE #5 - GENERAL LIGHTING IN ADULT AREA, TYPES P1 AND P6.

ZONE #10 - ALL LIGHTING IN STAIR AND MEZZANINE, TYPES S3 AND P3.

ZONE #6 - GENERAL LIGHTING IN BOOKSTACKS, TYPE P2.


ZONE #7 - GENERAL LIGHTING IN CHILDREN'S AREA, TYPES P1, P6, P9 AND P9A

ZONE #8 - NOT USED

ZONE #9 - GENERAL LIGHTING IN LOW CEILING AREA, TYPE S3.

NOLL & TAM ARCHITECTS

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10-19

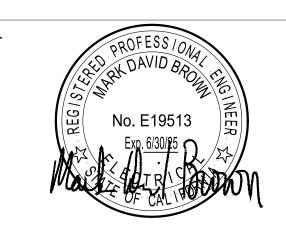100 FAIRGROUNDS DRIVE PETALUMA, CA 94952

PERMIT SET

SSUE DATE 11/20/202
N&T JOB NUMBER 2182

2 4/25/2024 RESUBMITTAL 2

REVIEWED FOR CODE COMPLIANC

05/03/2024

Shums Coda Associates

SHEET TITI


FLOOR PLAN – 1ST FLOOR - LIGHTING – DEDUCT ALTERNATE #1

HEET NUMBER

E2.41A

APPROVALS

ogin: DAN EILER rawing File:NAT02203zE241A.dwg lotting Date: 4/23/2024 10:18 AM

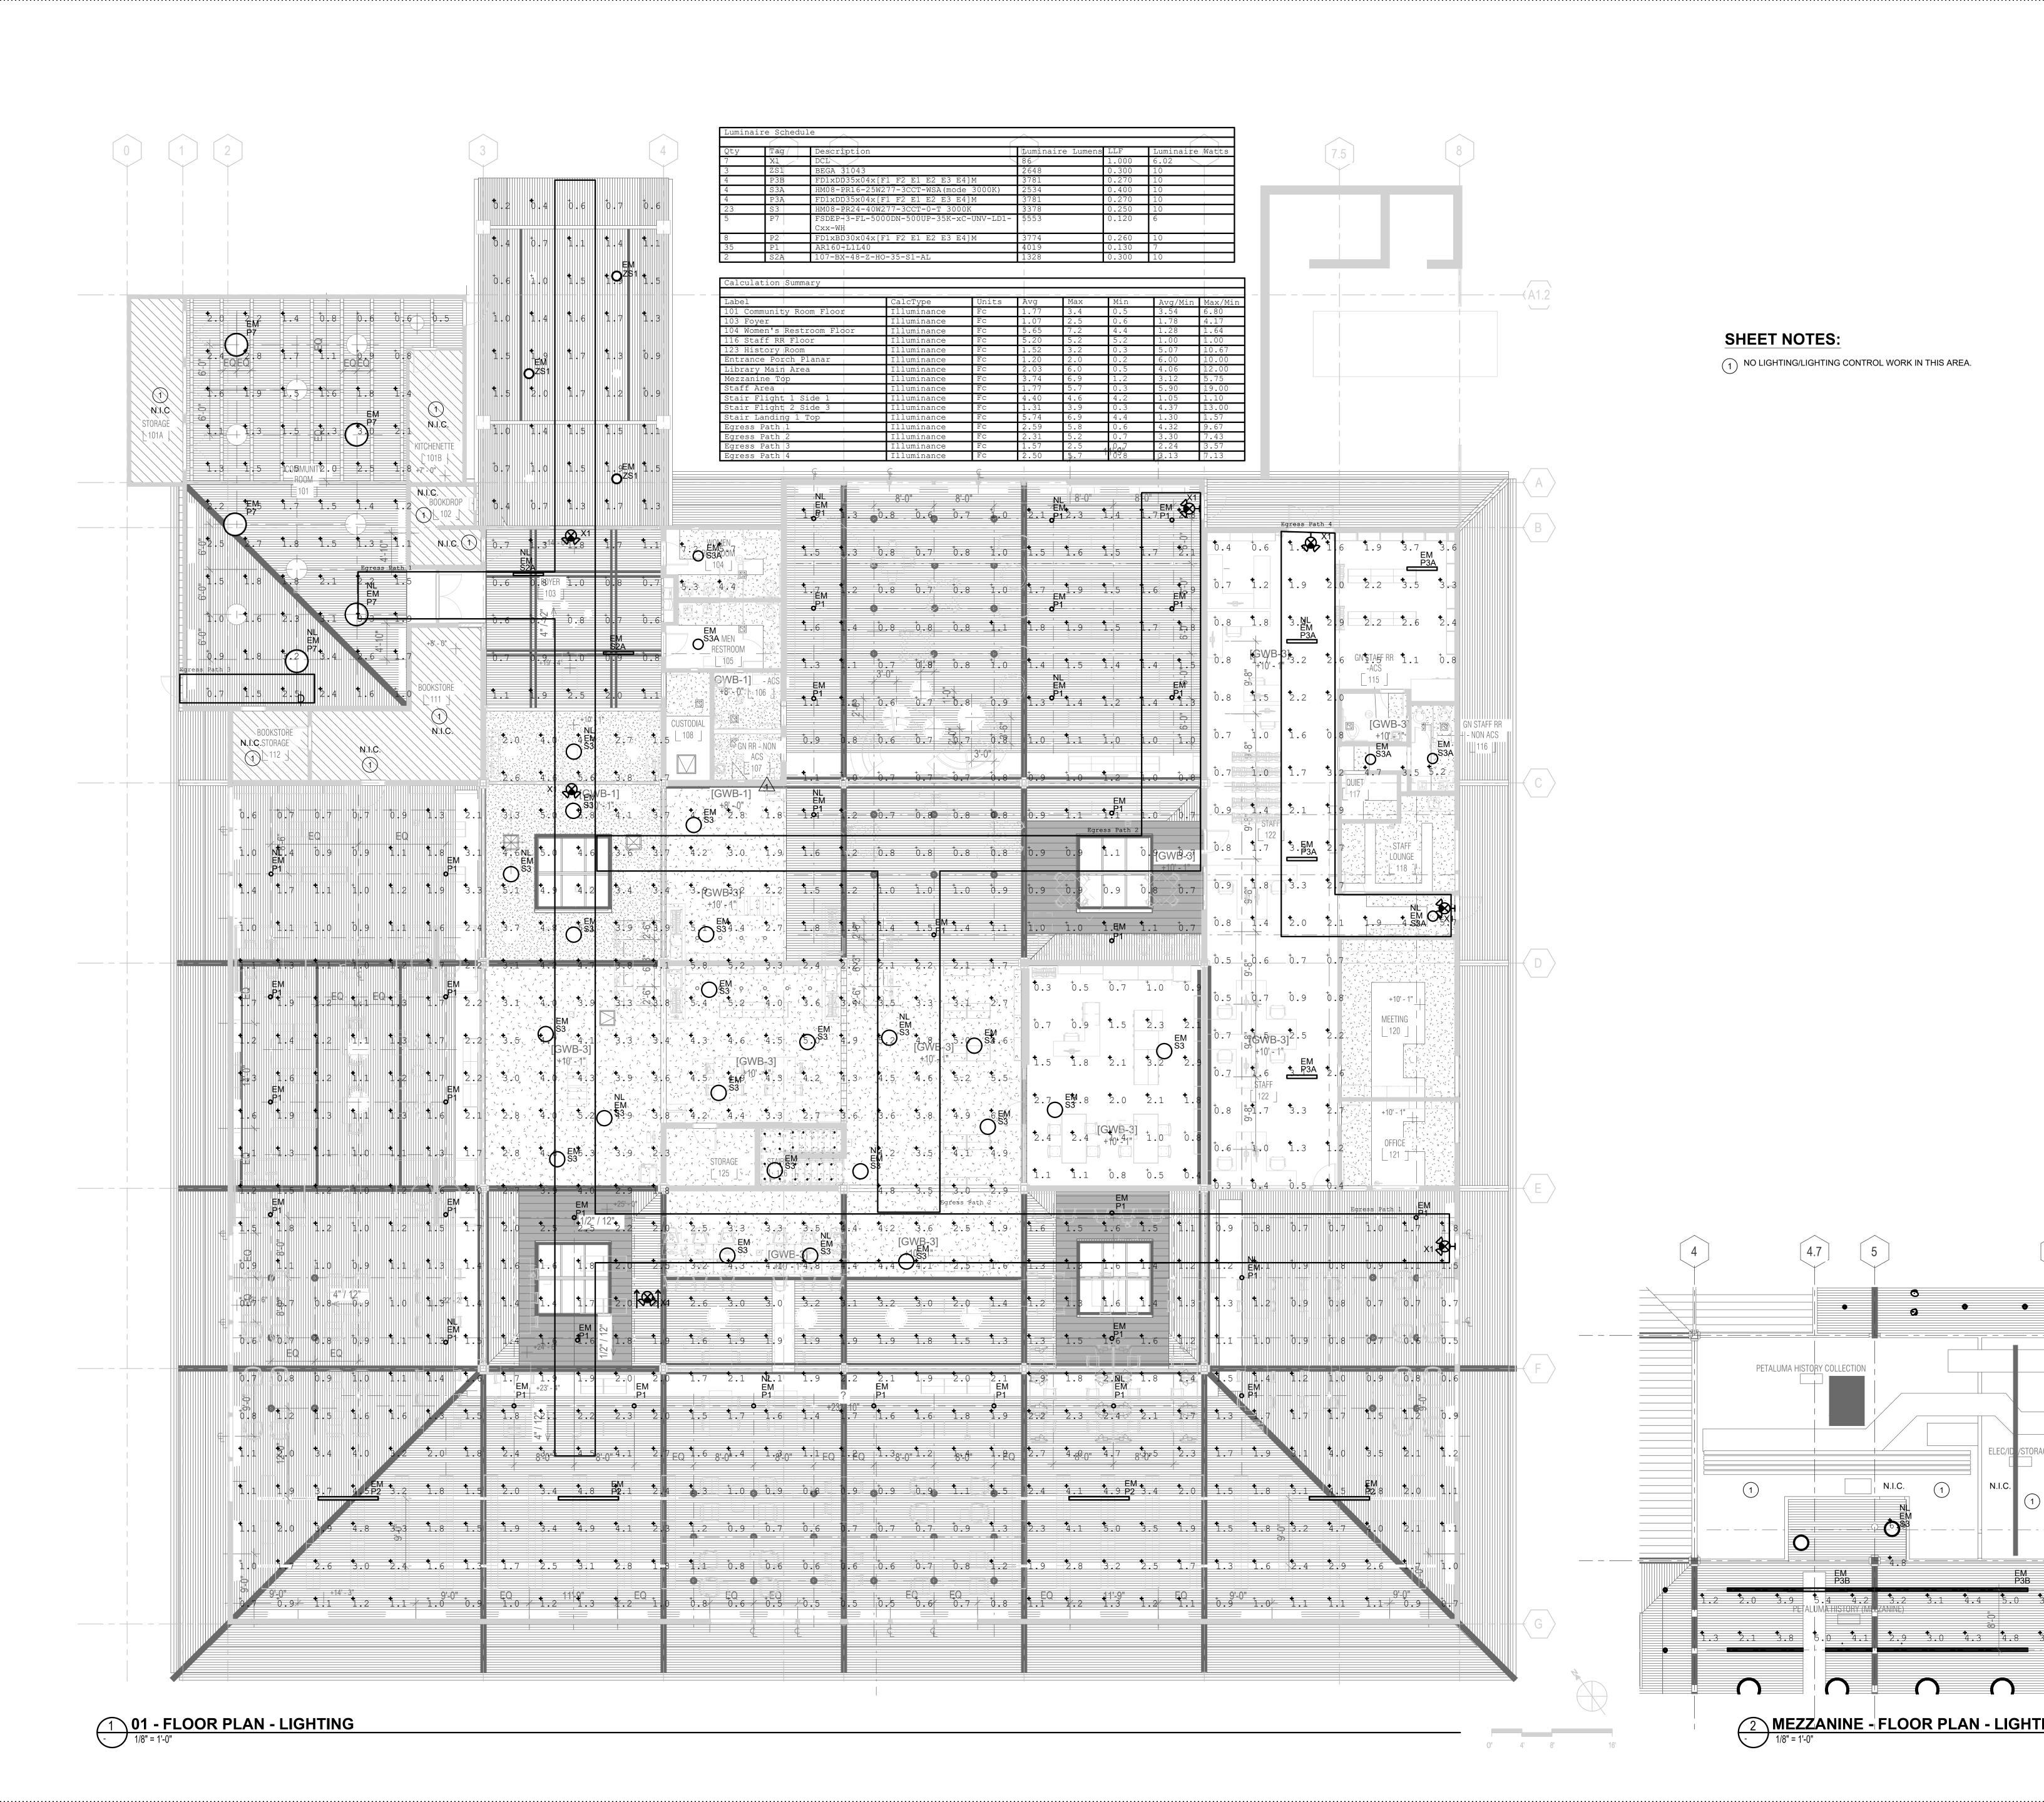



NO LIGHTING/LIGHTING CONTROL WORK IN THIS AREA

PETALUMA HISTORY COLLECTION

MEZZANINE - FLOOR PLAN - LIGHTING

1/8" = 1'-0"



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DESCRIPTION


1 1/22/2024 RESUBMITTAL

REVIEWED FOR CODE COMPLIANO 05/03/2024 Shums Coda Associates

FLOOR PLAN - 1ST FLOOR AND MEZZANINE - EM CALCULATIONS

SHEET NUMBER

E3.41

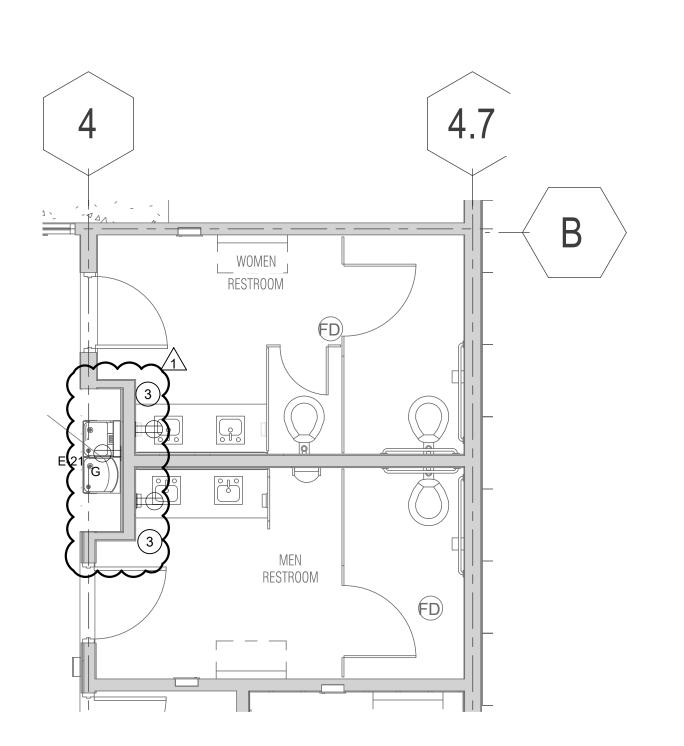

SAFE-OFF (E) ABOVE-CEILING WATER HEATER AS REQUIRED TO SUPPORT DEMO OF WALL. WATER HEATER IDENTIFIED ON AS-BUILTS. CONTRACTOR TO VERIFY IN THE FIELD. (2) RELOCATE (E) RECEPTACLE TO SUPPORT WALL DEMOLITION. ——— — r

SHEET NOTES:


LOCATION IN FIELD.


SEE DETAIL 6/- FOR FINAL LOCATION. COORDINATE FINAL


3 SAFE-OFF (E) RECEPTACLE TO SUPPORT INTERIOR SURFACE WORK. VERIFY (E) CIRCUIT NUMBER IN THE FIELD.

4 ENLARGED PUBLIC RESTROOMS
1/4" = 1'-0"

1 ENLARGED PUBLIC RESTROOMS (DEMO)

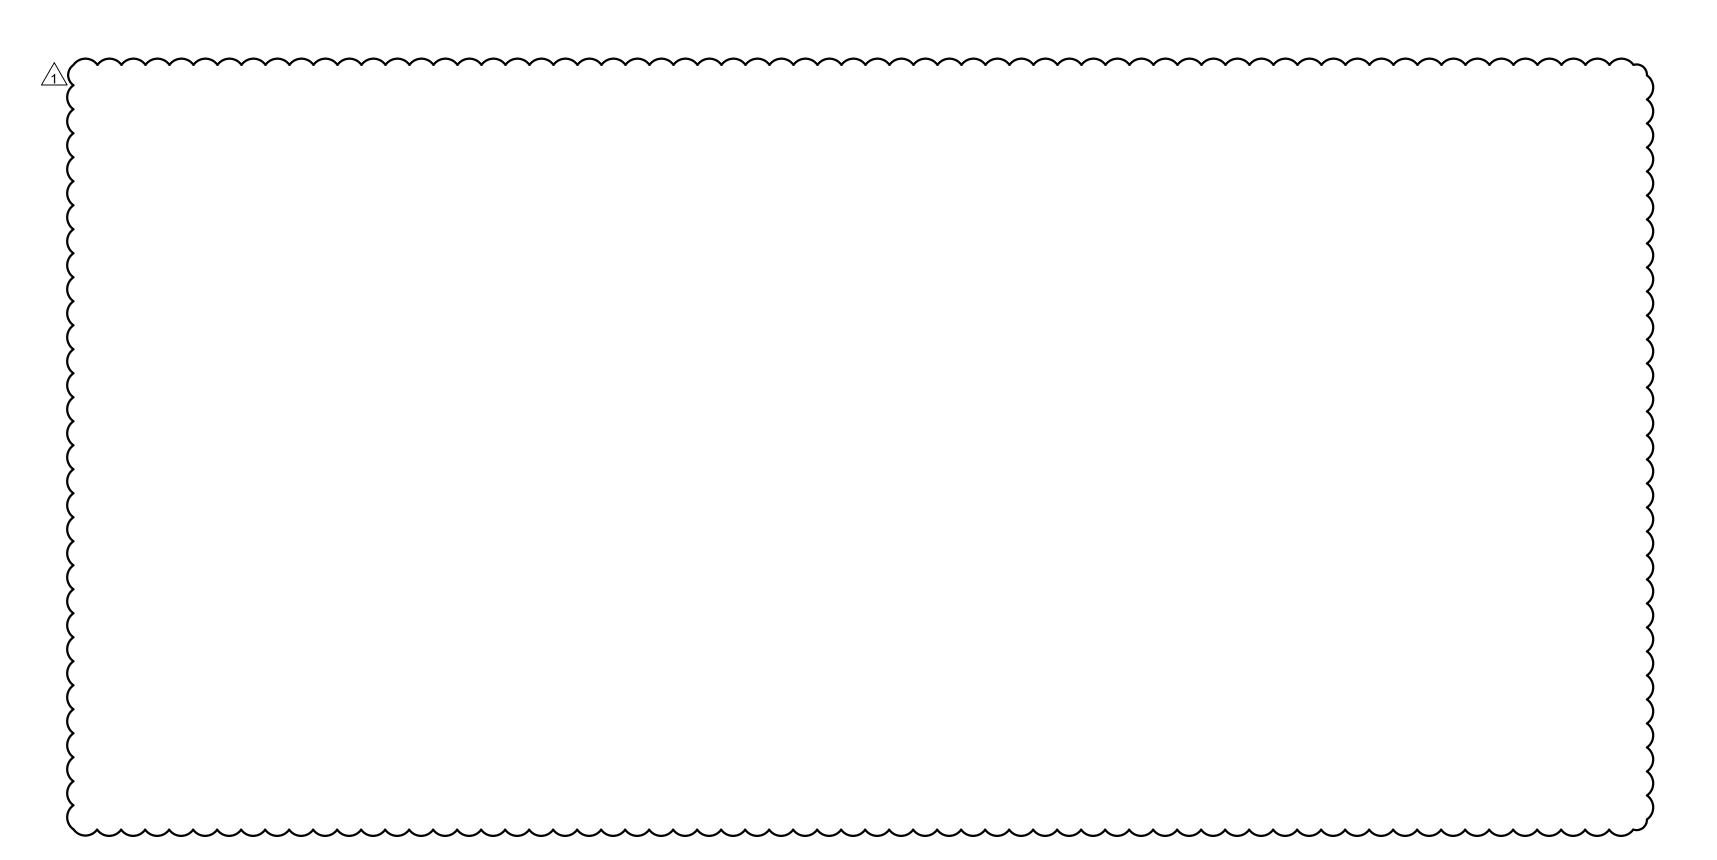


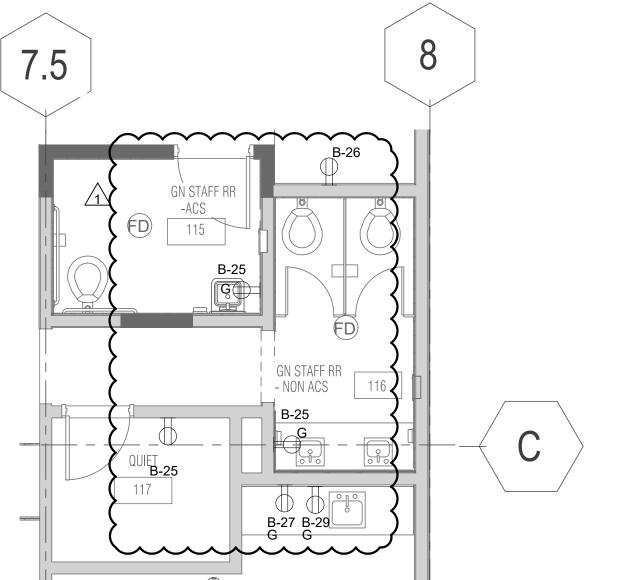

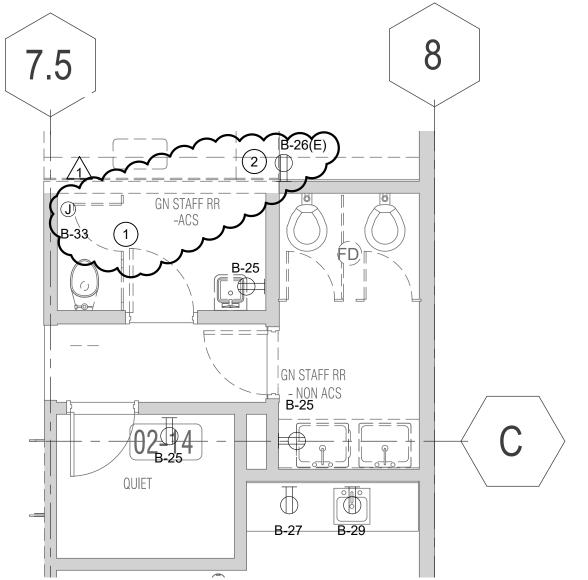


3 STAFF RESTROOM - (DEMO)

1/4" = 1'-0"

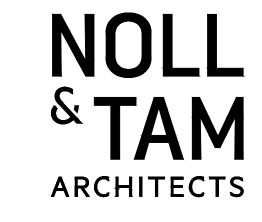

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ENLARGED PLANS -POWER AND LIGHTING

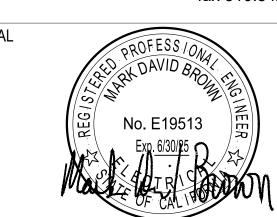SHEET NUMBER


E4.21

APPROVALS

6 STAFF RESTROOMS
1/4" = 1'-0"

PAN	EL: "A" (EXISTIN	G)									MIN. AIC = 22kA	
ENCLOSURE: NEMA 1		VOLTAGE:		120/208 BUS SIZ		ZE:	225	MLO:		Х	LOCATION: MEETING ROO	ом
MOUN'	TING: SFLUSH	PHASE/WIRE:		3/4	MCB S	IZE:		FEED THRU:			SERVED FROM: DP	
NOTE	DESCRIPTION	KEY	LOAD	BKR / POLE	CKT.	РН	CKT.	BKR / POLE	LOAD	KEY	DESCRIPTION	NOTE
9	EXISTING	R			1	A	2	50/3			PANEL A1	
	EXISTING	R			3	В	4				PANEL A1	
	EXISTING	R		20/1	5	C	6				PANEL A1	
	EXISTING	R		20/1	7	A	8	20/1		R	SPARE	
	EXISTING	R		20/1	9	В	10	20/1		R	SPARE	
	EXISTING	R		20/1	11	С	12	20/1		R	EXISTING	
	EXISTING	R		20/1	13	A	14	20/1		R	EXISTING	
	SPARE	R		20/1	15	В	16	20/1		R	EXISTING	
	SPARE	R	3	20/1	17	С	18	20/1		R	EXISTING	
	SPARE	R		20/1	19	A	20	20/1		R	EXISTING	
	SPARE	R		20/1	21	В	22	20/1		R	EXISTING	
	EXISTING	R		20/1	23	С	24	20/1		R	EXISTING	
	EXISTING	R		20/1	25	A	26	20/1		R	EXISTING	
	EXISTING	R		20/1	27	В	28	20/1		R	EXISTING	
	EXISTING	R		20/1	29	С	30	20/1		R	EXISTING	
	EXISTING	R		20/1	31	A	32	20/1		R	EXISTING	
	EXISTING	R		20/1	33	В	34	20/1	1200	R	STUDY POD	
	ROLL-UP DOOR-REC-RM103	R	1260	20/1	35	C	36	20/1	1200	R	STUDY POD	
	EXISTING	R		20/1	37	A	38				SPACE	
3	SPACE				39	В	40				SPACE	
	SPACE				41	С	42				SPACE	
SUB-	SPAE		(E)	VA				VA	(E)	SUB-	TOTAL (CONNECTED LOAD)
NOTE	S:						PHASE	"A" =	0.0	KVA		
							PHASE	"B" =	1.2	KVA		
1							PHASE	"C" =	2.5	KVA		
2							TOTAL	CONN.	(E)	KVA		
3							LO	ADS	(E)	AMPS		
4							DEN	MAND	3.7	KVA		
5							LOADS	(LINK)	10.2	AMPS		
6					2							

ENCLOSURE: NEMA 1		VOLTAGE: 120/208 BUS SI				Œ: 225	MLO:		x	LOCATION: STAFF AREA	
	TING: FLUSH	PHASE		3/4 MCB SIZE:			FEED T	HRU:		SERVED FROM: DP	
NOTE	1	KEY LOAD		BKR /	_	скт	+	LOAD	KEY	DESCRIPTION	NOTE
	DEGORII TION		VA	POLE	NO.	NO.	POLE	VA	1121	DEGGINII NON	
	NIGHT LIGHTS	R	•••	20/2	1	2	1.011	117		SPACE	
	NIGHT LIGHTS MERC VAP	R			3	4				SPACE	
	NIGHT LIGHTS MERC VAP	R		20/1	5	6	20/1		R	PLUGS READER/PRINTER	
	REC.	R		20/1	7	8	20/1		R	DUKANES PACS 21-24	
	LIMITED ACCESS STAFF PC	R		20/1	9	10	20/1		R	INTERCOM PANEL AC CONT	
	EXHAUST FAN ROOF	R		20/1	11	12	20/1		R	PLUG TEL BOARD	
	LIGHTS MEZZ & STORAGE	R		20/1	13	14	20/1		R	PLUGS	
	BATT CHARGER EM LIGHTS	R		20/1	15	16	20/1		R	XEROX	
	FIRE ALARM AC SHUTDOWN			20/1	17	18	20/1		R	LIGHT CIRCULATION DESK	
	HAND DRYERS RESTROOM	R		20/1	19	20	20/1		R	REF. COMPUTERS/PACS	
	HAND DRYERS RESTROOM	R		20/1	21	22	20/1		R	FLOOR PLUG - EAST READER	₹
	WATER CHILLER	R		20/1	23	24	20/1		R	FLOOR PLUG - CHILD AREA	Ì
	PCs ALCOVE #6	R		20/1	25	26	20/1		R	CIRC RECEPTACLE	
	PUBLIC PCs	R		20/1	27	28	20/1	1200	R	PRINTER/COPIER, SVC DSK	
	PCs ALCOVE #4 & #11	R		20/1	29	30	20/1	1200	R	PRINTER/COPIER, SVC DSK	1
1	DESK RM#119, REC RM 129	R	1600	20/1	31	32	20/1	1200	R	DESKTOP, REC	1
1	DESK RM#119, REC RM 129	R	1600	20/1	33	34	20/1	1200	R	DESKTOP, REC	1
	SPACE				35	36	20/1	1200	R	COMPUTER FURN-RM129	1
	EXISTING LOAD			50/3	37	38	20/1	1200	R	DESKTOP RM#113	1
	EXISTING LOAD			50/3	39	40	20/1	1000	R	JUNCTION BOX RM#107	1
	EXISTING LOAD			50/3	41	42	20/1	1200	R	DESKTOP RM#113	1
SUB-	TOTAL (CONNECTED LOAD)		(E)	VA			VA	(E)	SUB-	TOTAL (CONNECTED LOAD)	
NOTE	S:					PHAS	E "A" =	7.3	KVA		
	REMOVE AND INSTALL ANY	SDADE		DEVKE	90	PHAS	E "B" =	6.7	KVA		
	FROM PANEL 'C' AND PANEL				``	\rightarrow	E "C" =	6.2	KVA		
1	BREAKERS ARE:						L CONN.	(E)	KVA		
	PANEL 'C' : CB# 18, 26, 28, 3	ľ		DADS	(E)	AMPS					
	PANEL 'D' : CB# 17, 19, 28				ŀ	_	MAND	11.3	KVA		
2							S (LINK)	31.4	AMPS		
3							,==	91.7	, am Q		

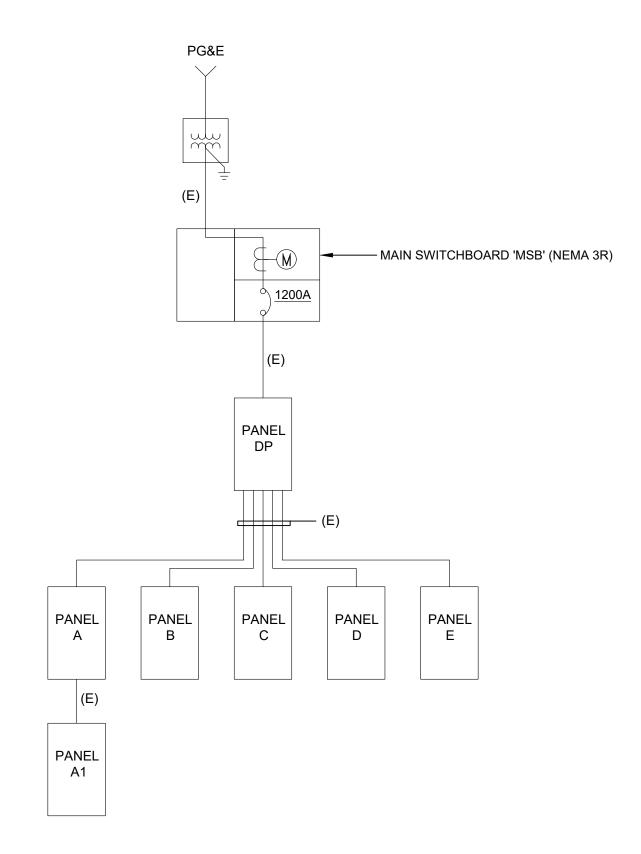


NOTE: (E) SINGLE LINE DIAGRAM SHOWN FOR REFERENCE ONLY





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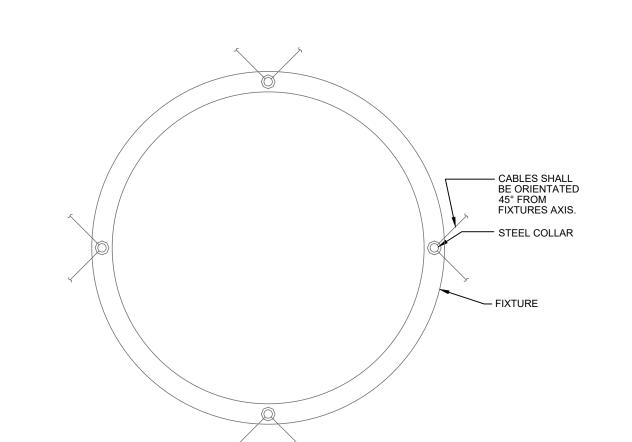
Shums Coda Associates

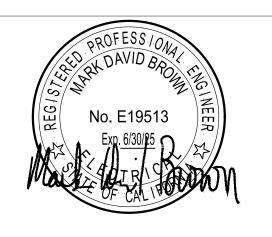
SHEET TITI

SINGLE LINE DIAGRAM
& PANELBOARD
SCHEDULES

SHEET NUMBER


E5.01



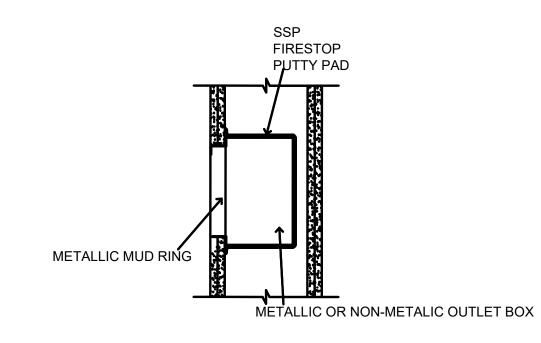


1 RECEPTACLE IN FIRE RATED WALL
NOT TO SCALE

PLAN VIEW

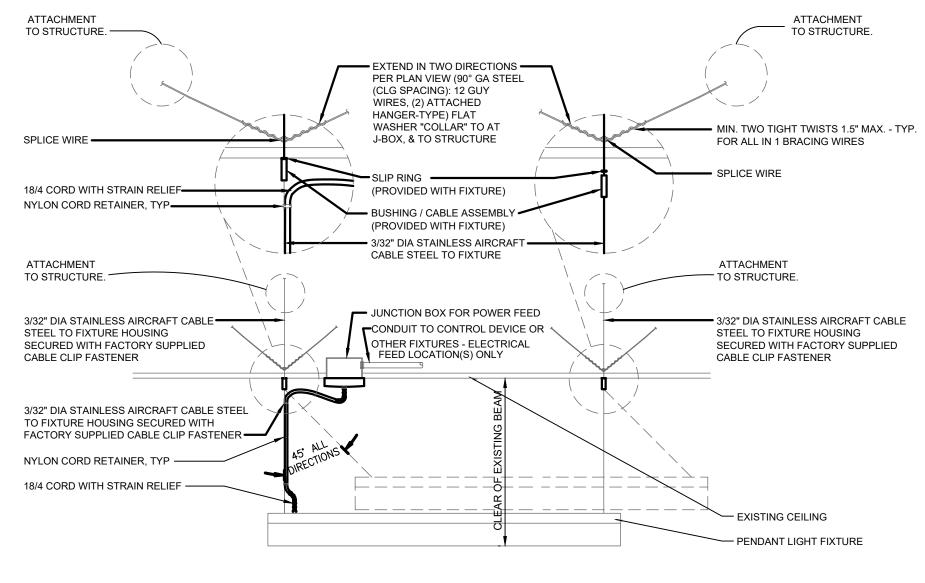


PENDANT MOUNTED FIXTURE SUPPORT DETAIL (TYPE P7, P7A)
NOT TO SCALE


ELEVATION VIEW

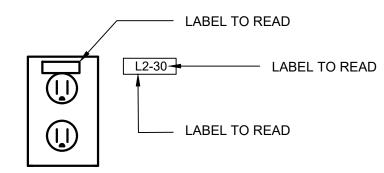

2 RECEPTACLE LABELING
NOT TO SCALE

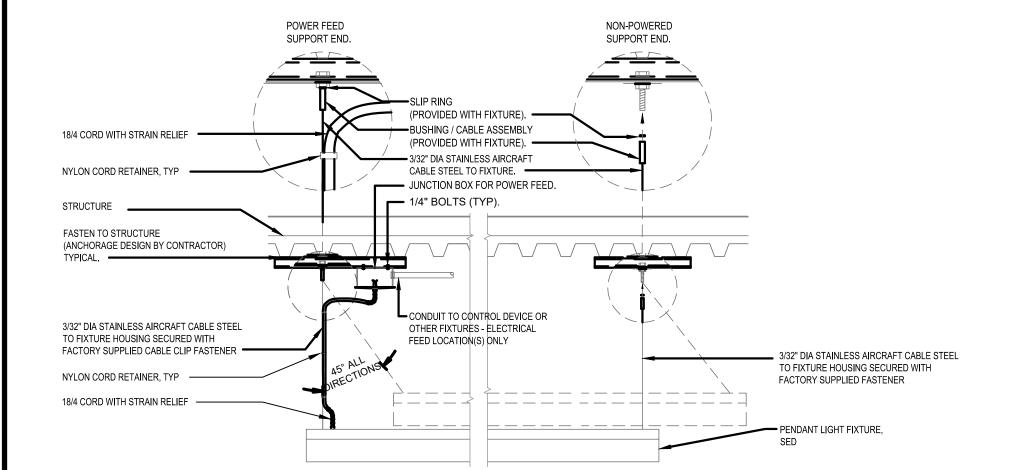

5 PENDANT MOUNTING LINEAR FIXTURE DETAIL (TYPES P2 & P3, P3A, P3B)
NOT TO SCALE

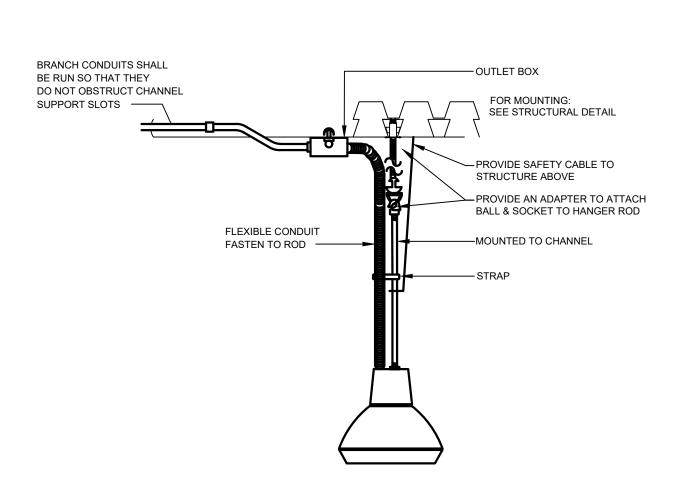

PENDANT MOUNTED FIXTURE SUPPORT DETAIL (TYPE P8, P9, P9A)
NOT TO SCALE

			INTERIOR LIGHTING F	IXTURE SCHE	DULE			,,		
TYPE	DESCRIPTION	MOUNTING	MANUFACTURER/ CATALOG #	LAMP	DRIVER	VOLTS	INPUT WATTS	FINISH	WEIGHT	LOCATION
P1	6" DIAMETER CYLINDER LIGHT WITH 0-10V DIMMING. NOTE: PROVIDE 90 MINUTE EM BATTERY BACKUP TO FIXTURES WITH 'EM' ON PLANS. SEE LIGHTING PLANS.	PENDANT (CEILING MOUNT) BOTTOM OF FIXTURE TO BE 3'-0" FROM ITS SUSPENSION POINT	LUMINIS AR160-L1L40-MULTI VOLT-FINISH-FS-K3D- SPG FIXTURES WITH EM: ADD EMLC2	LED 3000K CCT/90 CRI 4019 LM	INTEGRAL DIMMABLE	MULTI VOLT	53 W	BY ARCHITECT	8.8 LBS	GENERAL LIGHTING
P2	SUSPENDED LINEAR LIGHT WITH DIRECT OPTIC, 8' SECTIONS PLACED END TO END WITH 0-10V DIM. NOTE: PROVIDE 90 MINUTE EM BATTERY BACKUP TO FIXTURES WITH 'EM' ON PLANS. SEE LIGHTING PLANS.	PENDANT (CEILING MOUNT) BOTTOM OF FIXTURE AT 10'-0" AFF.	FLUXWERX LIGHTING FD1-A-8-D-93-FINISH-08-S-F2-M-12- OPTIONS-CONTROLS FIXTURES WITH EM: ADD B# (see plans for # of EM fixtures)	LED 3000K CCT/90 CRI 3900 LM/4FT	INTEGRAL DIMMABLE	MULTI VOLT	38 W/4 FT	BY ARCHITECT	3.4 LB/FT	BOOK STACKS
P3	SAME AS TYPE P2 BUT WITH 20% INDIRECT AND 80% DIRECT OPTIC.	PENDANT (CEILING MOUNT) BOTTOM OF FIXTURE TO BE 1'-6' FROM ITS SUSPENSION POINT	FLUXWERX LIGHTING FD1-A-D-D-90-FINISH-08-S-F2-M-03- OPTIONS-CONTROLS	LED 3500K CCT/90 CRI 4150 LM/4FT	INTEGRAL DIMMABLE	MULTI VOLT	38 W/4 FT	BY ARCHITECT	3.4 LB/FT	CONFERENCE
РЗА	SAME AS P3 BUT WITH 4' SECTIONS NOTE: PROVIDE 90 MINUTE EM BATTERY BACKUP TO FIXTURES WITH 'EM' ON PLANS. SEE LIGHTING PLANS.	PENDANT (CEILING MOUNT) BOTTOM OF FIXTURE TO BE 1'-6" FROM ITS SUSPENSION POINT	FLUXWERX LIGHTING FD1-A-D-D-90-FINISH-04-S-F2-M-03- OPTIONS CONTROLS FIXTURES WITH EM: ADD B# (see plans for # of EM fixtures)	LED 3500K CCT/90 CRI 4150 LM/4FT	INTEGRAL DIMMABLE	MULTI VOLT	38 W/4 FT	BY ARCHITECT	3.4 LB/FT	STAFF AREA
P3B	SAME AS TYPE P3 BUT WITH DIFFERENT COLOR TEMPERATURE NOTE: PROVIDE 90 MINUTE EM BATTERY BACKUP TO FIXTURES WITH 'EM' ON PLANS. SEE LIGHTING PLANS.	PENDANT (CEILING MOUNT) BOTTOM OF FIXTURE TO BE 1'-6" FROM ITS SUSPENSION POINT	FLUXWERX LIGHTING FD1-A-D-D-93-FINISH-08-S-F2-M-03- OPTIONS-CONTROLS FIXTURES WITH EM: ADD B# (see plans for # of EM fixtures)	LED 3000K CCT/90 CRI 4150 LM/4FT	INTEGRAL DIMMABLE	MULTIVOLT	38 W/4 FT	BY ARCHITECT	3.4 LB/FT	MEZZANINE
P4	DECORATIVE PENDANT LIGHT	PENDANT (STRUCTURE) BOTTOM OF FIXTURE AT 10'-6" - 11'-0" AFF, REFER TO ARCHITECTURAL ELEVATION ON SHEET A5.11.	GREGG SOSPENSIONE XL WITH GREEN CREATIVE LED BULB #36169	LED 3000K CCT/82 CRI 3100 LM	INTEGRAL DIMMABLE	MULTI VOLT	24 W	STANDARD	13 LB	ENTRANCE
P5	DECORATIVE SMALL SCALE PENDANT	PENDANT (CEILING) BOTTOM OF FIXTURE AT 7'-0" AFF	PEBBLE PEB-P-PRIMARY-SECONDARY-UNV- 120/277	LED 2700K CCT/90 CRI 1038 LM	INTEGRAL DIMMABLE	MULTI VOLT	14 W	BY ARCHITECT	18 LB	REGISTRATION DESK
P6	DECORATIVE PENDANT LIGHT	PENDANT (CEILING) BOTTOM OF FIXTURE AT 9'-6" AFF	MUUTO STRAND OPEN 15.7" WITH GREEN CREATIVE LED BULB #36169	LED 3000K CCT/82 CRI 3100 LM	INTEGRAL DIMMABLE	MULTI VOLT	24 W	STANDARD	4LB	READING AREA
P7	36° DIAMETER ROUND SUSPENDED LIGHT (ONLY IF ADD ALTERNATE #3 IS APPROVED) NOTE: PROVIDE 90 MINUTE EM BATTERY BACKUP TO FIXTURES WITH 'EM' ON PLANS. SEE LIGHTING PLANS.	PENDANT (CEILING) TOP OF FIXTURE TO BE JUST CLEAR OF THE EXISTING BEAMS	FOCAL POINT FSDEP-3-FL-5000DN-500UP-930K-1C-UNV- L11-C24-FINISH FIXTURES WITH EM: ADD Bodine B\$L6LST battery backup (see plans for # of EM fixtures)	LED 3000K CCT/90 CRI 1 5000 LM	INTEGRAL DIMMABLE	MULTI VOLT	43 W	BY ARCHITECT	48 LB	COMMUNITY ROOM
P7A	SAME AS TYPE P7 BUT WITH 24" DIAMATER (ONLY IF ADD ALTERNATE #3 IS APPROVED) NOTE: PROVIDE 90 MINUTE EM BATTERY BACKUP TO FIXTURES WITH 'EM' ON PLANS. SEE LIGHTING PLANS.	PENDANT (CEILING) TOP OF FIXTURE TO BE JUST CLEAR OF THE EXISTING BEAMS	FOCAL POINT FSDEP-2-FL-3000DN-500UP-930K-1C-UNV- L11-C24-FINISH FIXTURES WITH EM: ADD Bodine BSL6LST battery backup (see plans for # of EM fixtures)	LED 3000K CCT/90 CRI 3000 LM	INTEGRAL DIMMABLE	MULTI VOLT	26 W	BY ARCHITECT	24 LB	COMMUNITY ROOM
P8	32" DIAMETER DECORATIVE PENDANT LIGHT	PENDANT (CEILING) BOTTOM OF FIXTURE AT 12'-6" AFF	AXOLIGHT US-LAY F XX LED-COLORS-XX-LED	LED 2700K CCT/80 CRI 14400 LM	INTEGRAL DIMMABLE	MULTI VOLT	225 W	BY ARCHITECT	55.33 LB	GENERAL LIGHTING
P9	SAME AS TYPE P8	PENDANT (CEILING) BOTTOM OF FIXTURE AT 12'-6" AFF	AXOLIGHT US-LAY F XX LED-COLORS-XX-LED	LED 2700K CCT/80 CRI 14400 LM	INTEGRAL DIMMABLE	MULTI VOLT	225 W	BY ARCHITECT	55.33 LB	CHILDREN'S AREA
P9A	LARGE SCALE DECORATIVE PENDANT	PENDANT (CEILING) BOTTOM OF FIXTURE AT 12'-6" AFF	AXOLIGHT US-LAY A XX LED-COLORS-XX-LED	LED 2700K CCT/80 CRI 3300 LM	INTEGRAL DIMMABLE	MULTI VOLT	135 W	BY ARCHITECT	55.76 LB	CHILDREN'S AREA
R1	NOT USED			#155500F						
S1	8 LONG WALL MOUNTED LIGHT WITH INDIRECT ASYMMETRIC OPTIC	SURFACE (WALL)	SPI LIGHTING EIW11910-L31W-120-277V-90 CRI (MOD)- 3000K-BRK-DF_DIM1-FINISH	LED 3000K CCT/90 CRI (MOD) 2890 LM	INTEGRAL DIMMABLE	UNV	31 W	BY ARCHITECT		GENERAL LIGHTING
S1A	SAME AS TYPE S1 BUT WITH 4' LENGTH	SURFACE (WALL)	SPI LIGHTING EIW11909-L29W-120-277V-90 CRI (MOD)- 3000K-BRK-DF_DIM1-FINISH	LED 3000K CCT/90 CRI (MOD) 2720 LM	INTEGRAL DIMMABLE	UNV	29 W	BY ARCHITECT		GENERAL LIGHTING
S2	WALL MOUNTED LINEAR LIGHT WITH GRAZING OPTIC	SURFACE (SKYLIGHT WALL) BOTTOM OF FIXTURE FLUSH WITH BOTTOM OF SKYLIGHT WALL, AIMED UP	VODE LIGHTING 907BX-LENGTH PER PLAN-RAIL LENGTH- F1S-RP10-AE-2-Z-HO-309-S1-FINISH- OPTIONS	LED 3000K CCT/90 CRI 530 LM/FT	INTEGRAL DIMMABLE TO 1%	UNV	12.4 W/FT	BY ARCHITECT		SKYLIGHT WALL
S2A	SAME AS TYPE S2 BUT WITH DIFFERENT OPTIC AND DIFFERENT COLOR TEMPERATURE AND CRI NOTE: PROVIDE 90 MINUTE EM BATTERY BACKUP TO FIXTURES WITH 'EM' ON PLANS. SEE LIGHTING PLANS.	SURFACE (TOP OF BEAM)	VODE LIGHTING 907BX-LENGTH PER PLAN-RAIL LENGTH- F1S-RP10-AE-2-ZZ-Z-HO-30-G1-FINISH- OPTIONS FIXTURES WITH EM: ADD Bodine remote EM 90 min. battery backup (see plans for # of EM fixtures)	LED 3000K CCT/80 CRI 1426 LM/FT	INTEGRAL DIMMABLE TO 1%	UNV	12.4 W/FT	BY ARCHITECT		ENTRANCE
S3	23° DIAMETER AND 1° DEEP SURFACE MOUNTED LED LIGHT NOTE: PROVIDE 90 MINUTE EM BATTERY BACKUP TO FIXTURES WITH 'EM' ON PLANS. SEE LIGHTING PLANS.	SURFACE (CEILING)	AFX LIGHTING EGRESHALLBOARN FIXTURES WITH EM: ADD Bodine EM 90 min. battery backup (see plans for # of EM fixtures)	LED 3700K CCT/90 CRI 1 3375 LM	INTEGRAL DIMMABLE	UNV	40 W	WHITE		GENERAL LIGHTING
S3A	SAME AS TYPE S3 BUT WITH 15" DIAMETER NOTE: PROVIDE 90 MINUTE EM BATTERY BACKUP TO FIXTURES WITH "EM" ON PLANS. SEE LIGHTING PLANS.	SURFACE (CEILING)	AFX LIGHTING EGRE1625LAJD2WH FIXTURES WITH EM: ADD Bodine EM 90 min. battery backup (see plans for # of EM fixtures)	3000K CCT/90 CRI 2525 LM	INTEGRAL DIMMABLE	UNV	25 W	WHITE		RESTROOMS, STORAGE,
S4	2-0" LONG VANITY LIGHT	SURFACE (WALL AT 7'-0" AFF)	MODERN FORMS WS-3624-3000K-FINISH-	LED 3000K CCT/90 CRI 1650 LM	INTEGRAL DIMMABLE	UNV	28 W	STANDARD		RESTROOMS
S5	NOT USED									
S5A ZS1	NOT USED 15° DIAMETER SURFACE MOUNTED EXTERIOR LIGHT WITH COPPER FINISH (ONLY IF ADD ALTERNATE #2 IS APPROVED) NOTE: PROVIDE 90 MINUTE EM REMOTE BATTERY BACKUP	SURFACE (EXTERIOR CANOPY)	BEGA 34045 K3 FIXTURES WITH EM: ADD Bodine remote EM 90 min, battery backup	LED 3000K CCT/80 CRI 1 2685 LM	INTEGRAL	UNV	33 W	STANDARD		EXTERIOR CANOPY
V2:645	TO FIXTURES WITH 'EM' ON PLANS. SEE LIGHTING PLANS.		(see plans for # of EM fixtures) ISOLITE DCL	LED	INTEGRAL	5,46240/1500.5	125.0	GREEN		TURNINGUALT

THE FIXTURE

PROVIDED WITH

DCL-G-U-WH-WH COLOR-MTEBP

THROUGHOUT

LETTERS ON

INTERIOR LIGHTING FIXTURE SCHEDULE

FIXTURE SCHEDULE NOTES:

X1 EXIT SIGN WITH BUG EMERGENCY EYES


REFER TO SPEC SECTION APPENDIX FOR COMPLETE FIXTURE CUTSHEETS.

- REFER TO ARCHITECTURAL DRAWINGS FOR EXACT LOCATION, MOUNTING HEIGHT AND MOUNTING REQUIREMENTS OF ALL LUMINAIRES.
- 3. PROVIDE COMPLETE MOUNTING ACCESSORIES, SUPPORT BRACKETS, CLIPS, ETC. AS APPLICABLE TO THE FINISH CEILING OR CEILING STRUCTURE AS REQUIRED.

UNIVERSAL MOUNT

- 4. ARCHITECT TO CONFIRM ALL FINISHES. 5. SEE PLANS FOR EMERGENCY LIGHTING INFORMATION. FIXTURES WITH "EM" TO BE PROVIDED WITH 90 MINUTE EMERGENCY BATTERY BACK UP.

729 Heinz Avenue Berkeley, CA 94710 tel 510.542.2200 fax 510.542.2201

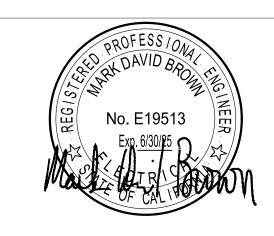



PROJECT TITLE

SONOMA COUNTY **PETALUMA REGIONAL LIBRARY RENOVATION** PROJECT NO.

100 FAIRGROUNDS DRIVE PETALUMA, CA 94952

PERMIT SET

N&T JOB NUMBER

1 1/22/2024 RESUBMITTAL

REVIEWED FOR CODE COMPLIANCE 05/03/2024

Shums Coda Associates

LIGHTING FIXTURE **SCHEDULE**

SHEET NUMBER

E6.01

NOTES ON WIRING

QS CONTROL LINK

THE QS CONTROL LINK HAS A FREE WIRING TOPOLOGY (DAISY CHAIN, T-TAP, ETC). THE SYSTEM WIRING ILLUSTRATED BY THIS DRAWING HAS BEEN LAID OUT TO ENSURE APPROPRIATE POWER TO EACH DEVICE. IF FOR ANY REASON THE SYSTEM IS TO BE WIRED DIFFERENTLY THAN WHAT IS SHOWN, PLEASE CONFIRM ALL DEVICE POWER REQUIREMENTS ARE MET (PLEASE REFER TO "QS LINK POWER REQUIREMENTS" FOR INDIVIDUAL DEVICE

POWER REQUIREMENTS). FOR QS CONTROL WIRE LENGTHS TOTALING LESS THAN 500 FT (153 M), USE LUTRON CABLE GRX-CBL-346S (4 CONDUCTOR NON-PLENUM), OR GRX-PCBL-346S (4 CONDUCTOR PLENUM). OTHERWISE USE 2 #18 AWG (1.0 SQ MM) + 2 #22 AWG (0.5 SQ MM) TWISTED AND SHIELDED OR EQUIVALENT (BELDEN #9461). FOR QS CONTROL WIRE LENGTHS TOTALING UP TO 2,000 FT, USE GRX-CBL-46L (5 CONDUCTOR NON-PLENUM) OR GRX-PCBL-46L (5 CONDUCTOR PLENUM). TOTAL QS CONTROL WIRE LENGTH MUST NOT EXCEED 2,000 FT (600 M).

DEVICE	PDUS
QS DEVICES THAT SUPPLY PD	U
DIN RAIL POWER SUPPLY	+75
MYROOM DIN RAIL POWER SUPPLY	+30
QS PLUG-IN POWER SUPPLY, QS J-BOX POWER SUPPLY	+8
ENERGI SAVR NODE WITH ECOSYSTEM, ENERGI SAVR NODE WITH DALI, ENERGI SAVR NODE WITH T-SERIES TUNABLE-WHITE	+30
ENERGI SAVR NODE FOR 0–10 V, ENERGI SAVR NODE WITH SOFTSWITCH, ENERGI SAVR NODE FOR 0–10 V (DIN RAIL), ENERGI SAVR NODE WITH SOFTSWITCH (DIN RAIL)	+14
1 A MYROOM DIN RAIL POWER MODULE SWITCHING, 1 A MYROOM DIN RAIL POWER MODULE PHASE ADAPTIVE	+4
ENERGI SAVR NODE WITH DALI (DIN RAIL), ENERGI SAVR NODE WITH ECOSYSTEM (DIN RAIL)	+3
ENERGI SAVR NODE PHASE ADAPTIVE (DIN RAIL), QS MOTOR GROUP CONTROLLER (DIN RAIL), HOMEWORKS QS DIN RAIL POWER MODULES	0
GRAFIK EYE QS (ALL MODELS EXCEPT GRAFIK EYE QS DALI WITH KNX), QS TIMECLOCK	+3
QP2 QUANTUM LIGHTING HUB	LINK A: 0 LINKS B,C,D: +33 EACH
QP3 QUANTUM LIGHTING HUB	LINKS A,B: +33 EACH
TWO PROCESSOR LIGHTING HUB (QP5)	LINKS A,B,C,D:+33 EACH
SINGLE PROCESSOR LIGHTING HUB (QP5), 2-LINK PROCESSOR (QP-2L)	LINKS A,B : +33 EACH
1-LINK PROCESSOR LIGHTING HUB (QP6), 1-LINK PROCESSOR LIGHTING HUB (QP5), 1-LINK PROCESSOR (QP-1L)	LINKS A: +33 EACH
QS DEVICES THAT CONSUME P	DU
QS WALLSTATION (SEETOUCH, ARCHITRAVE, SIGNATURE SERIES, QS PICO, KEYSWITCH, SINGLE COLUMN PALLADIOM), QS SLIDER, GRAFIK T SLIDER, QS INFRARED (IR) EYE, WALLBOX INPUT CLOSURE INTERFACE	-1
QS NETWORK INTERFACE, QS DMX INTERFACE, ENERGI SAVR NODE PROGRAMMING INTERFACE, QS WALLSTATION (DOUBLE COLUMN PALLADIOM)	-2
QS SENSOR MODULE (QSM), NOT INCLUDING ATTACHED WIRED SENSORS (SEE SECTION BELOW FOR MORE INFORMATION), QS CONTACT CLOSURE INTERFACE, PALLADIOM ROOM THERMOSTAT	-3
GUESTROOM CONTROL UNIT	-8
SENSORS & DEVICES THAT CONSUME F WIRED TO A QSM	PDUS WHEN
LUTRON DAYLIGHT SENSOR, LUTRON INFRARED (IR) RECEIVER, PICO WIRED CONTROLLER	-0.5
ECOSYSTEM WALLSTATION	-1
LOS C SERIES OCCUPANCY SENSOR, HIGH BAY OCCUPANCY SENSOR	-2

	SERVICE TITLE	
QTY	(MODEL NUMBER)	SERVICE DESCRIPTION
α	THE QUANTITY OF SERVICES	BELOW ARE TO BE INCLUDED AS PART OF THIS PROJECT'S SCOPE OF WORK AND SPECIFIED INTO THE WRITTEN SPEC DOCUMENTS
		PRE-STARTUP ELECTIVE SERVICES
		A REMOTE SESSION WHERE THE LUTRON FIELD SERVICE ENGINEER REVIEWS THE LUTRON SUBMITTAL PACKAGE (PARTICULARLY THE ONE LINE AND DEVICE SPECIFICATIONS)
	(LSC-PREWIRE-RMTE)	WITH THE ELECTRICAL CONTRACTOR, ANSWERS QUESTIONS, AND REVIEWS THE CONSTRUCTION TIMELINE ALONG WITH BEST PRACTICES FOR INSTALLATION. THIS SESSION IS DELIVERED USING A VIRTUAL SCREEN SHARING PLATFORM AND SHOULD NOT EXCEED 4-HOURS.
	ONSITE PRE-WIRE VISIT	AN ONSITE VISIT WHERE THE LUTRON FIELD SERVICE ENGINEER REVIEWS THE LUTRON SUBMITTAL PACKAGE (PARTICULARLY THE ONE LINE AND DEVICE SPECIFICATIONS) WITH
	(LSC-PREWIRE-ONST)	THE ELECTRICAL CONTRACTOR, ANSWERS QUESTIONS, AND REVIEWS THE CONSTRUCTION TIMELINE ALONG WITH BEST PRACTICES FOR INSTALLATION.
	POST-WIRE TERMINATION VISIT	AN ON-SITE WALK THROUGH BY A LUTRON FIELD SERVICE ENGINEER WITH THE ELECTRICAL CONTRACTOR TO CONFIRM THE PROCESSORS ARE ONLINE, THE DEVICES ARE INSTALLED AND WIRED PROPERLY, AND THE SYSTEM IS COMMUNICATING EFFICIENTLY PRIOR TO LUTRON RETURNING TO SITE FOR THE PHYSICAL STARTUP OF THE SYSTEM. THI
	(LSC-POSTWIRE-VST)	VISIT IS INTENDED AS A HIGH LEVEL VERIFICATION/CONFIRMATION THAT THE LUTRON EQUIPMENT IS WIRED AND POWERED; IT DOES NOT INCLUDE WIRING TROUBLESHOOTING,
		OR VALIDATION THAT THE ENTIRE SYSTEM WAS INSTALLED PER THE APPROVED SUBMITTAL. LUTRON WILL WORK TO CONFIRM OVERALL WIRING READINESS AND BASIC SYSTEM FUNCTIONALITY PRIOR TO START-UP AND WILL NOTE ANY DEFICIENCIES FOR THE ELECTRICAL CONTRACTOR. THE LUTRON SYSTEM MUST BE WIRED AND POWERED PRIOR TO
		THIS SITE VISIT.
	SENSOR LAYOUT & TUNING (LSC-SENS-LT)	LUTRON WILL TAKE RESPONSIBILITY FOR LUTRON-PROVIDED SENSOR PLACEMENT AND PERFORMANCE BY CREATING SENSOR LAYOUTS AND COORDINATING SENSOR PLACEMENT BEFORE AND AFTER INSTALLATION. ONCE THE BUILDING IS OCCUPIED, LUTRON WILL RETURN UP TO TWO TIMES TO PERFORM SENSOR FINE-TUNING.
	SYSTEM & NETWORK	A CONSULTATIVE VISIT WITH THIRD PARTY INTEGRATORS TO CONFIRM THE SPECIFIED SEQUENCE OF OPERATION AND DISCUSS INTEGRATION PROCEDURES NEEDED IN ORDER
	INTEGRATION CONSULTATION	TO INTEGRATE WITH THE LUTRON EQUIPMENT. THIS MAY INCLUDE ANY OF THE FOLLOWING THIRD PARTY SYSTEMS: BMS, BAS, IT, NON-LUTRON SHADES, BACNET, AV, OR ENERGY DASHBOARDS.
	(LSC-INT-VISIT)	
		STARTUP ELECTIVE SERVICES (THESE SERVICES ARE ADDITIONAL TO YOUR SPECIFIED STARTUP BASED ON YOUR REQUIREMENTS)
	ONSITE SCENE & LEVEL	AN ONSITE VISIT WITH THE SPECIFIER OR CUSTOMER REPRESENTATIVE TO REVIEW THE DESIGN INTENT, FINE-TUNE THE SCENE LEVEL PROGRAMMING, AND MAKE ADJUSTMENT
	TUNING (LSC-AF-VISIT)	TO TIMECLOCKS.
	DYNAMIC WHITE	A SPECIFIER DRIVEN PACKAGE WHICH INCLUDES ONE (1) POST WIRE TERMINATION VISIT (FOR WIRE VERIFICATION), TWO (2) VISITS TO PERFORM FINE TUNING OF FIXTURES AND
	PROGRAMMING PACKAGE (LSC-DWP-PKG)	PROGRAMMING ADJUSTMENTS PER THE DIRECTION OF A LIGHTING DESIGNER AND/OR A PRE-DETERMINED SEQUENCE OF OPERATIONS PROVIDED BY THE SPECIFIER. THE FIRST FINE-TUNING VISIT IS DURING NORMAL BUSINESS HOURS AND THE SECOND VISIT IS AN AFTER HOUR SITE VISIT. ALSO INCLUDED IN THIS PACKAGE IS A TWO-HOUR REMOTE
	(SESSION FOR MINOR ADJUSTMENTS. REMOTE NETWORK ACCESS IS REQUIRED FOR THE REMOTE TWO HOUR SESSION AND THE SYSTEM MUST BE ABLE TO CONNECT TO THE
	ONSITE	INTERNET. AN ONSITE WALKTHROUGH WITH FACILITY REPRESENTATIVES OR PROJECT COMMISSIONING AGENTS TO DEMONSTRATE THAT THE SYSTEM FUNCTIONALITY MEETS THE DESIGN
		INTENT. THIS MAY INCLUDE ANY OF THE FOLLOWING ONSITE ACTIVITIES - CONSULTATION/TRAINING DEMOS, FUNCTIONAL TESTING ASSISTANCE, OR INVENTORY OF LUTRON EQUIPMENT.
	(LSC-WALK)	EQUIPMENT.
	SYSTEM	COMPLETION OF DOCUMENTATION WHICH PROVIDES PERFORMANCE VERIFICATION CERTIFYING THE LUTRON EQUIPMENT HAS BEEN THOROUGHLY TESTED. IT SUPPORTS THE
	PERFORMANCE-VERIFICATION N DOCUMENTATION	DOCUMENTATION REQUIREMENTS OF MANY BUILDING STANDARDS.
	(LSC-SPV-DOC)	
	SYSTEM PERFORMANCE-VERIFICATION	DOCUMENTS THE TITLE 24 ACCEPTANCE TESTS REQUIRED FOR THE LIGHTING CONTROL SYSTEM AND THE TEST'S RESULTS. DOCUMENTATION IS TO BE FILLED OUT AS A SEPARATE VISIT AFTER ONSITE STARTUP BY LUTRON'S CALIFORNIA CERTIFIED CALCTP TECHNICIAN. UPON COMPLETION, A LUTRON SERVICES REPRESENTATIVE WILL SUPPLY THE
	N DOCUMENTATION TITLE 24	JOB-SPECIFIC TITLE 24 DOCUMENTATION THAT SHOWS THE RESULTS OF THE LIGHTING CONTROL SYSTEM TESTING.
	(LSC-SPV-DOC-T24) AFTER HOURS STARTUP	STARTUP PROVIDED BETWEEN THE HOURS OF 5:00PM – 7:00AM, MONDAY - FRIDAY. THIS SCOPE OF WORK DOES NOT INCLUDE HOLIDAY OR WEEKEND WORK. ADDITIONAL FEES
	(LSC-AH-SU)	MAY APPLY FOR WORK TO BE COMPLETED ON WEEKENDS (FRIDAY 5:00PM – MONDAY 7:00AM).
		POST-STARTUP ELECTIVE SERVICES
	CUSTOMER SYSTEM	AN ON-SITE VISIT WHERE THE LUTRON FIELD SERVICE ENGINEER COMES OUT 30-90 DAYS POST-OCCUPANCY TO GO OVER THE LUTRON SYSTEM COMPONENTS WITH THE SYSTEM
	ORIENTATION VISIT (LSC-CSO-VST)	USER AND PERFORMS A THOROUGH TRAINING. THE FIELD SERVICE ENGINEER WILL ENSURE THE SYSTEM USER KNOWS HOW TO NAVIGATE WITHIN THEIR SYSTEM AND MAKE APPROPRIATE ADJUSTMENTS. THEY WILL ALSO PROVIDE A LEAVE BEHIND SYSTEM OPTIMIZATION RECOMMENDATION REPORT.
	TRAINING VISIT	CUSTOMER-SITE SOLUTION TRAINING - THIS TRAINING VISIT IS PROVIDED BY A LUTRON SERVICES REPRESENTATIVE TO TEACH SYSTEM USERS HOW TO OPERATE AND MAINTAIN
	(LSC-TRAINING-SP) SYSTEM OPTIMIZATION	THE LIGHTING CONTROL SYSTEM. QUANTITY DICTATES THE NUMBER OF VISITS PURCHASED. AN ONSITE CONSULTATIVE VISIT TO IDENTIFY AND IMPLEMENT LIGHTING CONTROL ADJUSTMENTS TO SAVE ADDITIONAL ENERGY AND CREATE A MORE PRODUCTIVE WORK
	(LSC-SYSOPT-SP)	ENVIRONMENT.
	PREVENTATIVE	VISIT TO PERFORM PREVENTATIVE MAINTENANCE, MINOR REPROGRAMMING, AND CONDUCT SYSTEM TRAINING. THE LUTRON SERVICE REPRESENTATIVE WILL REVIEW SERVICE
	MAINTENANCE VISIT (LSC-SCHD-MAINT)	OPTIONS WITH THE END-USER PRIOR TO BEGINNING ANY WORK. THE END-USER WILL RECEIVE DOCUMENTATION THAT DESCRIBES THE WORK PERFORMED AND ANY RECOMMENDATIONS FOR FUTURE SERVICE. QUANTITY DICTATES THE NUMBER OF DAYS PURCHASED.
	ADDITIONAL DAY OF	ONSITE DAY OF SERVICE BY A LUTRON SERVICE REPRESENTATIVE.
	SERVICE (LSC-DAY-ADDL-CS)	
	REMOTE SUPPLEMENTAL	A SUPPLEMENTAL REMOTE TRAINING FOR SITE PERSONNEL. THIS SERVICE IS AVAILABLE FOR LUTRON QUANTUM AND ATHENA SYSTEMS. THIS TRAINING IS NOT TO EXCEED 4
	TRAINING (LSC-TRAIN-RMTE)	HOURS. REMOTE NETWORK ACCESS IS REQUIRED FOR THIS VISIT AND THE SYSTEM MUST BE ABLE TO CONNECT TO THE INTERNET.
	REMOTE PROGRAMMING	ONE 4-HOUR REMOTE PROGRAMMING ASSISTANCE SESSION TO MAKE PROGRAMMING ADJUSTMENTS PER THE DIRECTION OF A FACILITY MANAGER OR SPECIFIER. THIS SERVICE
	ASSISTANCE (LSC-PRG-AST-RMTE)	IS AVAILABLE FOR LUTRON QUANTUM AND ATHENA SYSTEMS. REMOTE NETWORK ACCESS IS REQUIRED FOR THIS VISIT AND THE SYSTEM MUST BE ABLE TO CONNECT TO THE INTERNET.
	.1	MAINTENANCE & SUPPORT SERVICES
	SOFTWARE MAINTENANCE	PROVIDES COMPATIBILITY TESTING RESULTS OF QUANTUM WITH OPERATING SYSTEM PATCHES AND WEB BROWSER UPDATES. INCLUDES AN ELECTIVE FREE SOFTWARE
	AGREEMENT (LSC-SMA-SP)	UPGRADE LICENSE.
	COMMERCIAL SYSTEMS	A 2-YEAR SYSTEM WARRANTY PROVIDING 100% REPLACEMENT PARTS AND 100% LUTRON DIAGNOSTIC LABOR COVERAGE WITH A FIRST-AVAILABLE RESPONSE TIME.
1	2-YEAR LIMITED WARRANTY (LSC-B2)	
	ENHANCED SILVER	YEARS 1-2 - 100% REPLACEMENT PARTS AND 100% LUTRON DIAGNOSTIC LABOR COVERAGE WITH A FIRST-AVAILABLE RESPONSE TIME; YEARS 3-5 - 50% PARTS ONLY COVERAGE;
	(LSC-E8S)	YEARS 6-8 - 25% PARTS ONLY COVERAGE. VEARS 4.2. 400% DEDLACEMENT PARTS AND 400% LUTBON DIACNOSTIC LABOR COVERAGE WITH A 72 HOUR RESPONSE TIME AND AN ANNUAL (4 DAY) SCHEDULED RESPONSE TIME AND AN AND AN AND AN AND AN AND AND AN AND AN AND AND
	ENHANCED GOLD (LSC-E8G)	YEARS 1-2 - 100% REPLACEMENT PARTS AND 100% LUTRON DIAGNOSTIC LABOR COVERAGE WITH A 72-HOUR RESPONSE TIME AND AN ANNUAL (1-DAY) SCHEDULED PREVENTIVE MAINTENANCE VISIT; YEARS 3-5 - 50% PARTS ONLY COVERAGE; YEARS 6-8 - 25% PARTS ONLY COVERAGE.
	ENHANCED PLATINUM	YEARS 1-2 - 100% REPLACEMENT PARTS AND 100% LUTRON DIAGNOSTIC LABOR COVERAGE WITH A 24-HOUR RESPONSE TIME AND AN ANNUAL (1-DAY) SCHEDULED PREVENTIVE
	(LSC-E8P) SILVER TECHNOLOGY	MAINTENANCE VISIT; YEARS 3-5 - 50% PARTS ONLY COVERAGE; YEARS 6-8 - 25% PARTS ONLY COVERAGE. AN ANNUAL SERVICE PLAN THAT COVERS 100% REPLACEMENT PARTS AND 100% LUTRON DIAGNOSTIC LABOR WITH A FIRST-AVAILABLE ONSITE OR REMOTE RESPONSE TIME.
	SUPPORT PLAN	AN ANNOAL SERVICE FEAR THAT COVERS 100% REFEACEIVENT FARTS AND 100% LUTRON DIAGNOSTIC LABOR WITH A FIRST-AVAILABLE UNSITE UR REMOTE RESPONSE TIME.
	(LSC-SILV-IW)	AN ANNUAL DEDVICE DI AN THAT COVERS (COVERS COVERS
	GOLD TECHNOLOGY SUPPORT PLAN	AN ANNUAL SERVICE PLAN THAT COVERS 100% REPLACEMENT PARTS AND 100% LUTRON LABOR WITH A 72-HOUR ONSITE OR REMOTE RESPONSE TIME. ALSO INCLUDES AN ANNUAL (1-DAY) SCHEDULED PREVENTIVE MAINTENANCE VISIT EACH YEAR.
	(LSC-GOLD-IW)	
	PLATINUM TECHNOLOGY SUPPORT PLAN	AN ANNUAL SERVICE PLAN THAT COVERS 100% REPLACEMENT PARTS AND 100% LUTRON DIAGNOSTIC LABOR WITH A 24-HOUR ONSITE OR REMOTE RESPONSE TIME. ALSO INCLUDES AN ANNUAL (1-DAY) SCHEDULED PREVENTIVE MAINTENANCE VISIT EACH YEAR.
	(LSC-PLAT-IW)	
	DDEVENTIVE MAINTENANCE	SCHEDULED MAINTENANCE VISIT TO PERFORM PREVENTIVE MAINTENANCE, MINOR PROGRAMMING, AND CONDUCT SYSTEM TRAININGS. QUANTITY IS IN ADDITION TO ANY YEARL
	VISIT(S)	VISITS SPECIFIED WITH AN ENHANCED WARRANTY OR TECHNOLOGY SUPPORT PLAN.

PLEASE GO TO WWW.LUTRON.COM/SERVICES FOR FURTHER INFORMATION.

ONE-LINE

WIRE LEGEND

△ QS CONTROL LINK (CONNECT WIRES 1, 2,

- 3 AND 4)* ▲ QS CONTROL LINK (CONNECT WIRES 1, 3
- AND 4. DO NOT CONNECT WIRE 2)*

2, 3 AND 4. DO NOT CONNECT WIRE #5)*

- ∇P PANEL CONTROL LINK (CONNECT WIRES 1, 2, 3, 4 AND 5)*
- ▼P PANEL CONTROL LINK (CONNECT WIRES 1,
- DP PANEL CONTROL LINK (CONNECT WIRES 1,
- 3, 4 AND 5. DO NOT CONNECT WIRE #2)*
- QS SIVOIA SHADE CONTROL LINK* ▲ BELDEN CABLE 1387LA(OR EQUIVALENT)
- NORMAL INPUT POWER 2 #12 AWG (4 SQ
- MM) + GROUND NORMAL-EMERGENCY INPUT POWER 2
- ③ 3 PHASE 4 WIRE INPUT POWER, 4 #12 AWG (4 SQ MM) + GROUND


#12 AWG (4 SQ MM) + GROUND

- 2 #12 AWG (4 SQ MM) + GROUND
- 3 #12 AWG (4 SQ MM) + GROUND
- ♦ 0-10 V SIGNAL: 2#18AWG (1.0 SQ MM) • 2#18 AWG (1.0 SQ MM)
- ∞ 3#18 AWG (1.0 SQ MM)
- ♦ ECOSYSTEM BUS/LOOP*
- ◆ DALI LOOP
- LUTRON SENSOR CABLE C-CBL-522S OR USE 4#22 AWG (1.0 SQ MM)

T-SERIES TUNABLE-WHITE LOOP

- LUTRON SENSOR CABLE C-CBL-522S OR USE 3#22 AWG (1.0 SQ MM)
- DMX CABLE. USE LUTRON GRX-CBL-DMX-250/GRX-CBL-DMX-500 OR BELDEN #9729 (NON-PLENUM) OR BELDEN #89729 (PLENUM) OR DURA FLEX 22/4 WA
- E ETHERNET CABLE. CAT5E OR BETTER
 CABLE FOR LUTRON NETWORK TERMINATED WITH RJ45 CONNECTORS (NOT PROVIDED BY LUTRON). 328 FT (100 M) MAXIMUM RUN.
- FIBER OPTIC CABLE FOR LUTRON NETWORK TERMINATED WITH APPROPRIATE FIBER OPTIC CONNECTORS (NOT PROVIDED BY LUTRON). REQUIRES DEDICATED FIBER OPTIC LINK (SINGLE-MODE OR MULTI-MODE)
- --- RF CONNECTION ---- WIRED CONNECTION
- *PLEASE REFER TO NOTES ON WIRING FOR MORE WIRING GUIDELINES. **REFER TO LOAD SCHEDULE FOR FEED AND LOAD INFORMATION

729 Heinz Avenue Berkeley, CA 94710 tel 510.542.2200 fax 510.542.2201

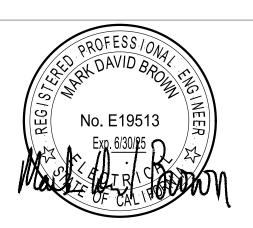



GUTTMANN& BLAEVOET CONSULTING ENGINEERS 2351 Powell Street San Francisco, CA. 94133—1449 P 415 655 4000 F 415 655 4001 E g&b@gb-eng.com

PROJECT TITLE

SONOMA COUNTY **PETALUMA REGIONAL LIBRARY RENOVATION** PROJECT NO.

100 FAIRGROUNDS DRIVE PETALUMA, CA 94952

PERMIT SET


REVIEWED FOR CODE COMPLIANCE

Shums Coda Associates

LIGHTING CONTROL

SHEET NUMBER


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NE NE

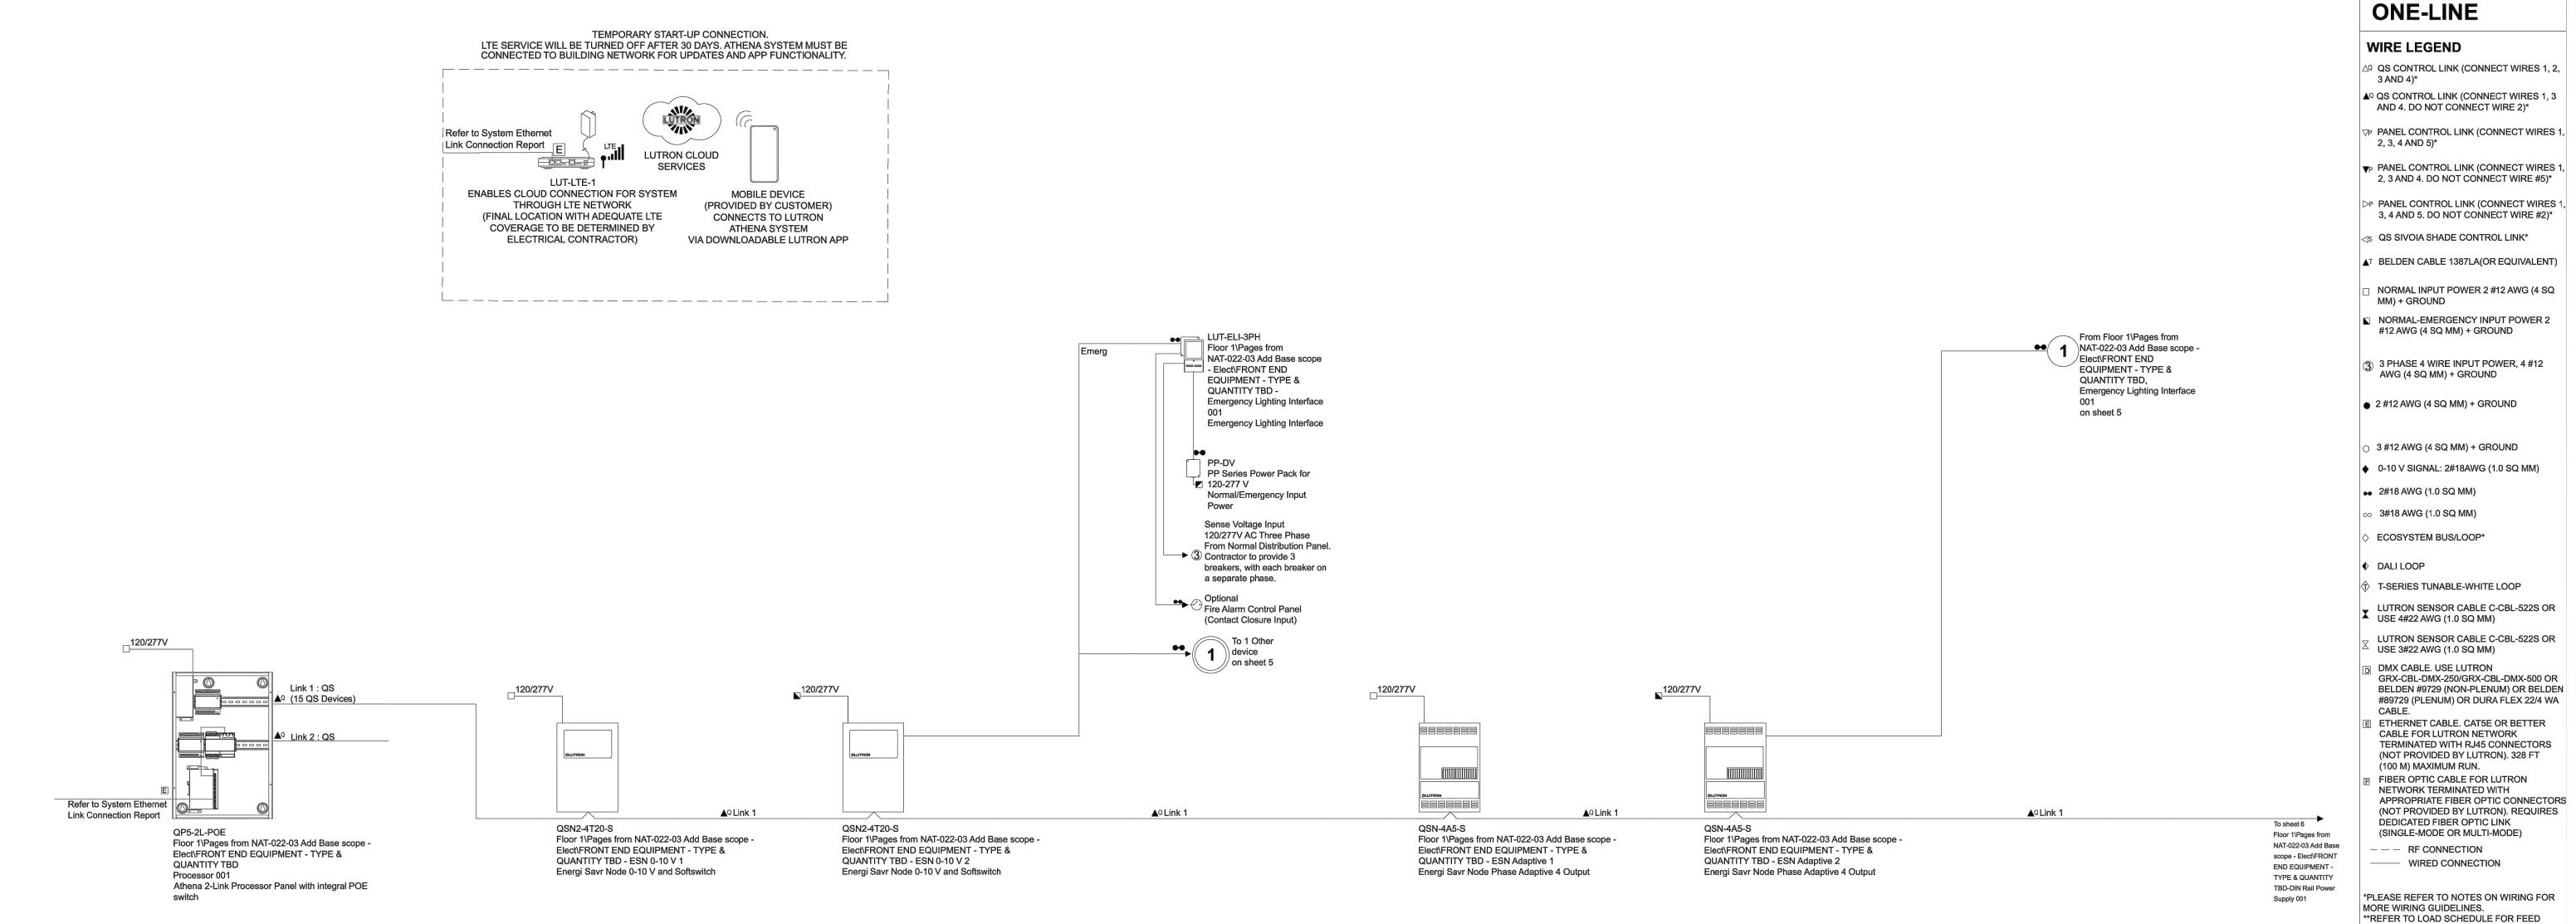NULL & TAM ARCHITECTS

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PROJECT TITLE

AND LOAD INFORMATION

PETALUMA
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RENOVATION
PROJECT NO.
10-19

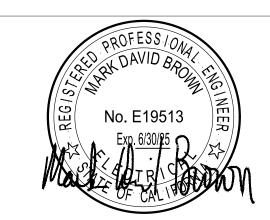100 FAIRGROUNDS DRIVE PETALUMA, CA 94952

PERMIT SET

ISSUE DATE 11/27

N&T JOB NUMBER

REVISIONS

REVIEWED FOR CODE COMPLIANCE 05/03/2024

Shums Coda Associates


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LIGHTING CONTROL DETAILS

SHEET NUMBER


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PROVALS



NULL & TAM
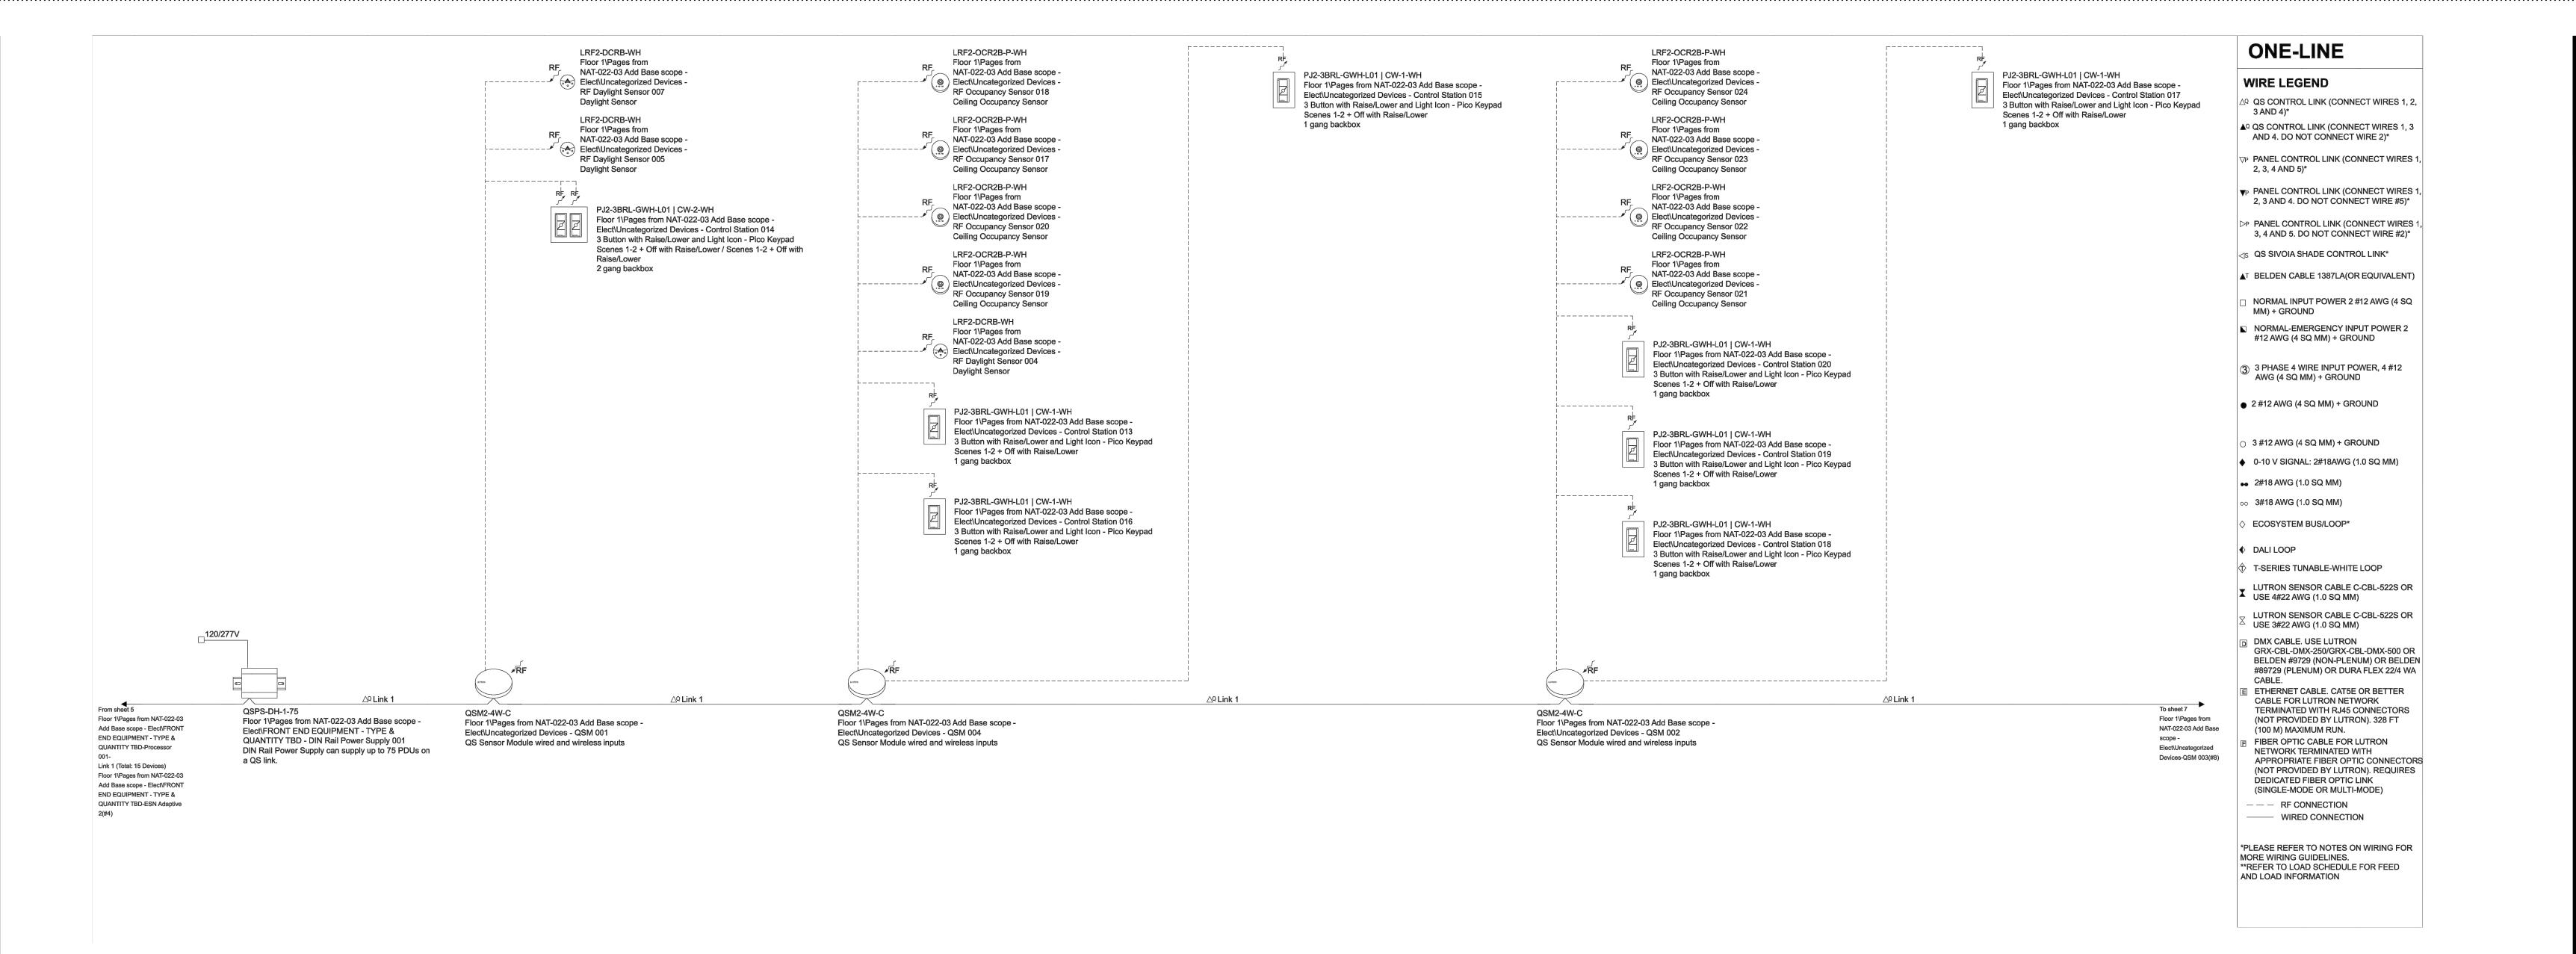
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100 FAIRGROUNDS DRIVE PETALUMA, CA 94952

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N&T JOB NUMBER
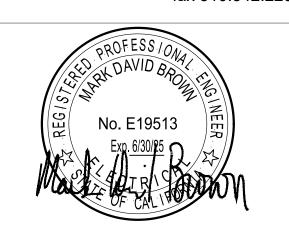
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DATE

REVIEWED FOR CODE COMPLIANCE

05/03/2024

Shums Coda Associates


LIGHTING CONTROL

SHEET NUMBER

E7.03

PROVALS

Drawing File:NAT02203zE703.dwg Plotting Date: 11/22/2023 8:05 AM

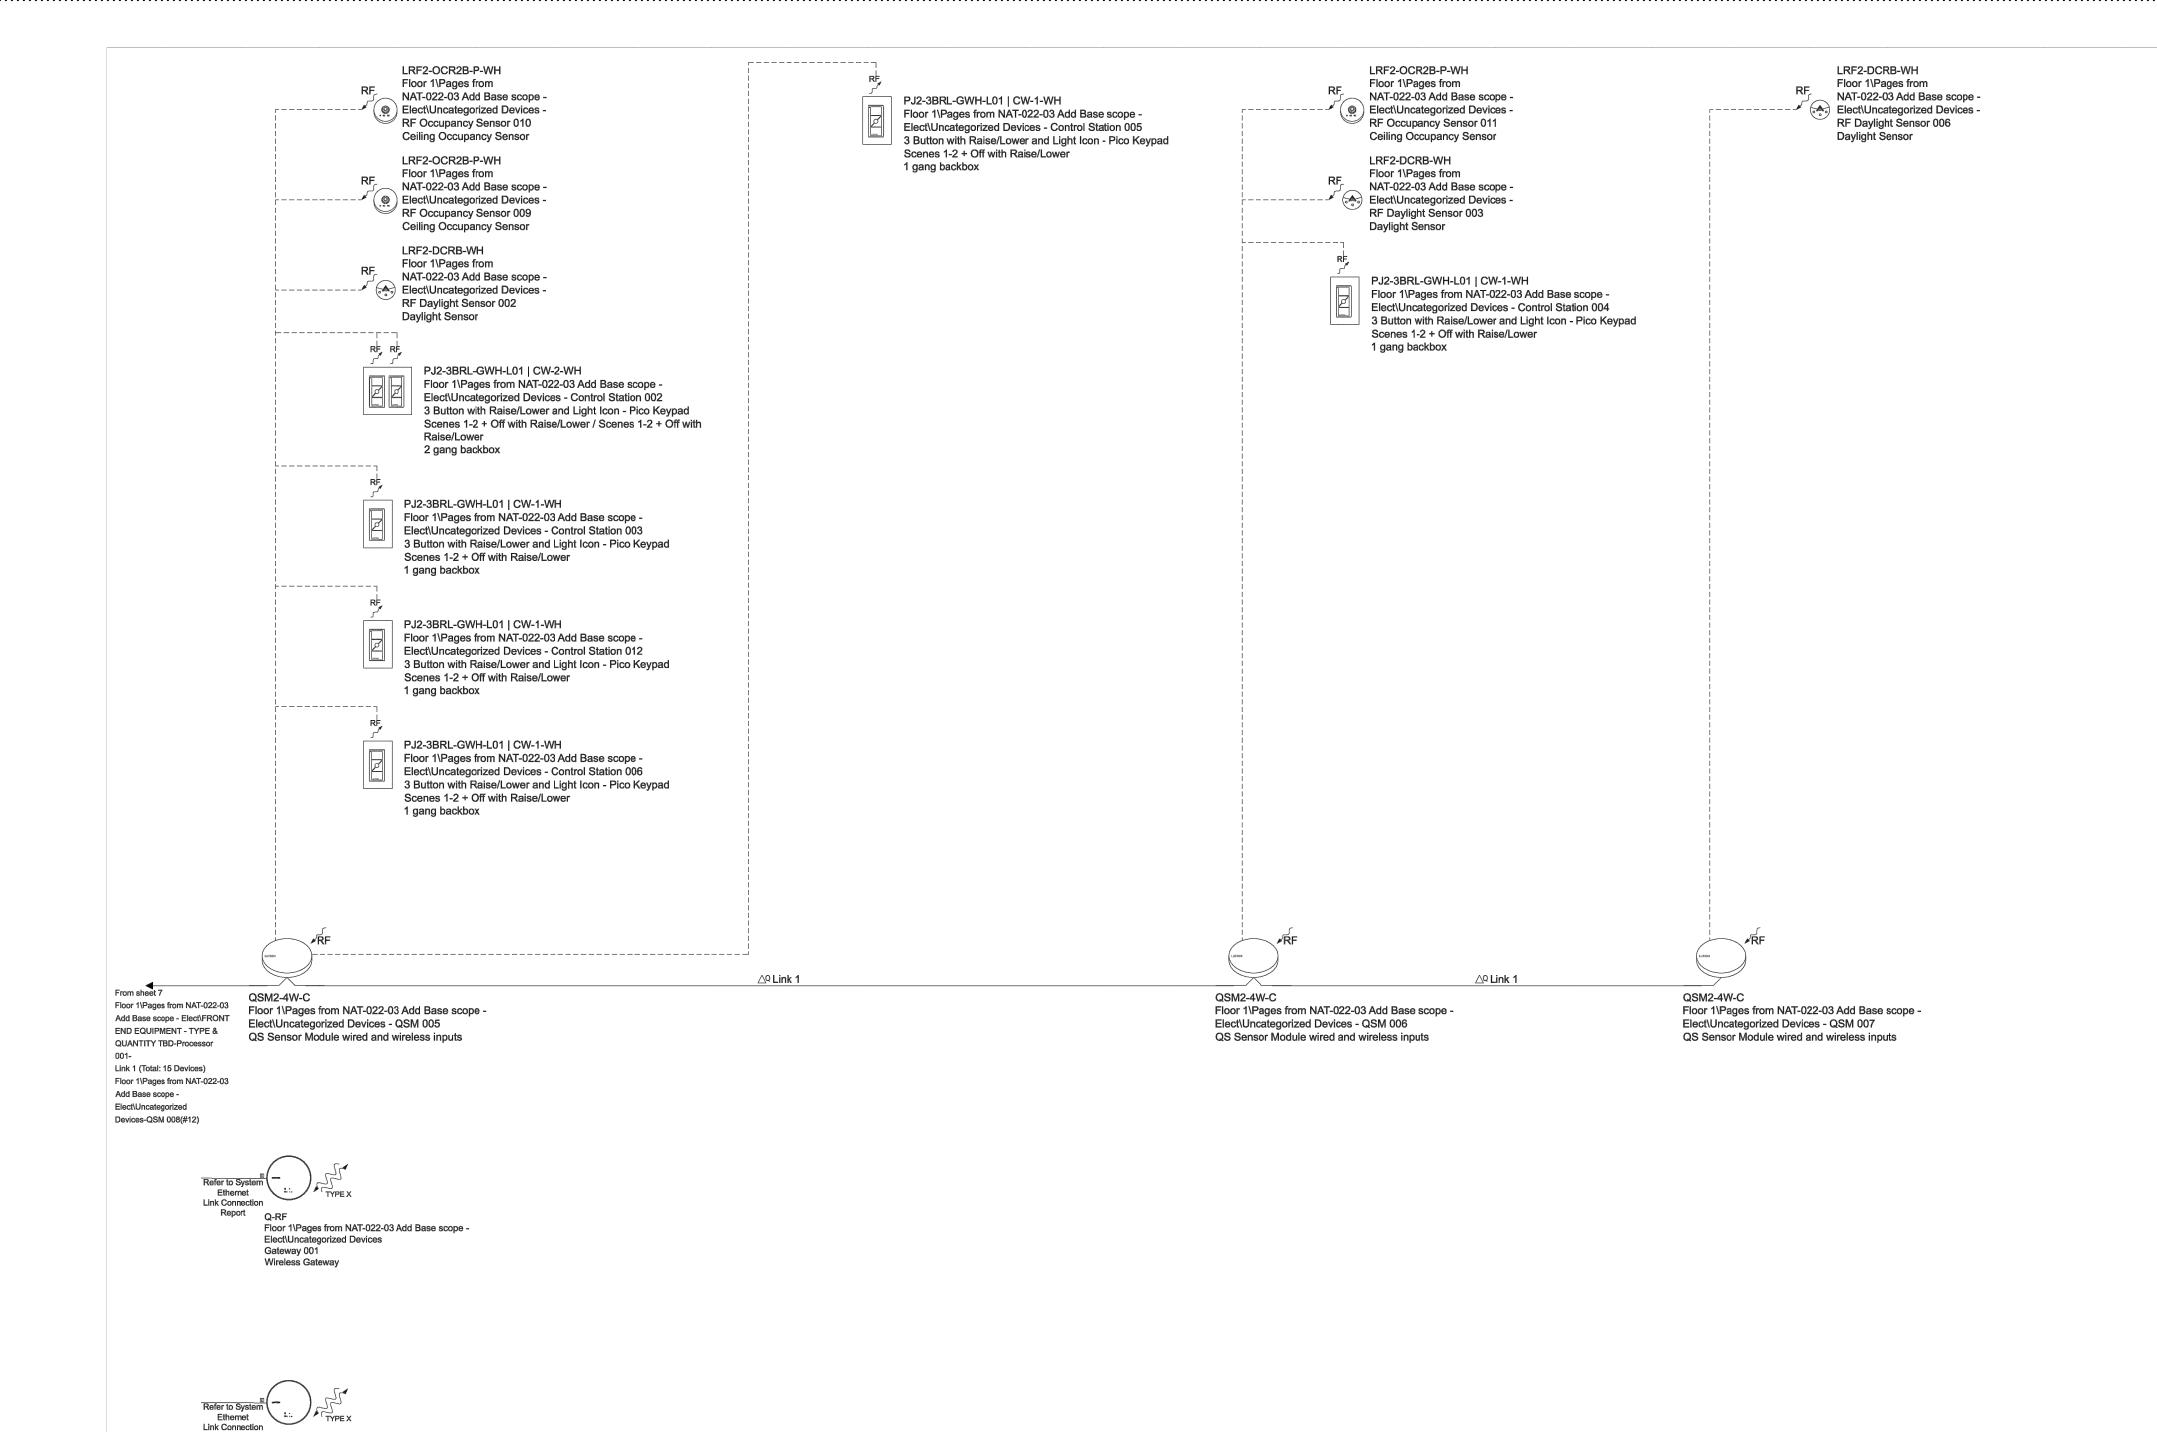

ONE-LINE

WIRE LEGEND

△ QS CONTROL LINK (CONNECT WIRES 1, 2, 3 AND 4)*

▲ QS CONTROL LINK (CONNECT WIRES 1, 3 AND 4. DO NOT CONNECT WIRE 2)*

→ PANEL CONTROL LINK (CONNECT WIRES 1,

2, 3, 4 AND 5)* ▼P PANEL CONTROL LINK (CONNECT WIRES 1,

2, 3 AND 4. DO NOT CONNECT WIRE #5)*

P PANEL CONTROL LINK (CONNECT WIRES 1, 3, 4 AND 5. DO NOT CONNECT WIRE #2)*

⊲S QS SIVOIA SHADE CONTROL LINK*

▲ BELDEN CABLE 1387LA(OR EQUIVALENT)

NORMAL INPUT POWER 2 #12 AWG (4 SQ MM) + GROUND

NORMAL-EMERGENCY INPUT POWER 2

#12 AWG (4 SQ MM) + GROUND

3 PHASE 4 WIRE INPUT POWER, 4 #12 AWG (4 SQ MM) + GROUND

2 #12 AWG (4 SQ MM) + GROUND

○ 3 #12 AWG (4 SQ MM) + GROUND

♦ 0-10 V SIGNAL: 2#18AWG (1.0 SQ MM) • 2#18 AWG (1.0 SQ MM)

o 3#18 AWG (1.0 SQ MM)

ECOSYSTEM BUS/LOOP*

◆ DALI LOOP

T-SERIES TUNABLE-WHITE LOOP

LUTRON SENSOR CABLE C-CBL-522S OR USE 4#22 AWG (1.0 SQ MM) LUTRON SENSOR CABLE C-CBL-522S OR

USE 3#22 AWG (1.0 SQ MM) D DMX CABLE. USE LUTRON GRX-CBL-DMX-250/GRX-CBL-DMX-500 OR

BELDEN #9729 (NON-PLENUM) OR BELDEN #89729 (PLENUM) OR DURA FLEX 22/4 WA E ETHERNET CABLE. CAT5E OR BETTER CABLE FOR LUTRON NETWORK


TERMINATED WITH RJ45 CONNECTORS (NOT PROVIDED BY LUTRON). 328 FT (100 M) MAXIMUM RUN. FIBER OPTIC CABLE FOR LUTRON

NETWORK TERMINATED WITH APPROPRIATE FIBER OPTIC CONNECTORS (NOT PROVIDED BY LUTRON). REQUIRES DEDICATED FIBER OPTIC LINK

(SINGLE-MODE OR MULTI-MODE) --- RF CONNECTION ---- WIRED CONNECTION

*PLEASE REFER TO NOTES ON WIRING FOR MORE WIRING GUIDELINES. **REFER TO LOAD SCHEDULE FOR FEED AND LOAD INFORMATION

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PROJECT TITLE

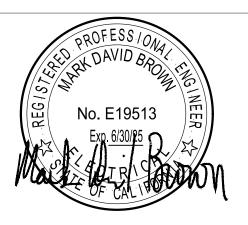SONOMA COUNTY **PETALUMA REGIONAL** PROJECT NO.

100 FAIRGROUNDS DRIVE PETALUMA, CA 94952

PERMIT SET

N&T JOB NUMBER

REVIEWED FOR CODE COMPLIANCE 05/03/2024

Shums Coda Associates

LIGHTING CONTROL

SHEET NUMBER

E7.04



Wireless Gateway

Refer to System

Ethernet
Link Connection
Report
Q-RF
Floor 1\Pages from NAT-022-03 Add Base scope Flect\Uncategorized Devices


Wireless Gateway

Athena 5" Touchscreen - White


Floor 1\Pages from NAT-022-03 Add Base scope -Elect\Uncategorized Devices - Touchscreen 001


1 Gang US Backbox (not provided by Lutron) - refer to install guide for proper mounting requirements

Q-TOUCH5-WH

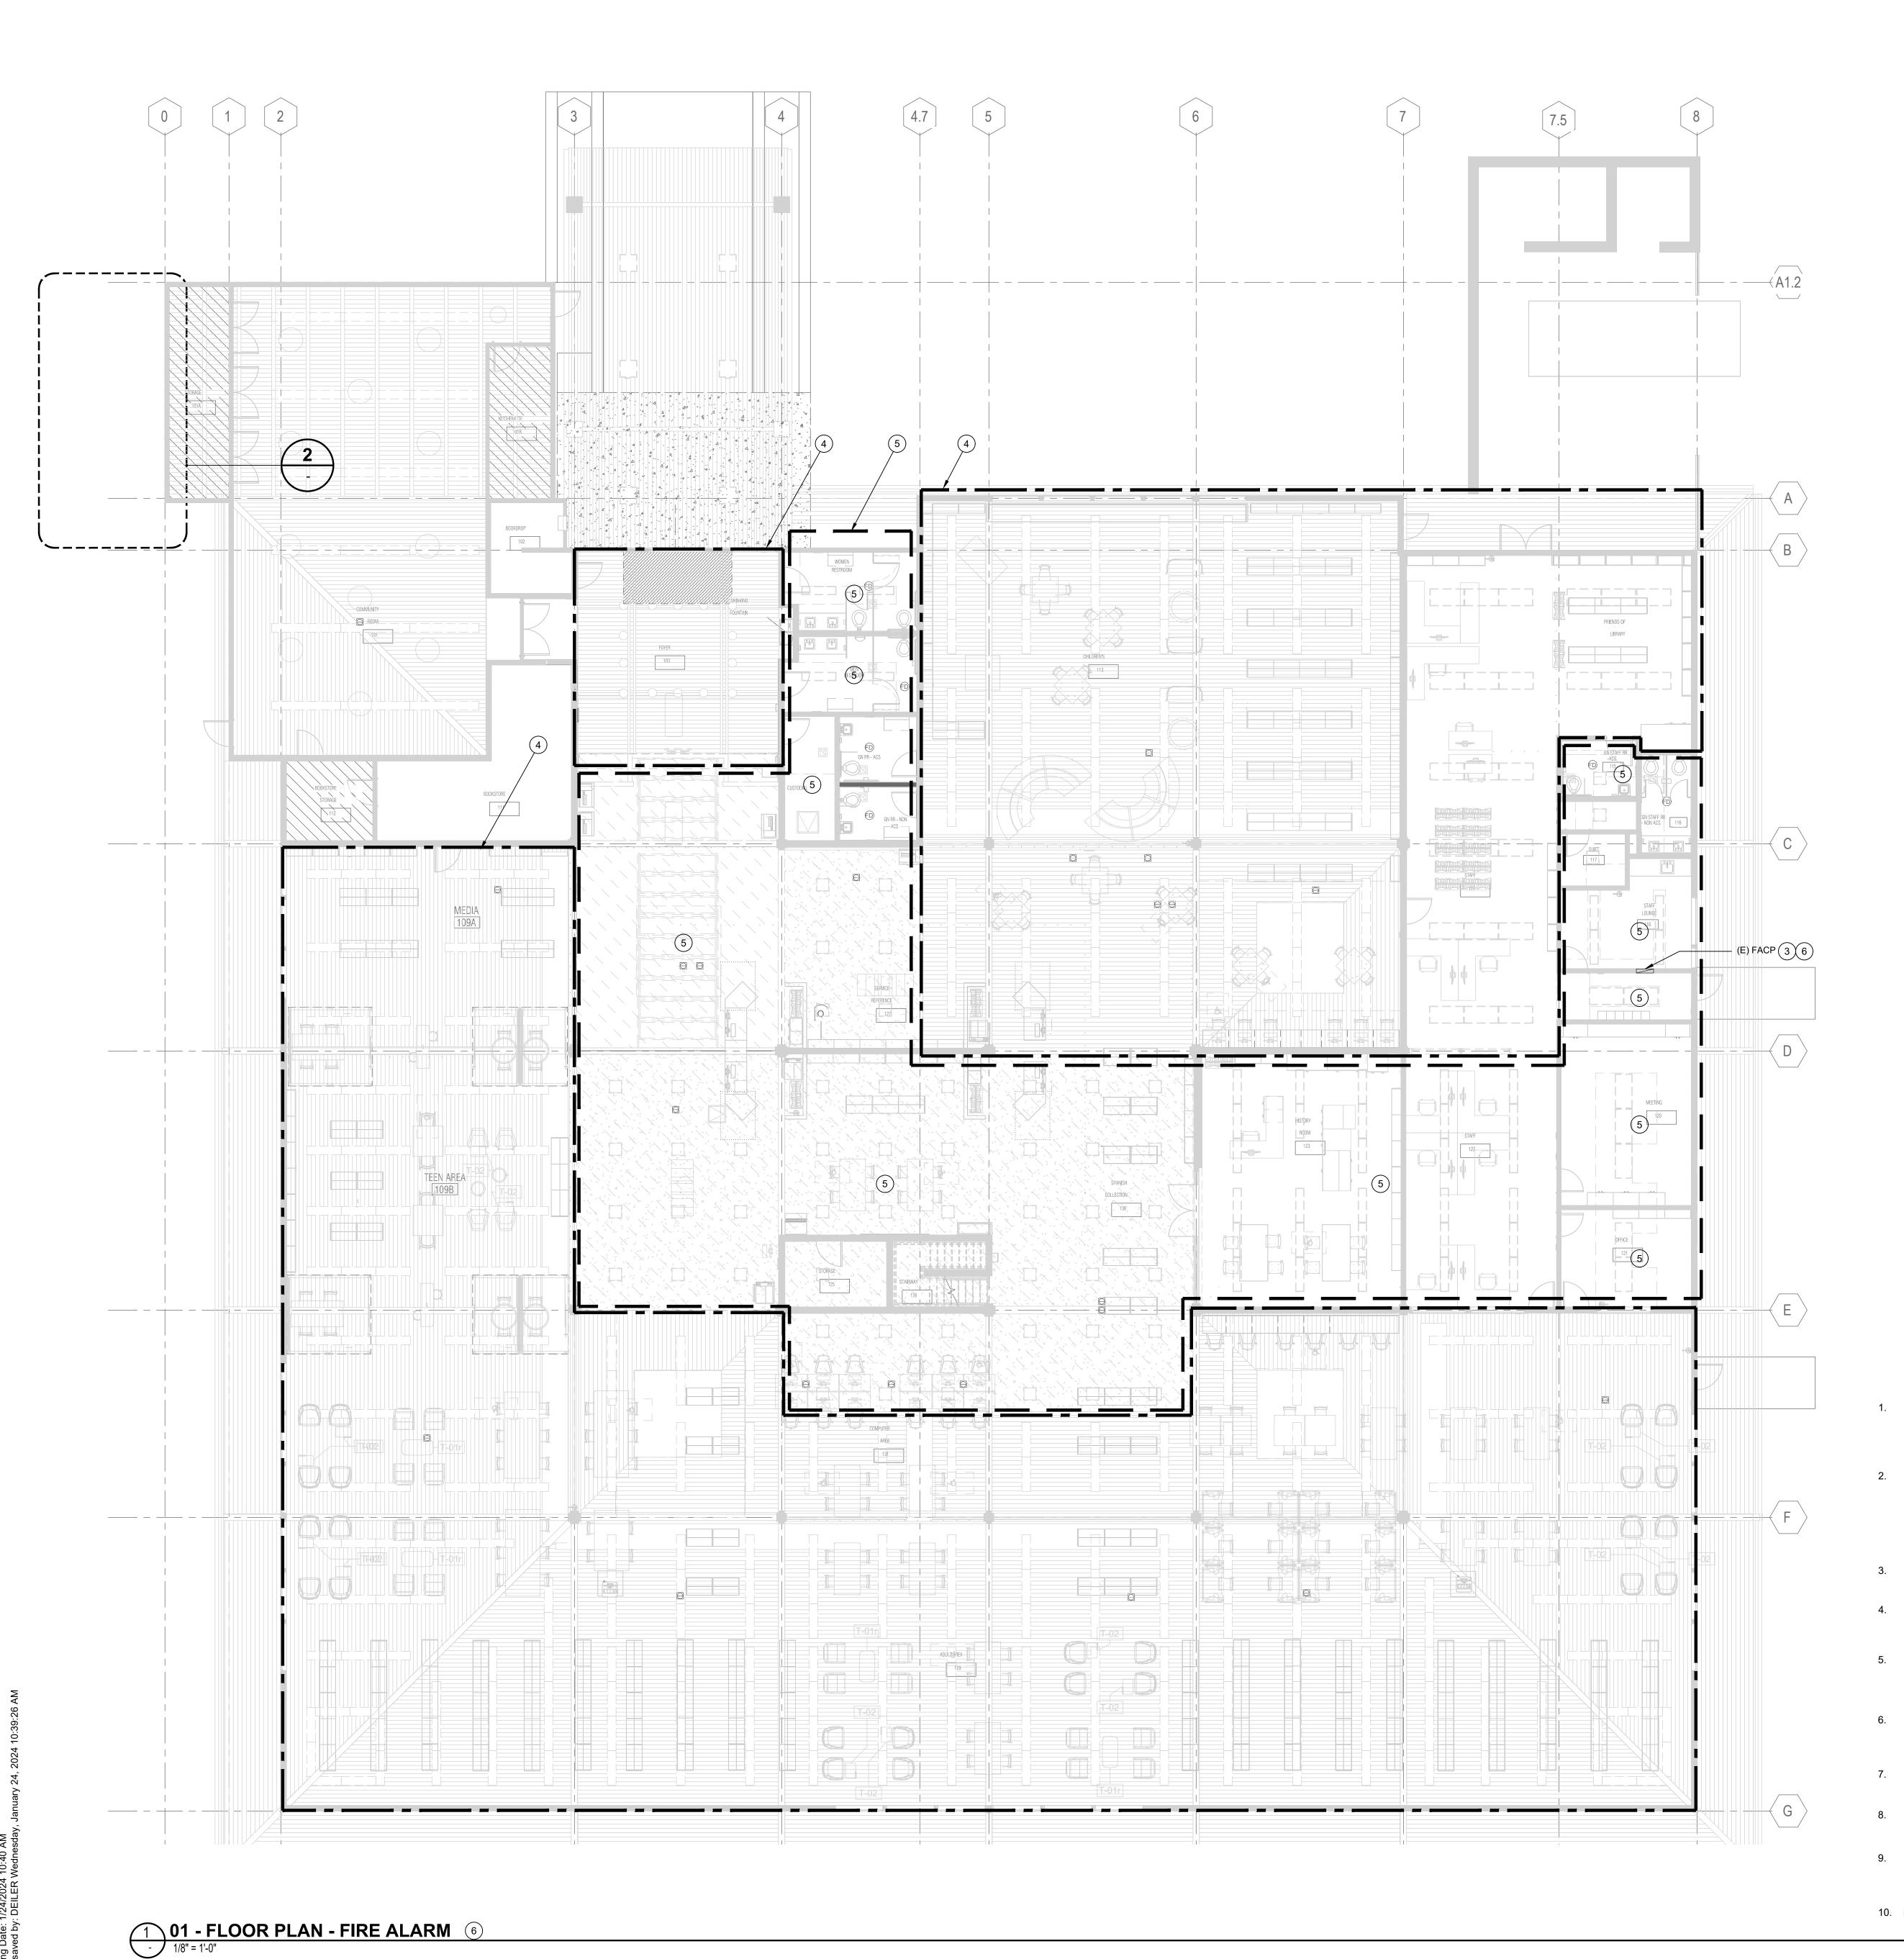

- 1) PROVIDE CONNECTION TO INTEGRAL TAMPER SWITCHES ON DOUBLE CHECK VALVE BACKFLOW PREVENTER (BFP). INTERCEPT AND EXTEND (E) CONNECTION FROM (E) PIV TAMPER SWITCH TO BFP TAMPER SWITCHES.
- (2) (E) PIV AND (E) FIRE ALARM BELL TO REMAIN. SHOWN FOR REFERENCE ONLY.
- (3) (E) FACP IS A SILENT KNIGHT "INTELLIKNIGHT" FIRE ALARM CONTROL COMMUNICATOR. MODEL NO. 5820XL. SHOWN FOR REFERENCE ONLY.
- 4 REMOVE AND RECONNECT (E) CEILING-MOUNTED FIRE ALARM DEVICES AS REQUIRED TO SUPPORT TENANT-IMPROVEMENT OF CEILING AND ALL RESTROOMS.
- (5) REMOVE AND RECONNECT (E) CEILING-MOUNTED FIRE ALARM DEVICES AS REQUIRED TO SUPPORT TENANT-IMPROVEMENT OF CEILING AND ALL RESTROOMS. GYPBOARD CEILING TO BE REMOVED IN THESE AREAS. REMOVE CONDUIT AND WIRING BACK AS REQUIRED TO ALLOW FOR REMOVAL OF (E) GYPBOARD CEILING AND (N) GYPBOARD CEILING. COORDINATE FINAL LOCATION OF FIRE ALARM DEVICE(S) WITH LIGHT FIXTURES, GRILLES, DIFFUSERS, ETC.
- (6) FIRE ALARM DRAWINGS ARE DESIGN-BUILD ONLY. FIRE ALARM DRAWINGS ARE DEFERRED APPROVAL. THE CONTRACTOR SHALL SUBMIT A SET OF SHOP DRAWINGS FOR REVIEW BY
- (7) EXISTING FIRE ALARM TERMINAL CABINET.

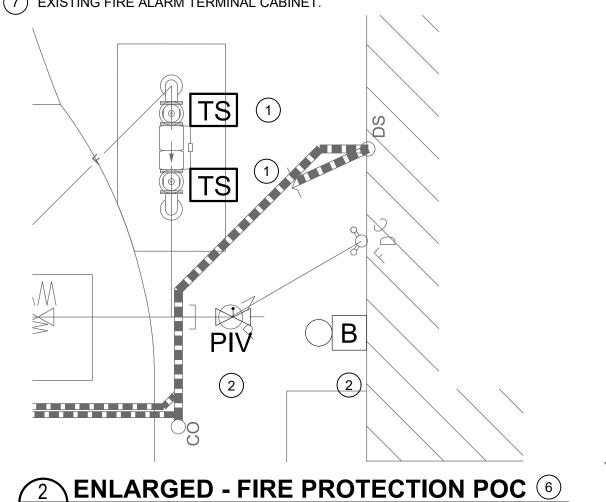

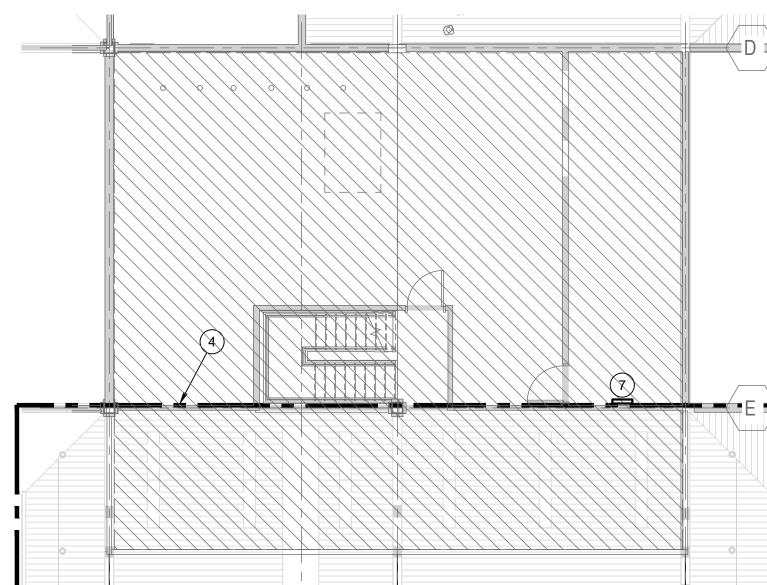

3 MEZZANINE (DEMO) 1/8" = 1'-0"

FIRE ALARM SYMBOLS LIST


- FIRE ALARM POST INDICATOR SWITCH CONNECTION
- FIRE ALARM CONTROL PANEL (ADDRESSABLE)
- FIRE ALARM ADDRESSABLE TAMPER SWITCH CONNECTION
 - FIRE ALARM BELL

GENERAL NOTES

- WILL BE HELD TO HAVE FAMILIARIZED THEMSELVES WITH ALL DISCERNIBLE CONDITIONS AND NO
- WHERE NOTED AS OWNER-SUPPLIED ON DRAWINGS, THE CONTRACTOR SHALL RECEIVE, INSTALL IS IN GOOD WORKING CONDITION. THE CONTRACTOR SHALL BE RESPONSIBLE FOR INSTALLATION,
- GROUND ALL PIPES, CONDUITS, DUCTS AND ALL OTHER METAL OBJECTS THAT PENETRATE THROUGH ANY OF THE PERIMETER WALLS OF THE PROJECT AREA.
- 4. LINES OR OTHER SERVICES THAT ARE DAMAGED AS A RESULT OF THIS WORK SHALL OF THE OWNER.
- 5. PENETRATING FIRE RATED WALLS: INSTALL CONDUIT IN CONDUIT SLEEVE OR FRAMED OPENING. SEAL ALL ELECTRICAL PENETRATIONS WITH UL LISTED FIRE STOP ASSEMBLY TO MAINTAIN RATING OF THE WALLS. ALL PENETRATION SEALS SHALL COMPLY WITH THE LATEST EDITION OF THE UL FIRE RESISTANCE DIRECTORY. FIRE RATING INTEGRITY MUST BE PRESERVED.
- 6. EXISTING WIRING WHERE SHOWN ON THE DRAWINGS IS BASED ON AVAILABLE AS-BUILT DRAWINGS AND FIELD INFORMATION. CONTRACTOR SHALL VERIFY EXISTING INSTALLATIONS AND THE TIME FOR DOING SO SHALL BE INCLUDED IN THE BID.
- 7. ALL NEW RACEWAYS AND CONDUCTORS SHALL BE INSTALLED CONCEALED WHERE POSSIBLE. RACEWAY THROUGH THE EXISTING BUILDING SHALL FOLLOW ESTABLISHED ROUTES AND HEIGHTS.
- 8. ALL EQUIPMENT TO BE INSTALLED OR PERMANENTLY CONNECTED MUST BE LISTED, LABELED OR CERTIFIED BY A NATIONALLY RECOGNIZED TESTING LABORATORY (NRTL).
- 9. ALL UNDERGROUND CONDUIT ENTERING BUILDING WALLS, VAULTS OR BOXES SHALL BE SLOPED AWAY FROM THE BOX OR WALL TO MINIMIZE WATER DRAINING INTO BUILDING OR
- 10. MINIMUM CONDUIT SIZE SHALL BE 3/4".



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PROJECT TITLE

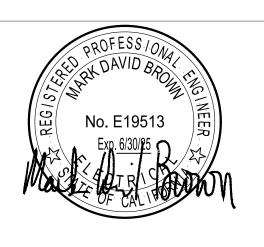SONOMA COUNTY **PETALUMA REGIONAL LIBRARY** RENOVATION PROJECT NO.

100 FAIRGROUNDS DRIVE PETALUMA, CA 94952

PERMIT SET

N&T JOB NUMBER

1 1/22/2024 RESUBMITTAL

FLOOR PLAN - 1ST FLOOR AND SITE PLAN -FIRE ALARM

SHEET NUMBER

FA0.01

GENERAL NOTES THE PURPOSE OF THIS SHEET IS TO ILLUSTRATE AND DEFINE TYPICAL SYMBOLS, AND SYSTEMS OF SYMBOLS, WHICH MAY OCCUR ON THE TELECOMMUNICATIONS DRAWINGS. THE ILLUSTRATION OF A SYMBOL, OR SYSTEM OF SYMBOLS, ON THIS SHEET DOES NOT NECESSARILY INDICATE THAT THE BUILDING ITEM OF THE DESCRIBED SYSTEM BY THE SYMBOL IS USED AS PART OF THIS PROJECT. REFER TO THE PLANS, ELEVATIONS, SECTIONS, SCHEDULES, DETAILS, AND SPECIFICATIONS TO DETERMINE THE SCOPE OF THE WORK. THE WORK - INCLUDING MATERIALS, METHODS, ASSEMBLIES, ETC - SHALL COMPLY WITH THE MINIMUM REQUIREMENTS OF THE GOVERNING LAWS, ORDINANCES, AND REGULATIONS OF ALL FEDERAL, STATE, AND LOCAL AUTHORITIES HAVING JURISDICTION OVER THE PROJECT, AS WELL AS THOSE GREATER REQUIREMENTS INDICATED BY THE CONTRACT DOCUMENTS. NO PART OF THE

	CONTRACT DOCUMENTS MAY BE CONSTRUED TO REQUIRE OR PERMIT WORK CONTRARY TO A GOVERNING LAW, ORDINANCE, OR REGULATION.	
3.	THE TELECOMMUNICATIONS DRAWINGS ARE PART OF THE OVERALL PROJECT DRAWINGS WHICH, WHEN COMPLETE, CONSISTS OF DRAWINGS LISTED BY THE "INDEX OF DRAWINGS". THE WORK DESCRIBED BY THE DRAWINGS OF ANY ONE DISCIPLINE MAY BE AFFECTED BY THE WORK AND REQUIREMENTS DESCRIBED ON DRAWINGS OF ANOTHER DISCIPLINE AND MAY REQUIRE REFERENCE TO THE DRAWINGS OF ANOTHER DISCIPLINE. PARTIAL SETS OF DRAWINGS ARE INCOMPLETE AND SHOULD NOT BE DISTRIBUTED OR UTILIZED BY THE CONTRACTOR. MANAGE, SUPERVISE, REVIEW, AND COORDINATE THE WORK OF SUB-CONTRACTORS, TRADES, AND SUPPLIERS WITH THE REQUIREMENTS OF THE CONTRACT DOCUMENTS BEFORE COMMENCING CONSTRUCTION AND TO ASSURE THAT PARTIES ARE AWARE OF REQUIREMENTS, REGARDLESS OF WHERE THE	

REQUIREMENTS OCCUR IN THE CONTRACT DOCUMENTS, WHICH MAY AFFECT THE WORK OF THAT

- THE ARCHITECTURAL DRAWINGS ESTABLISH AND COORDINATE THE FINISHED APPEARANCE AND EXACT LOCATION OF EXPOSED ELEMENTS OF THE WORK OF TRADES, INCLUDING THAT WORK THAT IS ILLUSTRATED PRIMARILY ON THESE DRAWINGS. LOCATIONS SHOWN ON THESE DRAWINGS ARE DIAGRAMMATIC. REFER TO ARCHITECTURAL DRAWINGS FOR DIMENSIONED LOCATIONS.
- MAINTAIN A COPY OF THE SPECIFICATIONS AND DRAWINGS AT THE JOB SITE. PRESENT THE SPECIFICATIONS AND DRAWINGS UPON REQUEST. MAINTAIN DAILY MARKUPS OF ACTUAL INSTALLATION AND PRESENT FOR REVIEW UPON REQUEST.
- REFER TO WRITTEN SPECIFICATIONS FOR PROJECT SCOPE, GENERAL REQUIREMENTS, PRODUCT SPECIFICATIONS, AND INSTALLATION REQUIREMENTS. WHERE QUANTITY AND QUALITY DIFFER, THE HIGHER OF EACH SHALL PREVAIL.
- PROVIDE NECESSARY EQUIPMENT AND ACCESSORIES FOR A FULLY FUNCTIONAL SYSTEM THAT MEETS INTENDED DESIGN WHETHER EXPRESSLY SPECIFIED OR NOT AND ALL INCIDENTALS PERTAINING TO THE INSTALLATION TO FORM A COMPLETE AND WORKING SYSTEM.
- PROVIDE MATERIALS AND EQUIPMENT LISTED BY UNDERWRITERS LABORATORIES FOR THE PURPOSE USED AND BEARING THEIR LABEL.
- PRIOR TO PERFORMING WORK, IMMEDIATELY NOTIFY THE OWNER, OR OWNER'S REPRESENTATIVE, IN WRITING OF OBSERVATIONS OR CONDITIONS DISCOVERED THAT WOULD PREVENT INSTALLATION ACCORDING TO DRAWINGS AND SPECIFICATIONS.
- 10. BRING A SET OF MARKED UP PLANS TO WEEKLY CONSTRUCTION MEETINGS FOR OWNER'S, OR OWNER'S REPRESENTATIVE'S, APPROVAL PRIOR TO PRODUCTION OF AS-BUILT DRAWINGS FOR RECORD DOCUMENTATION.
- REMOVE ABANDONED CABLING LEFT OVER CONDUIT, WIRE, SCRAPS, ETC. LEAVE PREMISES CLEAN AND FREE OF TRASH OR DEBRIS RESULTING FROM WORK. AND PROPERLY RECYCLE APPLICABLE MATERIAL ACCORDING TO ALL CODE REQUIREMENTS FOR SUCH MATERIAL.
- 12. INSTALL EQUIPMENT, DEVICES, AND PATHWAYS, SUCH AS CABLE TRAY, RUNWAY, CONDUITS, CABLE HANGERS, AND PULLBOXES, ETC., ACCORDING TO STATE AND LOCAL CODES AND REGULATORY REQUIREMENTS FOR SEISMIC BRACING.
- 13. CONDUIT ROUTING, WHERE SHOWN ON DRAWINGS, IS DIAGRAMMATIC IN NATURE. FIELD DETERMINE CONDUIT ROUTES TO SUIT FIELD CONDITIONS WHILE CONFORMING TO SPECIFICATIONS. PREPARE SHOP DRAWINGS SHOWING EXACT CONDUIT ROUTES, INDICATING PENETRATION TYPES (e.g., FRAMED WALL, CONCRETE WALL, ETC.). COORDINATE REQUIREMENTS WITH OTHER TRADES.
- INSTALL CONDUIT PATHWAYS PER TIA/EIA-568-B AND BICSI TDMM AND BEST INDUSTRY STANDARDS AND PRACTICES.
- ROUTE CONDUIT, CABLE TRAYS, J-HOOKS AND OTHER PATHWAYS PERPENDICULAR OR PARALLEL TO BUILDING LINES, IN GENERAL. CABLING INSTALLED AT ANGLES AND SKEWED ABOVE CEILINGS WILL NOT BE ALLOWED.
- CONDUITS WITH LESS THEN 2" INSIDE DIAMETER WILL HAVE A BEND RADIUS OF NO LESS THAN 6 TIMES THE INSIDE DIAMETER. CONDUITS WITH A 2" OR GREATER INSIDE DIAMETER WILL HAVE A BEND RADIUS OF NO LESS THAN 10 TIMES THE INSIDE DIAMETER.
- CONDUIT RUNS SHALL NOT EXCEED 180 DEGREES OR TWO 90-DEGREE BENDS WITHOUT AN APPROPRIATE NEMA RATED PULL BOX OR/AND INCREASE CONDUIT BY ONE TRADE SIZE FOR EACH ADDITIONAL BEND OF UP TO 90 DEGREES, UNLESS LAST BEND IS WITHIN 12 INCHES OF THE CONDUIT
- WHEN ROUTING CONDUIT IN CONCRETE, MAINTAIN A GRADUATED BEND RADIUS TO MAINTAIN CONDUIT CAPACITY. THE USE OF 90-DEGREE 'ELBOW' FITTINGS IS EXPRESSLY PROHIBITED UNLESS PRIOR AUTHORIZATION IS RECEIVED FROM OWNER, OR OWNER'S REPRESENTATIVE, IN WRITING.
- PROPERLY FIRE SEAL CONDUIT AND RACEWAY PENETRATIONS THROUGH FIRE RATED WALLS AND FLOORS TO MAINTAIN THE FIRE SEPARATION RATING. PROVIDE FIRE SEALING ASSEMBLIES THAT ARE UL LISTED FOR THE APPLICATION. COORDINATE REQUIREMENTS WITH LOCAL FIRE MARSHALL PRIOR TO INSTALLATION. DO NOT MIX PRODUCTS BETWEEN MANUFACTURED ASSEMBLIES.
- 20. PROVIDE EXPANSION/DEFLECTION FITTINGS FOR CONDUITS AT STRUCTURAL EXPANSION JOINT

CROSSINGS.

- 21. PROVIDE PLASTIC BUSHINGS ON EXPOSED ENDS OF CONDUIT AND SLEEVES, WHETHER VISIBLE OR
- 22. PROVIDE EMT 4" TRADE SIZE CONDUITS FOR BACKBONE PATHWAYS WITH 40" MINIMUM BEND RADIUS FITTINGS, UON.
- 23. PROVIDE MINIMUM OF 1 INCH SIZE CONDUIT FOR HORIZONTAL DISTRIBUTION AND TELECOMMUNICATIONS DEVICES. CONSOLIDATION OF CONDUITS IS ALLOWED WHEN EQUAL OR GREATER CONSOLIDATED AREA IS PROVIDED.
- 24. PROVIDE DEDICATED CONDUIT STUB PER TELECOMMUNICATIONS DEVICE BOX. DAISY-CHAINING DEVICE BOXES IS PROHIBITED UNLESS SPECIFICALLY NOTED ON FLOOR PLANS.
- 25. CONDULET ("LB", ETC.) FITTINGS ARE EXPRESSLY PROHIBITED FOR TELECOMMUNICATIONS SYSTEM PATHWAYS.
- 26. PROVIDE A PULL STRING OR PULL ROPE IN EMPTY/UNUSED DISTRIBUTION CONDUITS AND CONDUITS SERVING TELECOMMUNICATIONS DEVICES SUITABLE FOR A 200 LB PULL TENSION MINIMUM.
- . PROVIDE DEDICATED SUPPORTS (e.g., CLIPS & WIRES) FOR CABLE SUPPORT HANGERS (OR SIMILAR PATHWAY COMPONENTS) INTENDED FOR TELECOMMUNICATIONS CABLES.

GENERAL NOTES

- 28. DO NOT SHARE SUPPORTS WITH OTHER TRADES/SYSTEMS, INCLUDING SECURITY AND/OR AUDIOVISUAL SYSTEMS. PROVIDE WIRES, HANGERS, ETC. SEPARATE FROM THE CEILING SUPPORT SYSTEM AND OTHER INSTALLED SYSTEMS, A DEDICATED SUPPORT SYSTEM IS REQUIRED FOR TELECOMMUNICATIONS CABLING.
- PROVIDE TELECOMMUNICATION CONDUITS FOR CABLING ROUTED THROUGH NON-ACCESSIBLE CEILING SPACE (e.g., 'HARD LID' CEILING), UON. SIZE CONDUITS TO MAINTAIN A FILL CAPACITY LESS THAN 40% PLUS 50% SPARE CAPACITY.
- INSTALL TELECOMMUNICATIONS DEVICES AT HEIGHTS NOTED ON SYMBOLS LIST OR DEVICE SCHEDULE, UNLESS OTHERWISE SHOWN ON THE DRAWINGS OR STATED IN SPECIFICATIONS. MOUNTING HEIGHTS ARE FROM FINISHED FLOOR TO THE CENTERLINE OF THE DEVICE. REFER ARCHITECTURAL ELEVATION DRAWINGS FOR ADDITIONAL INFORMATION OR EXACT LOCATIONS OF WALL/CEILING/FLOOR MOUNTED DEVICES. VERIFY HEIGHTS ARE THE SAME AS ACCOMPANYING POWER RECEPTACLES AND NOTIFY OWNER, OR OWNER'S REPRESENTATIVE ANY DISCREPANCY.
- PROVIDE A 24" MINIMUM SEPARATION BETWEEN 'BACK-TO-BACK' TELECOMMUNICATION POWE OR SIGNAL DEVICES IN FRAMED WALLS.
- 32. DO NOT TIE CABLES TO OTHER STRUCTURES NOT INTENDED FOR THIS SPECIFIC USE. DO NOT TIE CABLES TO CABLE TRAY.
- ROUTE TELECOMMUNICATIONS CABLES PERPENDICULAR OR PARALLEL TO BUILDING LINES, IN GENERAL. ROUTE TELECOMMUNICATIONS CABLES NO LESS THAN 6 INCHES FROM ANY POWER SOURCE OR FLORESCENT LIGHTING FIXTURE, AND NO LESS THAN 4 FEET FROM ANY TRANSFORMER OR MOTOR.
- GROUP AND DRESS EXPOSED TELECOMMUNICATIONS CABLE GROUPS USING VELCRO TIES, U GROUP NO MORE THAN 20 CABLES IN A SINGLE BUNDLE AS ESTABLISHED FOR POE EQUIPMENT
- LABEL TELECOMMUNICATIONS CABLES ACCORDING TO SPECIFICATIONS. PROVIDE LABELS AT BOTH ENDS, FACEPLATES, PATCH PANELS, ETC. LABELING SCHEMA SHALL BE COORDINATED S THAT ALL LABELING, WHETHER ON FACEPLATE OR CABLE MATCHES CABLE DESCRIPTORS END TO END. PROVIDE SAMPLE LABELS TO THE OWNER, OR OWNER'S REPRESENTATIVE AND OBTA WRITTEN APPROVAL PRIOR TO LABELING (VERIFY FORMAT AND REQUIRED FIELDS OF INFORMATION).
- COMPONENTS NOT RELATED TO THE SUPPORT OF THE TELECOMMUNICATIONS ROOM(S) FUNCTION (E.G., PIPING, DUCTWORK, PNEUMATIC TUBING, ETC.) SHALL NOT BE INSTALLED IN, PASS THROUGH, OR ENTER THE TELECOMMUNICATIONS ROOM.
- IT IS FORBIDDEN TO ROUTE ANY LIQUID CARRYING SYSTEMS, INCLUDING VALVES OR RUBBER TUBING COMPONENTS CONTAINING LIQUID THROUGH TELECOM ROOMS AND SPACES

SCOPE OF WORK

THIS PROJECT CONSISTS OF NEW CABLING INFRASTRUCTURE, CONSISTING OF NEW CABLING, CAT CONDUITS, BOXES, CABLE TRAY IF INDICATED, J-HOOKS TO ESTABLISH A PATHWAY FOR CAT-6 CABLING TO ALL LOCATIONS SHOWN ON THE DRAWINGS. CABLING, OUTLETS, FACEPLATES, PATCH PANELS, CABLE FRAME AND RACKS, CABLE MANAGERS ARE ALL CONTRACTOR FURNISHED AND CONTRACTOR INSTALLED. OUTLET BOXES SHALL BE 4" SQ. MINIMUM DEEP WITH GANG RINGS AS SHOWN IN DETAILS.

CABLED LOCATIONS SHALL EACH RECEIVE A COMPLIMENT OF 2 DATA FOR EACH DUAL VOICE/DATA OUTLET AND 2 DATA CABLES FOR EACH DATA LOCATION AS SHOWN ON THE PLANS, OUTLETS WITH MORE ACTIVATIONS ARE CALLED OUT WITH THE APPROPRIATE NUMBER OF ACTIVATIONS REQUIRE AT THE LOCATIONS. CABLING SHALL ROUTE TO THE IDF TERMINATION ROOM, WHERE IT SHALL BE CONNECTED TO CATEGORY 6 PATCH PANELS, ALONG WITH INTERMEDIATE PATCH PANELS FOR VOI PATCHING.

NEW CONDUITS AND/OR J-HOOKS SHALL BE PROVIDED AND INSTALLED TO SUPPORT CABLING WITH THE BUILDING. J-HOOKS MAY ONLY BE USED ABOVE SUSPENDED CEILINGS WHERE THEY ARE HIDDI FROM VIEW.

	SYSTEMS	LEGEND/	SYMBOLS		
SYMBOL	DESCRIPTION	MODEL#	MANUFACTURER	BACK BOX	NOTES
 	DATA OUTLET(S) WALL MOUNT, . # INDICATES QTY. ACTIVATIONS. WP=WEATHERPROOF			1¼" CONDUIT STUB TO CEILING SPACE	
#	TELECOM OUTLETS FLOOR MOUNTED # DENOTES ACTIVATIONS		WIREMOLD/LEGRAND	(2) 11/4" CONDUIT STUB TO CEILING SPACE FOR TELECOM AND AV	
\blacksquare	2 DATA OUTLET(S) WALL MOUNT, . # INDICATES QTY. ACTIVATIONS. WP=WEATHERPROOF			1" CONDUIT STUB TO CEILING SPACE	FLUSH INTO WALL AT LOCATION SHOWN
\bowtie	TELECOM OUTLET, WALL PHONE 630B8 MOUNT STYLE WITH RJ45 OUTLET, STUB TO CEILING AND ACCESSIBLE SPACE.			1" CONDUIT STUB TO CEILING SPACE	
(((•))	WALL MOUNTED WIRELESS ACCESS POINT ENCLOSURE & CAT-6 DROP	WAP-ENCL OR EQUAL	WIREMOLD/LEGRAND		
	CEILING MOUNTED WIRELESS ACCESS POINT ENCLOSURE & (2) CAT-6A DROPS PER LOCATION	WAP-ENCL OR EQUAL	WIREMOLD/LEGRAND	CUSTOM IN CEILING ENCLOSURE 1" CONDUIT TO CEILNG SPACE	
	TYPICAL XX" X 2" WIRE BASKET CABLE TRAY OR AS NOTED				SEISMIC BRACE FOR ZONE REQUIREMENTS
	TYPICAL 19" OPEN FRAME 4 POST TELECOM RACK				
	TYPICAL XX" X 2" LADDER RACK CABLE TRAY OR AS NOTED		BLINE OR EQUAL		SEISMIC BRACE FOR ZONE REQUIREMENTS
- J — J —	TYPICAL J-HOOK PATH WAY ABOVE CEILING		BLINE OR EQUAL		
	TYPICAL FIRE SLEEVE THROUGH WALL, 4" MINIMUM	FS SERIES	WIREMOLD FLAMESTOPPER		
	TYIPCAL 6" WIDE VERTICAL CABLE MANAGER		BLINE, CHATSWORTH OR PANDUIT		
	TYPICAL 19" OPEN FRAME TELECOM RACK		BLINE, CHATSWORTH OR PANDUIT		
	TYPICAL FIRE RATED PLYWOOD IN TELECOM ROOMS				
	TYPICAL 18" LADDER RACK WALL BRACKET SUPPORT		BLINE, CHATSWORTH OR PANDUIT		
	TYPICAL 15" CENTER HUNG LADDER RACK SUPPORT		BLINE, CHATSWORTH OR PANDUIT		
\boxtimes	GROUND VALUT OR MANHOLE , SEE PLANS FOR TYPE & SIZE		CHRISTY OR EQUAL		
(((\\frac{\frac{1}{2}}{2})))	DAS ANTENNA LOCATION				
DAS	DAS HEADEND LOCATION	\sim			
(3)	EXISTING SPEAKER LOCATION	}			
~~~					

#### **DRAWING LIST**

Sheet Number	Sheet Title
T0 01	LECEND SYMBOLS CENERAL NO

LEGEND, SYMBOLS, GENERAL NOTES & DRAWING LIST T0.01

DEMOLITION PLAN - 1ST FLOOR AND MEZZANINE - LOW VOLTAGE T1.31 T2.31 FLOOR PLAN - 1ST FLOOR AND MEZZANINE - LOW VOLTAGE

T5.01 BLOCK RISER DIAGRAMS

T7.01 **DETAILS** 

T7.02 **DETAILS**  PROJECT TITLE

SONOMA COUNTY **PETALUMA** REGIONAL **LIBRARY RENOVATION** 

GUTTMANN& BLAEVOET

CONSULTING ENGINEERS

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2351 Powell Street

E g&b@gb-eng.com

729 Heinz Avenue

tel 510.542.2200

fax 510.542.2201

Berkeley, CA 94710

100 FAIRGROUNDS DRIVE PETALUMA, CA 94952

**PERMIT SET** 

I&T JOB NUMBER

DESCRIPTION

1 01/22/24 RESUBMITTAL


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Shums Coda Associates

SHEET TITLE LEGEND, SYMBOLS, **GENERAL NOTES & DRAWING LIST** 

SHEET NUMBER


T0.01

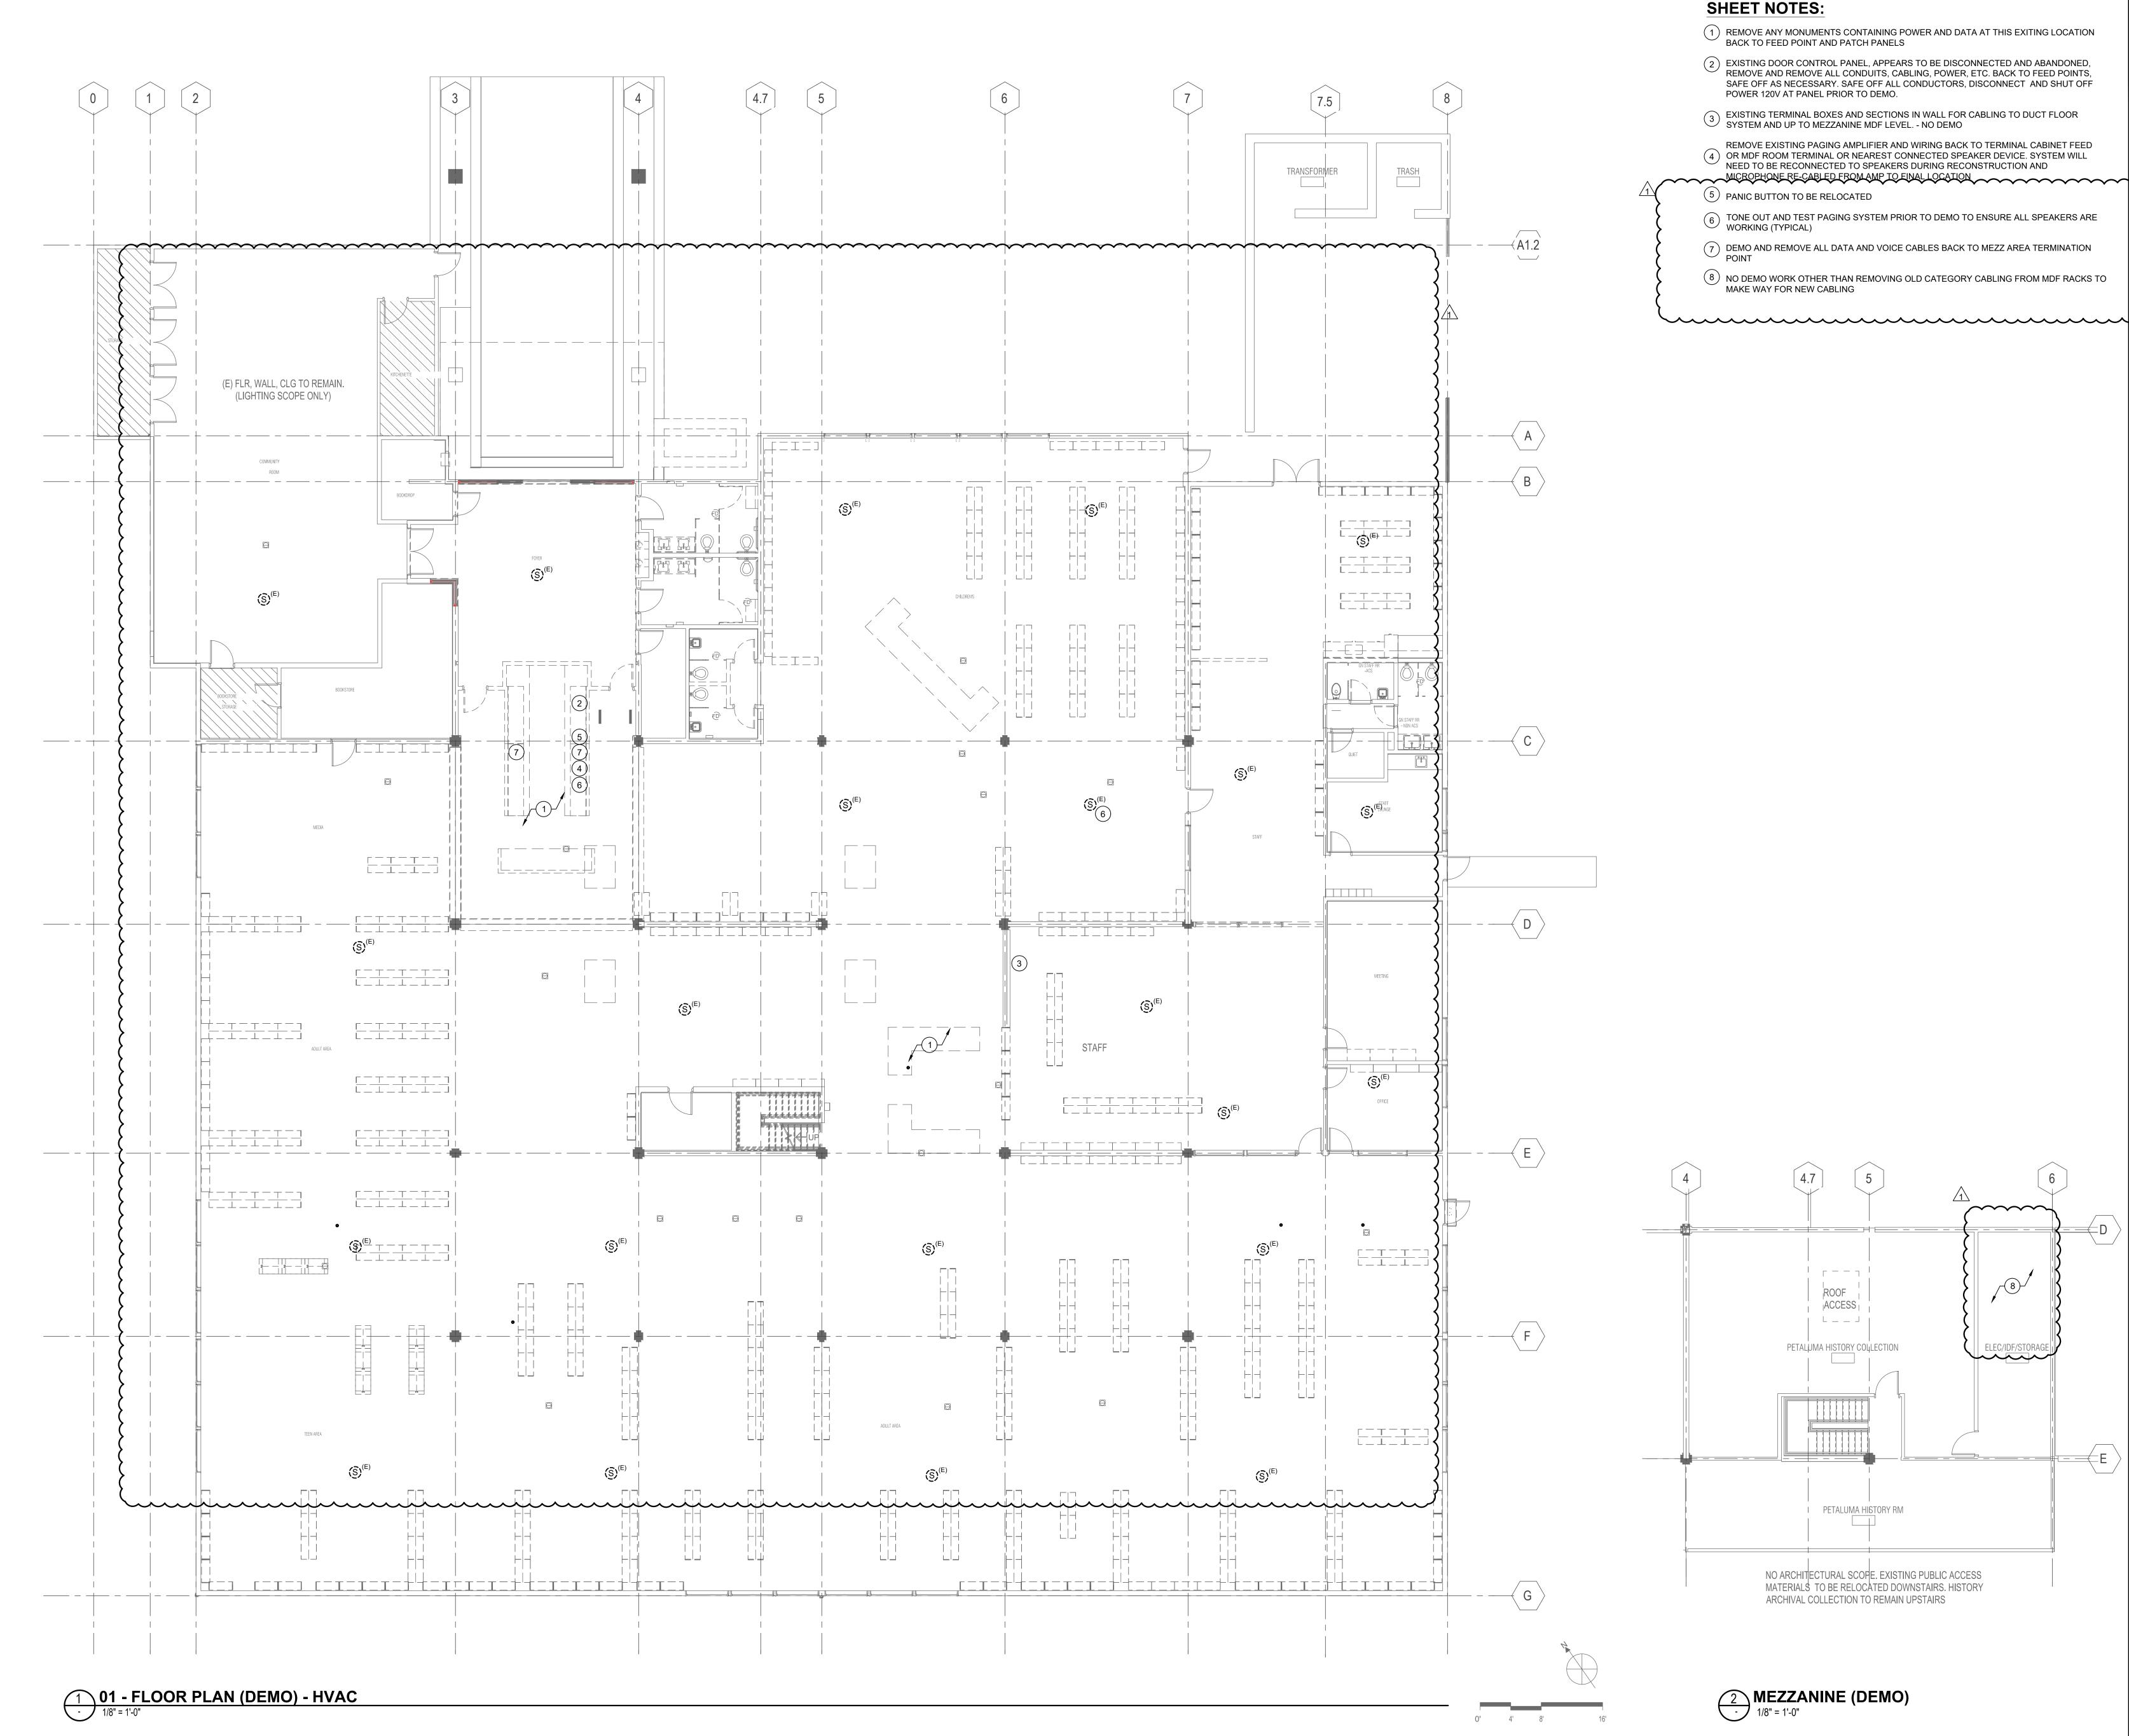

- 1 REMOVE ANY MONUMENTS CONTAINING POWER AND DATA AT THIS EXITING LOCATION BACK TO FEED POINT AND PATCH PANELS
- (2) EXISTING DOOR CONTROL PANEL, APPEARS TO BE DISCONNECTED AND ABANDONED, REMOVE AND REMOVE ALL CONDUITS, CABLING, POWER, ETC. BACK TO FEED POINTS, SAFE OFF AS NECESSARY. SAFE OFF ALL CONDUCTORS, DISCONNECT AND SHUT OFF POWER 120V AT PANEL PRIOR TO DEMO.
- 3 EXISTING TERMINAL BOXES AND SECTIONS IN WALL FOR CABLING TO DUCT FLOOR SYSTEM AND UP TO MEZZANINE MDF LEVEL. NO DEMO
- REMOVE EXISTING PAGING AMPLIFIER AND WIRING BACK TO TERMINAL CABINET FEED (4) OR MDF ROOM TERMINAL OR NEAREST CONNECTED SPEAKER DEVICE. SYSTEM WILL NEED TO BE RECONNECTED TO SPEAKERS DURING RECONSTRUCTION AND MICROPHONE RE-CABLED FROM AMP TO FINAL LOCATION
  - (5) PANIC BUTTON TO BE RELOCATED
  - TONE OUT AND TEST PAGING SYSTEM PRIOR TO DEMO TO ENSURE ALL SPEAKERS ARE WORKING (TYPICAL)
  - 7 DEMO AND REMOVE ALL DATA AND VOICE CABLES BACK TO MEZZ AREA TERMINATION
  - 8 NO DEMO WORK OTHER THAN REMOVING OLD CATEGORY CABLING FROM MDF RACKS TO MAKE WAY FOR NEW CABLING

ARCHITECTS

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PROJECT TITLE

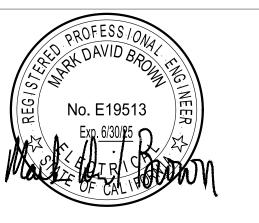SONOMA COUNTY **PETALUMA REGIONAL LIBRARY RENOVATION** PROJECT NO.

100 FAIRGROUNDS DRIVE PETALUMA, CA 94952

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ELEC/IDF/STORAGE

**DEMOLITION PLAN - 1ST** FLOOR AND MEZZANINE - LOW VOLTAGE

SHEET NUMBER

T1.31

APPROVALS

2 MEZZANINE (DEMO) 1/8" = 1'-0"

4.7

ROOF ACCESS 


PETALUMA HISTORY COLLECTION

I PETALUMA HISTORY RM

NO ARCHITECTURAL SCOPE. EXISTING PUBLIC ACCESS MATERIALS TO BE RELOCATED DOWNSTAIRS. HISTORY

ARCHIVAL COLLECTION TO REMAIN UPSTAIRS

5

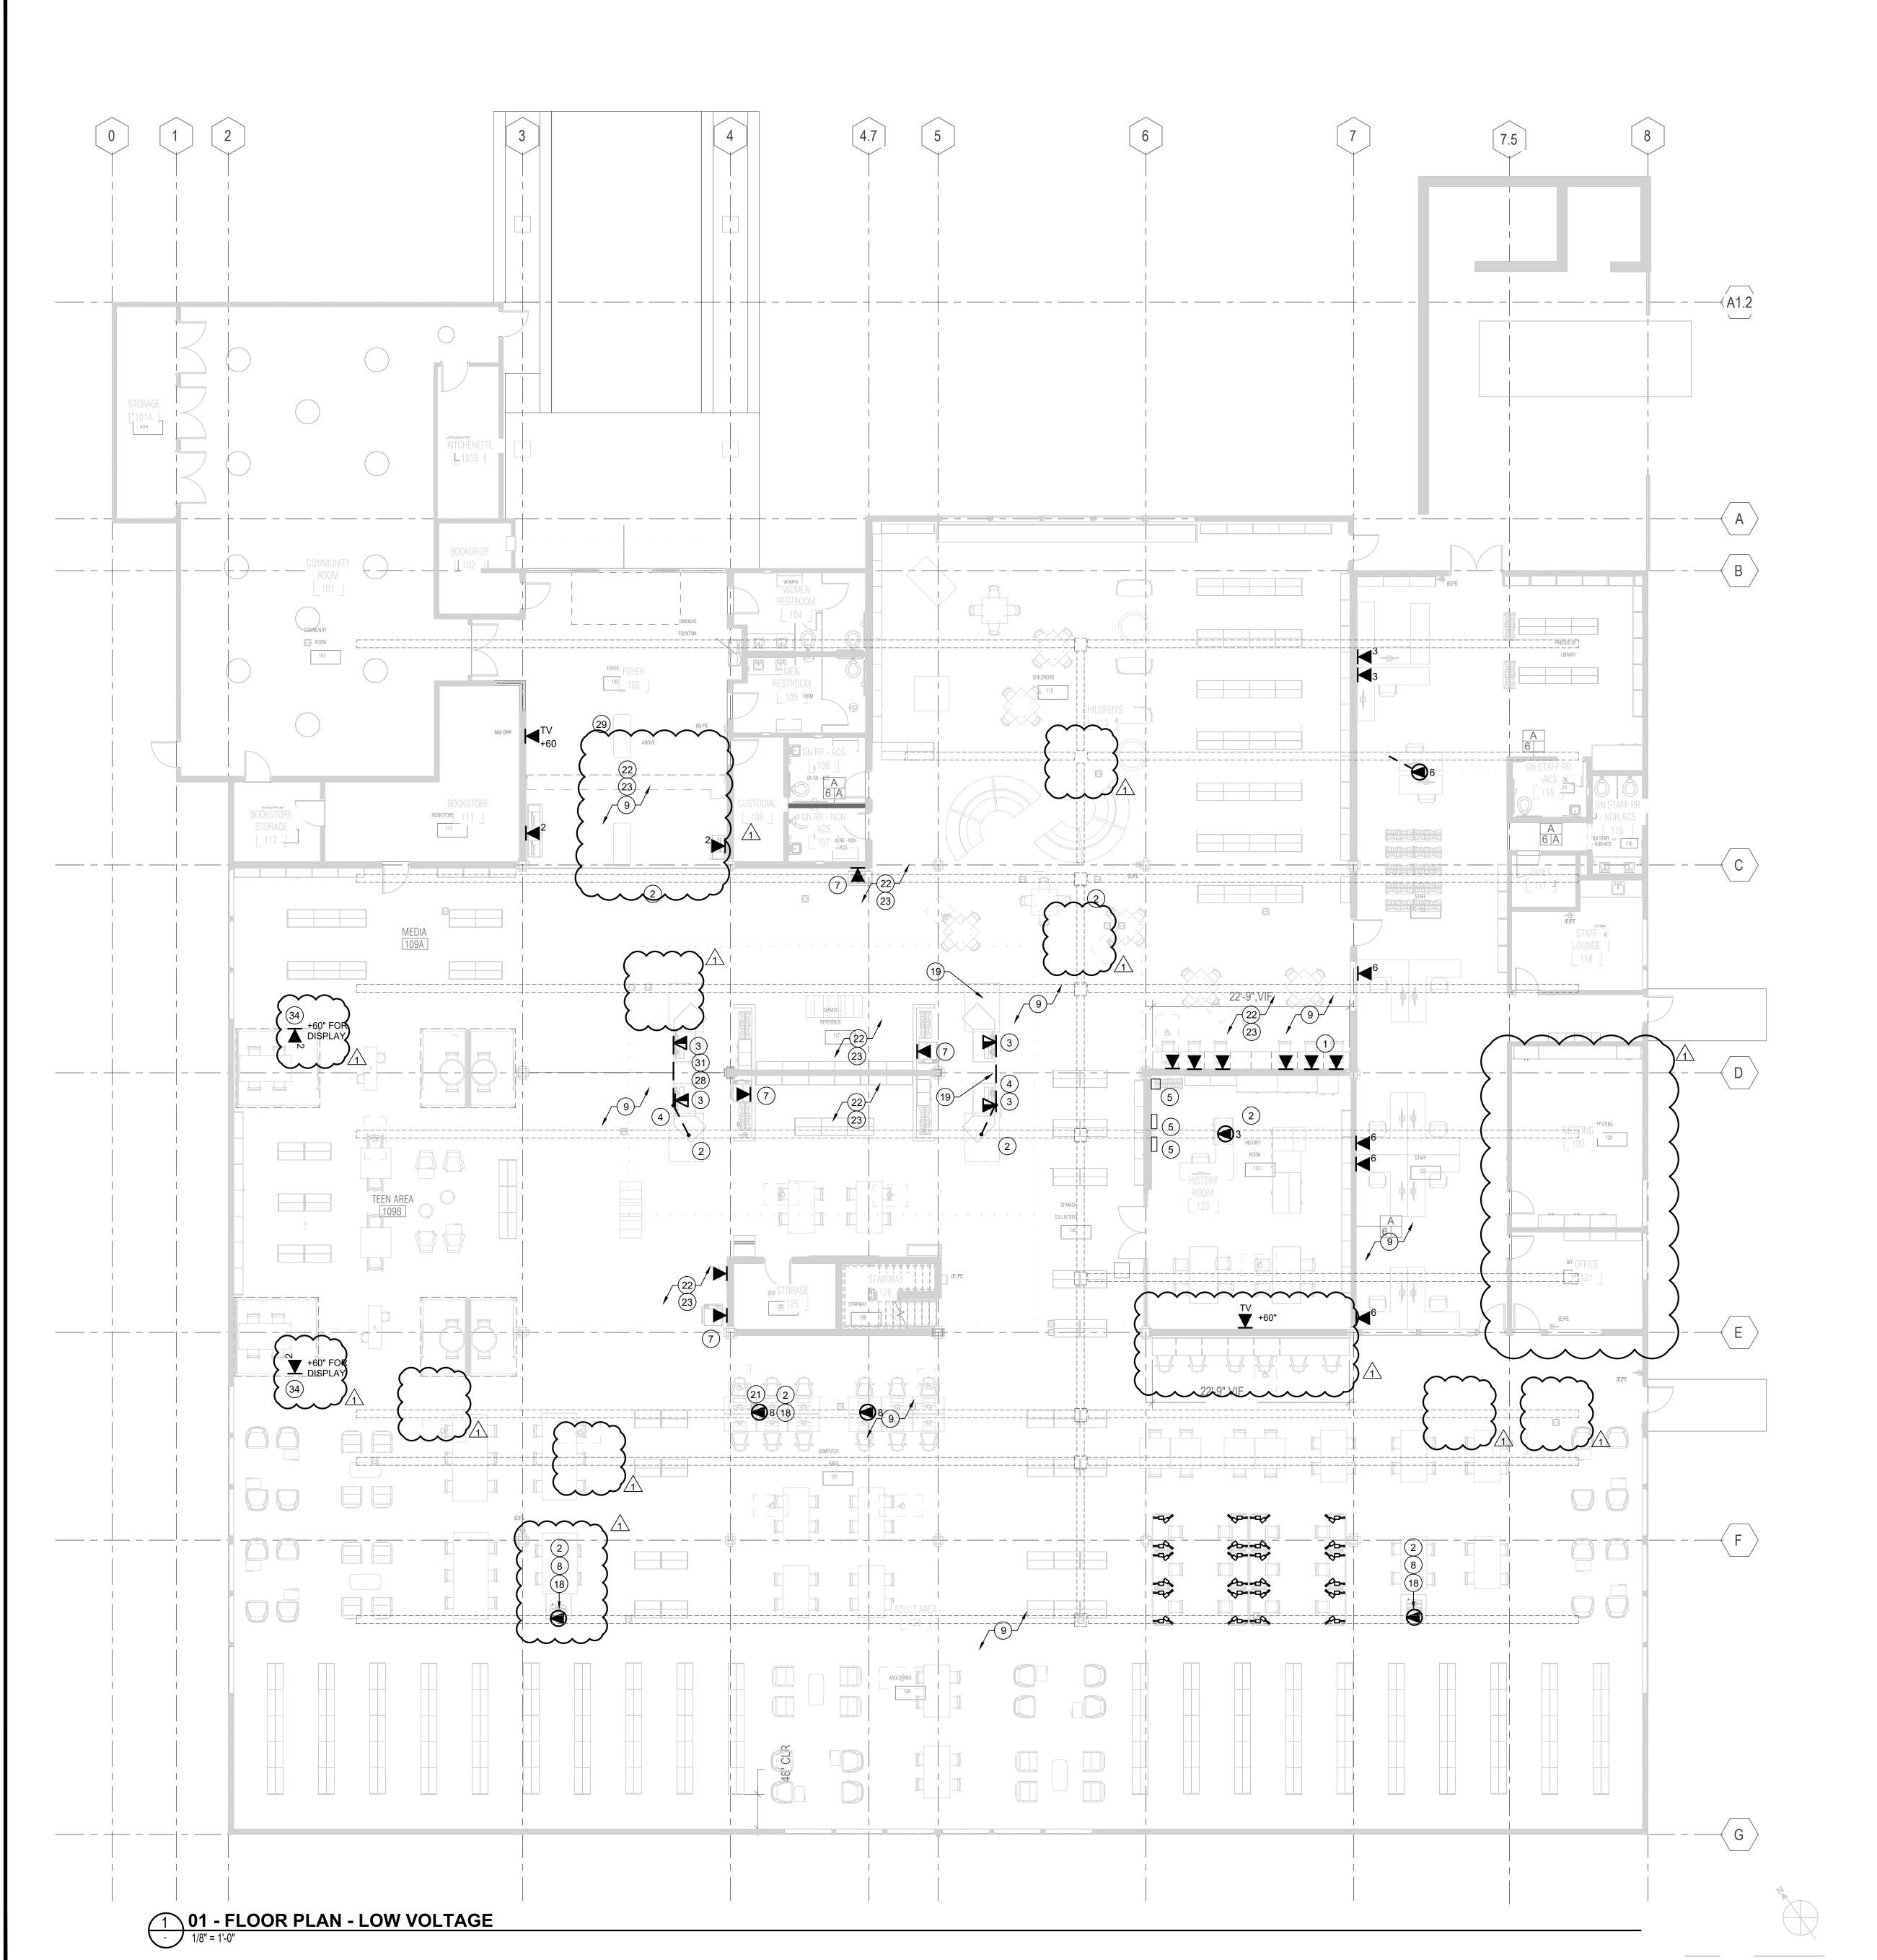

- NEW COMPUTER STATION OUTLETS COORDINATE HEIGHT WITH ELECTRICAL POWER, CABLES ROUTE TO MEZZ LEVEL FOR TERMINATION VIA DUCT
- (E) DUCT CHANNEL OR RACEWAY IN SLAB, COORDINATE WITH ELECTRICAL POWER ,TYPICAL
- TERMINATE OUTLETS FOR VOICE AND DATA IN CASEWORK, COORDINATE WITH POWER
- TELECOM JUNCTION AND CONDUIT IN CASE WORK TO FEED OUTLETS, COORDINATE WITH ELECTRICAL POWER
- 5 EXISTING T/C AND CONDUIT RISER FROM FLOOR , CABLES TERMINATE AT MEZZ. LEVEL.
- 6 EXISTING FLOOR OUTLETS INSTALL NEW CABLES TO FEED 8 STATIONS AT THIS LOCATION, TYPICAL
- (7) NEW WALL STATIONS FOR NETWORK CONNECTED **EQUIPMENT**
- 8 NEW FLOOR OUTLETS FOR ELECTRONIC CARD CATALOG STATIONS
- 9 ALL CABLES TERMINATE AT MEZZ. LEVEL
- EXISTING OPEN FRAME RACK FOR TERMINATION OF CABLES FROM NEW OUTLETS

(11) EXISTING SECURITY PANELS

- (12) EXISTING PLYWOOD ON BACK AND SIDE WALLS
- 66 BLOCKS AND CROSS CONNECTIONS ON THIS WALL
- (14) SLEEVES THRU WALL ADD AS REQUIRED
- (15) HOLES CORED THRU WALL, ADD AS REQUIRED
- (16) CATV INCOMING SERVICE TERMINATION LOCATION
- (17) EXISTING LADDER RACK
- (18) CONNECT AND ROUTE TO IN FLOOR RACEWAY NEW CONDUITS IN SLAB FOR DATA CONNECTIONS TO COMPUTERS/WORK STATIONS
- (20) NO WORK IN THIS AREA U.O.N.
- (21) EXISTING POWER OR DATA OUTLET MONUMENTS
- 22 ALL EXPOSED CONDUITS OR WIREWAY SHALL BE PAINTED TO MATCH COLOR OF EXISTING WOOD PANELS AND ARCHITECTURAL FEATURES, TYPICAL
- EXPOSED CONDUITS OR WIREWAYS SHALL BE ROUTED HORIZONTAL ON WALLS IF OUTLIETS AS ROUTED HORIZONTAL ON WALLS IF OUTLETS ARE LOW TO A VERTICAL RISER BEAM THEN ON TO BEAM AND TO MEZZ. LEVEL EXPOSED CONDUITS IN A SINGLE LOCATION AS FOR TV'S ETC. SHALL BE ROUTED VERTICAL TO BEAM HT. THEN ALONG BEAMS TO MEZZ. LEVEL.
- (24) EXISTING FIRE ALARM TERMINAL CABINET
- 25) EXISTING PAGING AND PHONE SPLICE TERMINAL CABINET

- RELOCATE EXISTING PAGING AMPLIFIER TO (26) MEZZANINE ON A WALL SHELF NEXT TO THE SERVER RACK.
- RUN NEW 20GA SPEAKER CABLE TO THE SPEAKER TERMINAL CABLING AND TONE OUT ALL SPEAKER CIRCUITS AND CONNECT
- RELOCATE PANIC BUTTON AND CABLE TO THIS THIS LOCATION, MATCH AS REMOVED MOUNTING
- RELOCATE TONE GENERATOR TO AMP AT MEZZ. LEVEL.
- INSTALL NEW WIRE FOR PANIC BUTTON TO (30) CONTROL PANEL IN STAFF HALLWAY
- PROVIDE NEW PUSH TO TALK BOGEN DESK MIC AT THIS LOCATION FOR PAGING, RUN NEW 3C SHIELDED CABLE TO AMP AT MEZZ. LEVEL.. INSTALL SAME AS REMOVED CONDITION AND
- (32) LOCATE PAGING AMP NEAR THIS RACK ON WALL
- TONE OUT AND TEST PAGING SYSTEM PRIOR TO (33) DEMO TO ENSURE ALL SPEAKERS ARE WORKING
- ROUTE NEW CONDUIT FEEDS ALONG BEAMS FROM UPSTAIRS MDF ROOM TO FEED ORANGE BOXES

#### **GENERAL NOTES:**

MOUNTING

- 1. CONDUIT RUNS IF SHOWN ARE DIAGRAMMATIC IN NATURE AND SHALL BE FIELD COORDINATED FOR FORM FIT AND **FUNCTION**
- 2. LOCATIONS OF FLOOR DUCTING, OUTLETS ETC ARE APPROXIMATE AND SHALL BE COORDINATED WITH ACTUAL EQUIPMENT LOCATIONS
- 3. LOCATIONS OF EXISTING MONUMENTS, ETC. ARE APPROXIMATE AS SHOWN
- 4. CONCEAL ALL NEW OUTLETS AND CONDUIT AND CABLING WHERE POSSIBLE.
- IN NEW CASE WORK INSTALL NEW CONDUITS AND CABLING FLUSH INTO CASE WORK,

COORDINATE ARCHITECTURAL FEATURES


AND REQUIREMENTS IN THE FIELD

- NEW CONDUITS OR WIREWAYS SHALL BE ROUTED TIGHT TO WALLS AND CORNERS TO MAINTAIN CLEAR ARCHITECTURAL
- FEATURES ARE MAINTAINED ALL WORK ON THIS SHEET IS NEW U.O.N.





MEZZANINE - IDF IMAGE

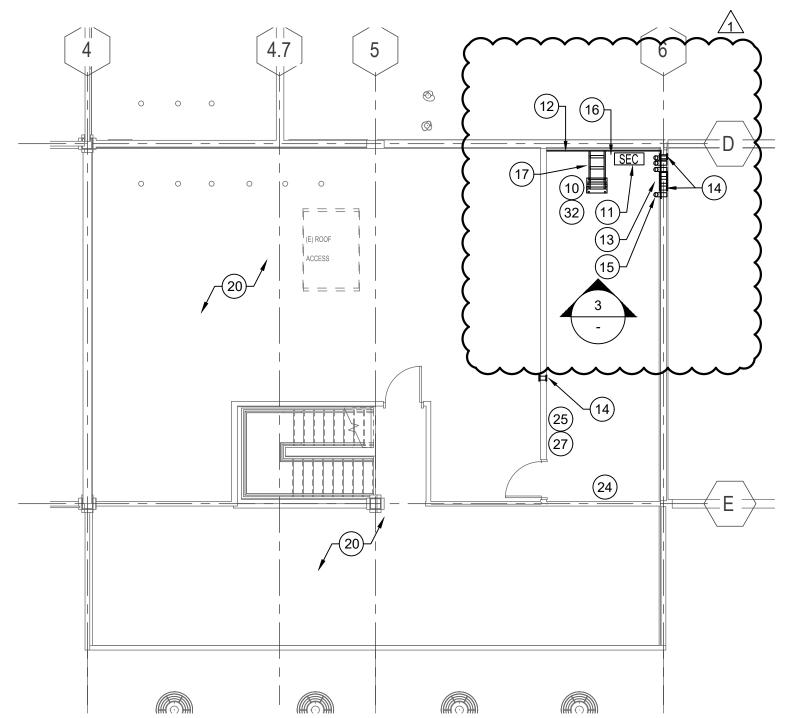


MEZZANINE - FLOOR PLAN

1/8" = 1'-0"

# ARCHITECTS

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PROJECT TITLE

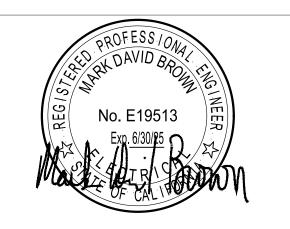SONOMA COUNTY **PETALUMA REGIONAL LIBRARY** RENOVATION PROJECT NO.

100 FAIRGROUNDS DRIVE PETALUMA, CA 94952

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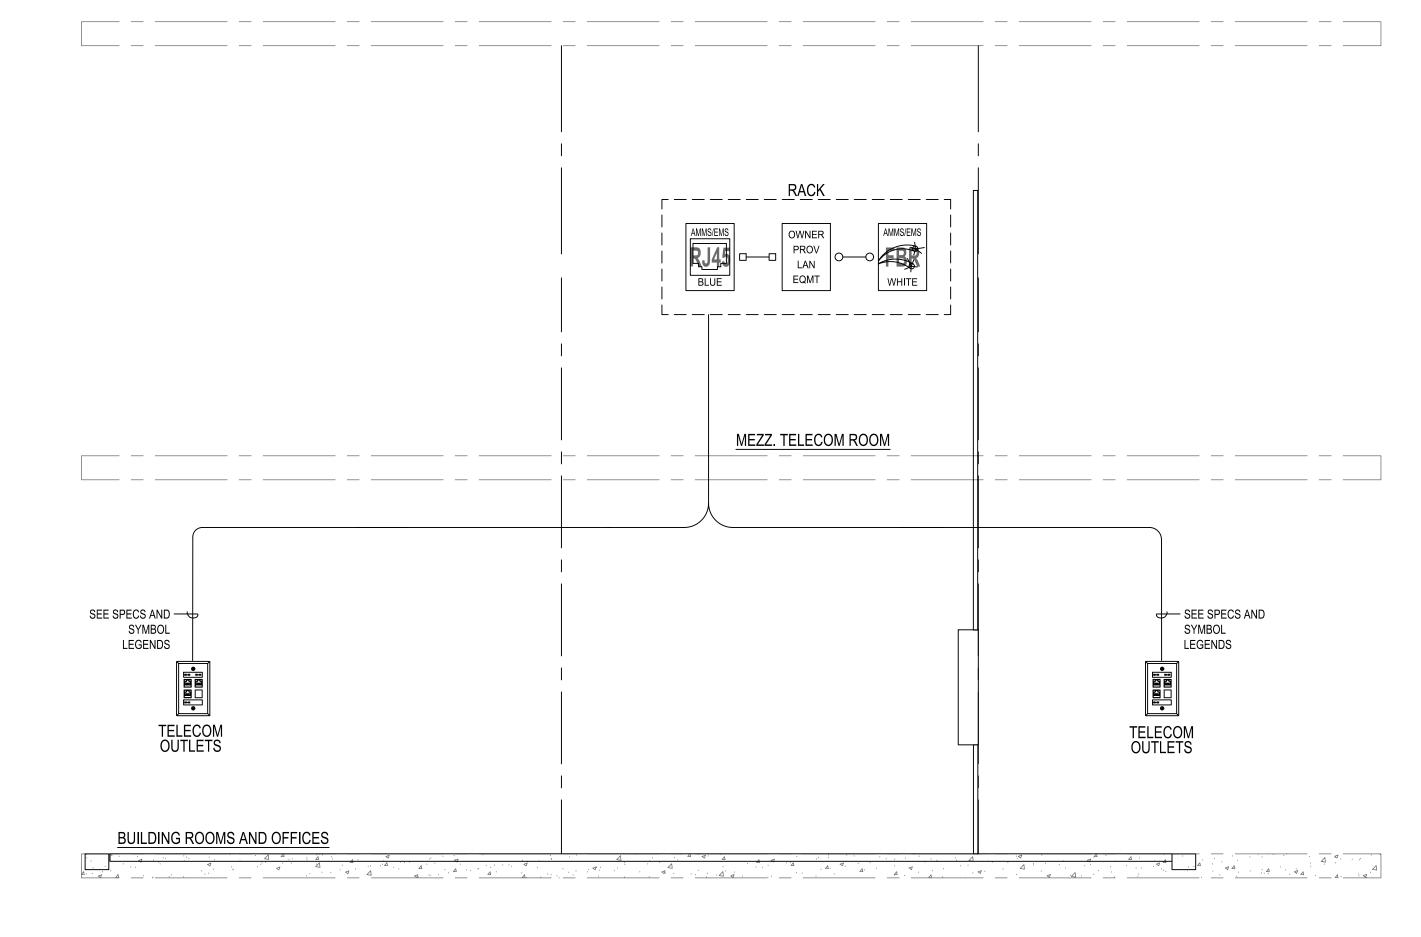
05/03/2024

Shums Coda Associates

FLOOR PLAN - 1ST FLOOR AND MEZZANINE - LOW VOLTAGE


SHEET NUMBER

T2.31



1 TYPICAL COPPER NETWORK RISER DIAGRAM
SCALE: NONE



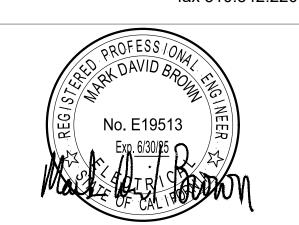



PROJECT TITLE

PETALUMA
REGIONAL
LIBRARY
RENOVATION
PROJECT NO.
10-19

100 FAIRGROUNDS DRIVE PETALUMA, CA 94952

PERMIT SET

ISSUE DATE 11/27/2023

N&T JOB NUMBER 21824

REVISIONS

DATE DESCRIPTION

REVIEWED FOR CODE COMPLIANCE


05/03/2024


Shums Coda Associates

BLOCK RISER
DIAGRAMS


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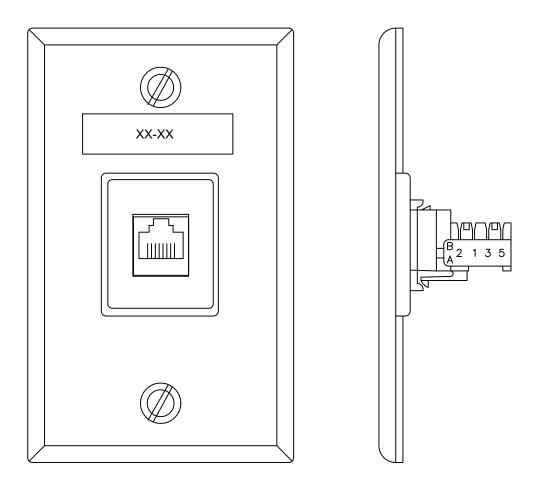
T5.01




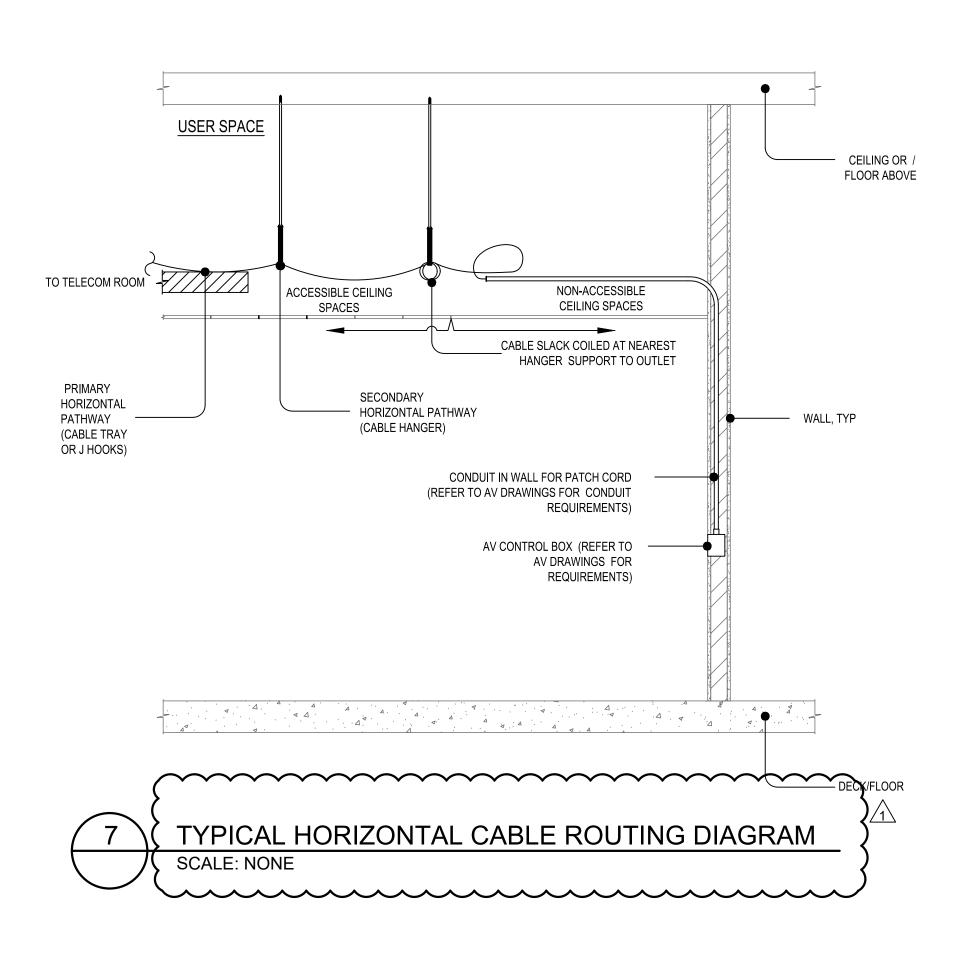

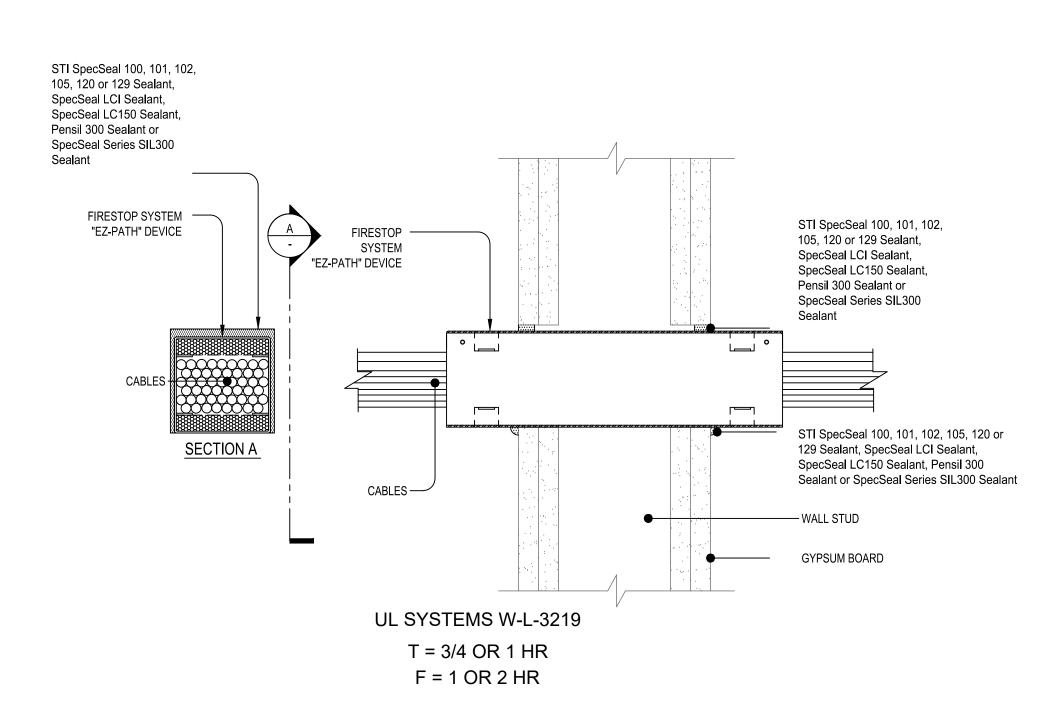




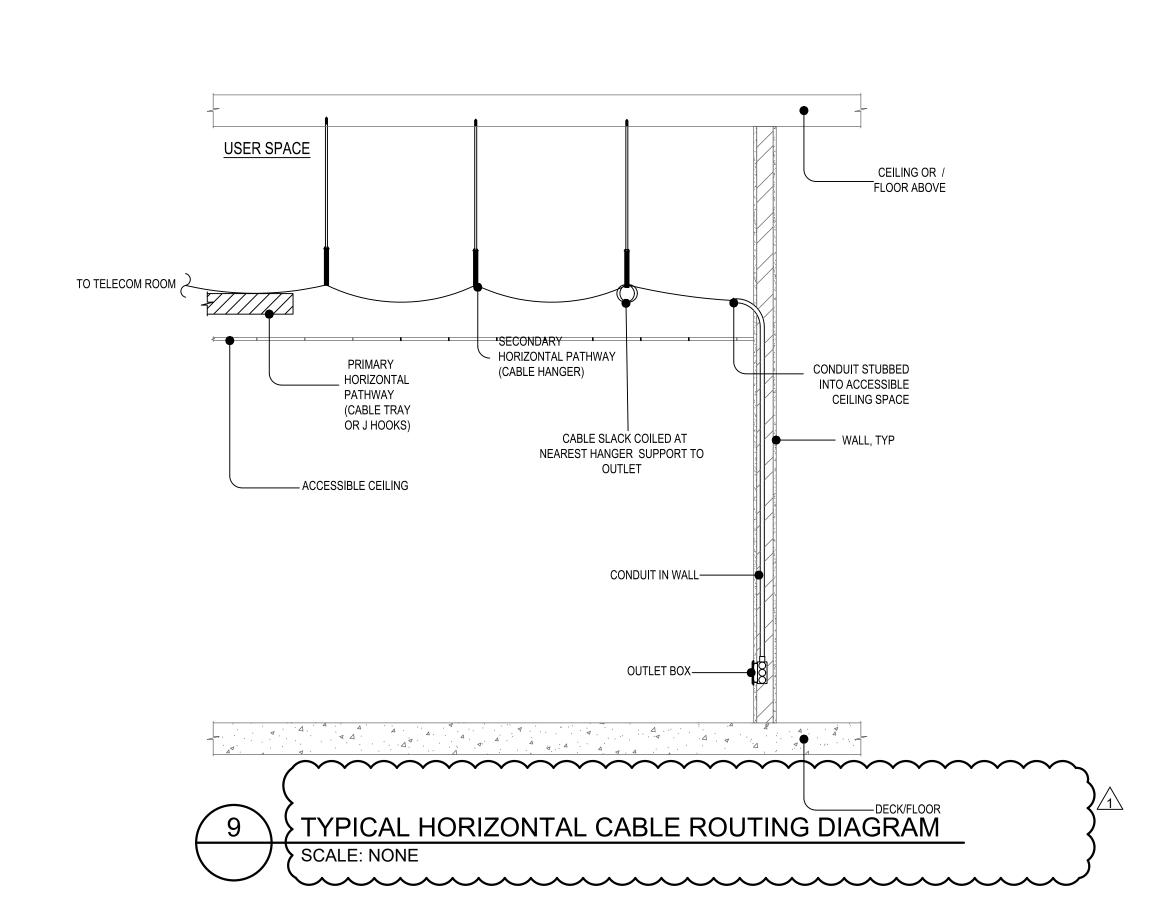

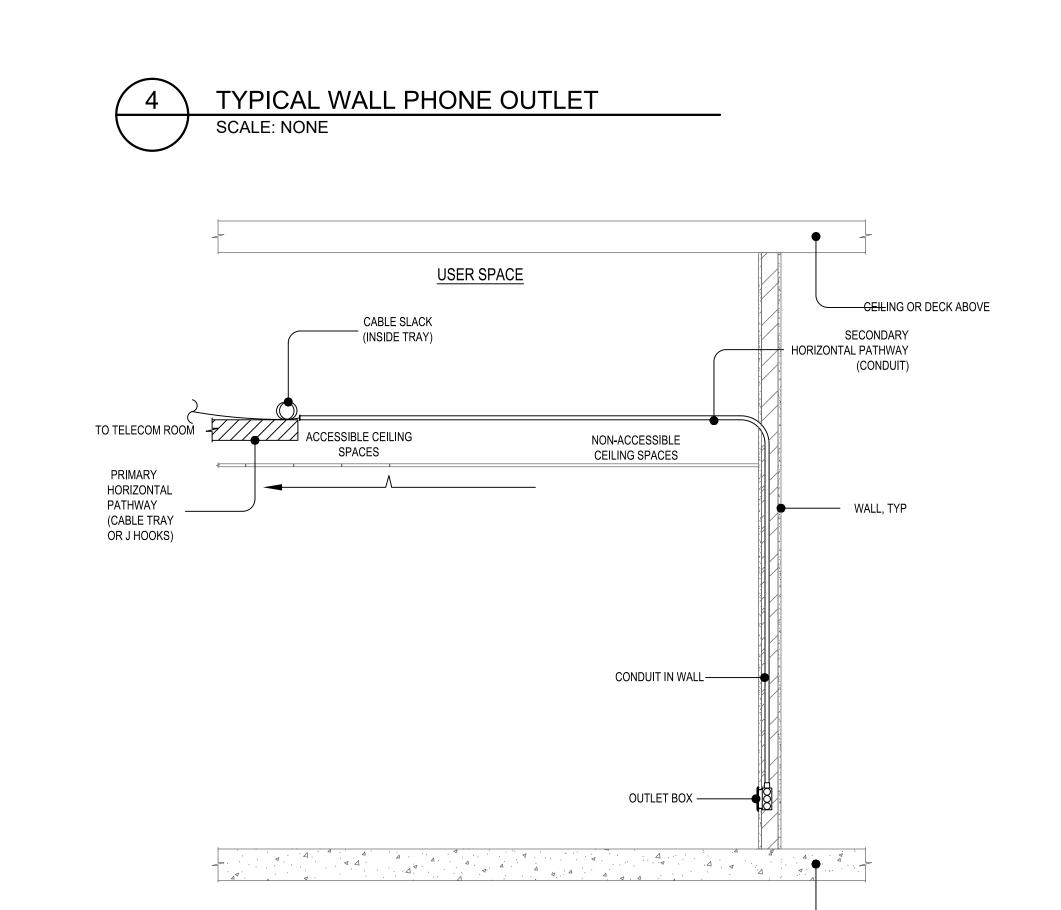



TYPICAL HORIZONTAL CABLE ROUTING DIAGRAM

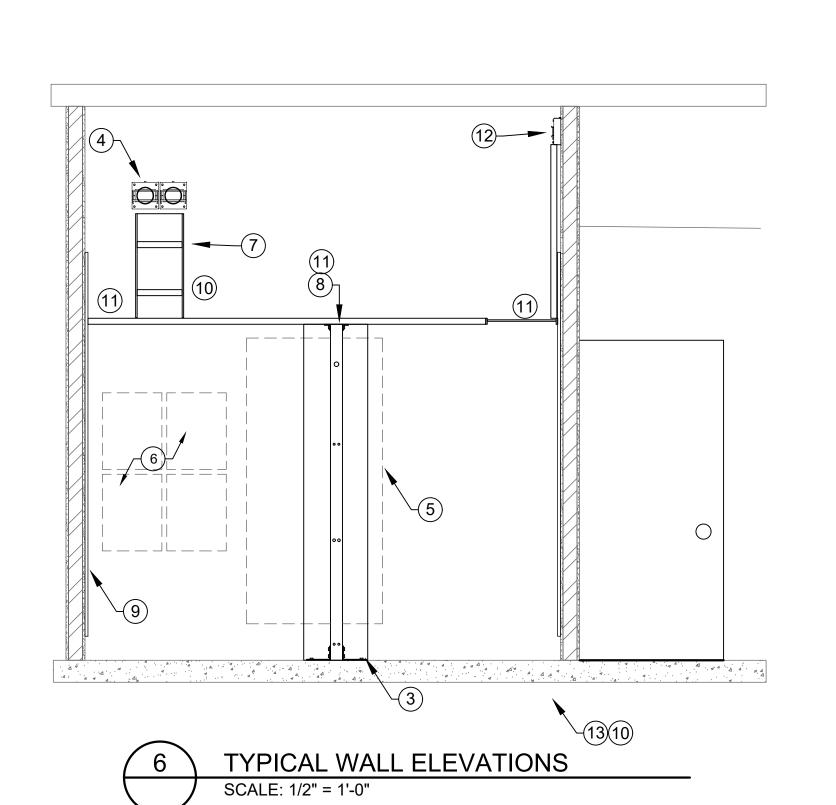


(NON-ACCESSIBLE CEILING)

SCALE: NONE

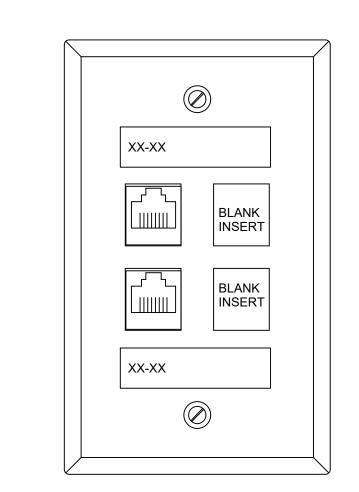

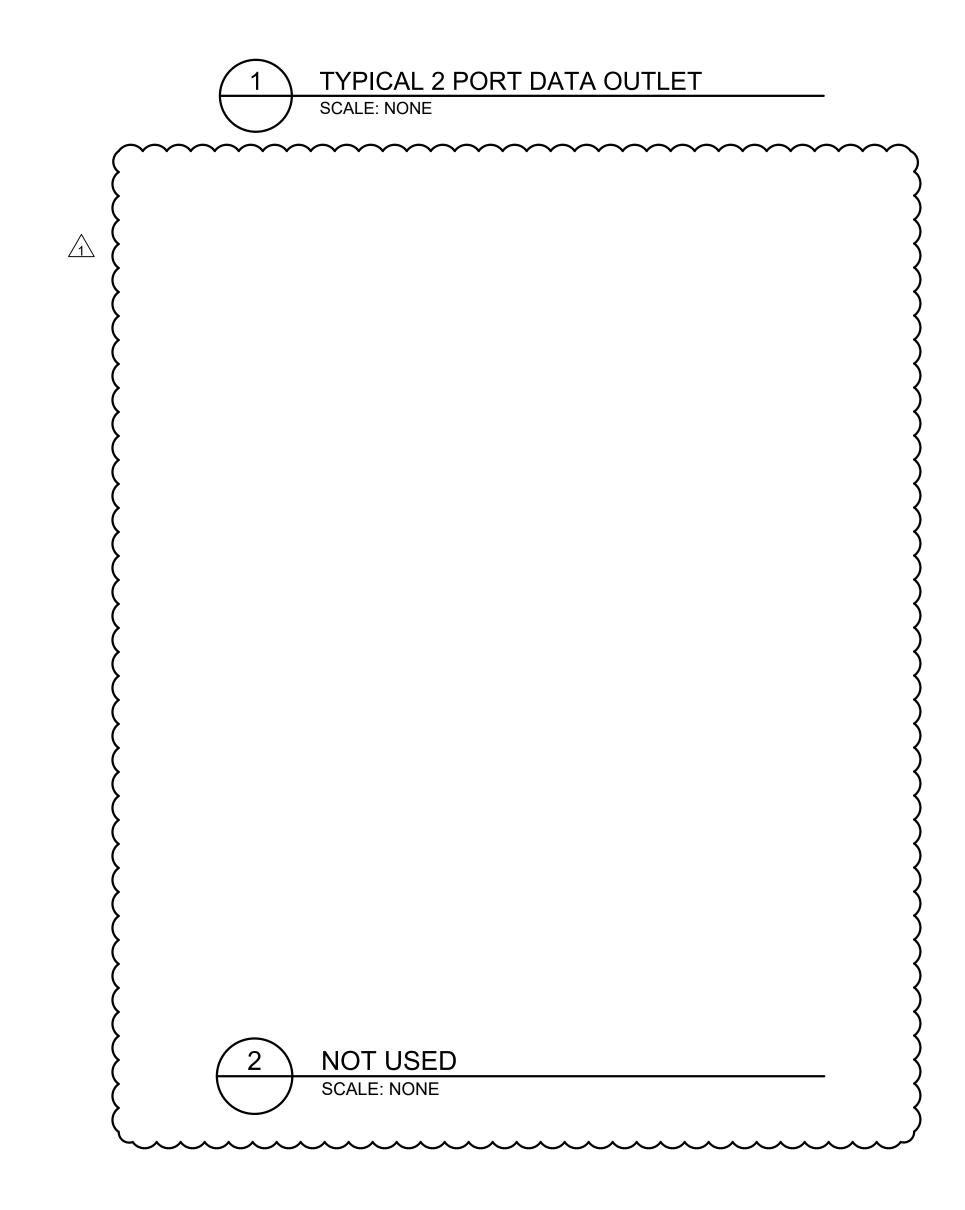



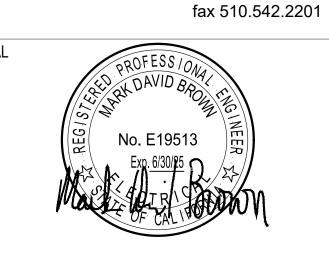



PROJECT TITLE

SONOMA COUNTY **PETALUMA REGIONAL LIBRARY** RENOVATION PROJECT NO. 10-19

100 FAIRGROUNDS DRIVE PETALUMA, CA 94952

**PERMIT SET** N&T JOB NUMBER

# DATE 1 01/22/24 RESUBMITTAL

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DESCRIPTION

SHEET TITLE **DETAILS** 

SHEET NUMBER

APPROVALS

T7.01


TYPICAL WALL ELEVATIONS SCALE: 1/2" = 1'-0"

SEC. KVM -



DECK/FLOOR

- 1 TYPICAL 6" WIDE VERTICAL WIRE MANAGER
- (2) TYPICAL 19" X 84" OPEN FRAME RACK
- 3 SECURE FRAME TO FLOOR WITH 3/8" MIN. HILTI QUIK BOLT 3 FASTENERS (4) LOCATIONS EACH FRAME (TYPICAL)
- TYPICAL FLAME STOPPERS ON CONDUIT FEEDERS AND SECTION TIE
- (5) TYPICAL CLEARANCE AREA AROUND FRAME
- TYPICAL SECURITY CABINET AND TERMINATION AREA FOR EQUIPMENT AND CABLING.
- 7) TYPICAL VERTICAL LADDER RACK FOR CABLE SUPPORT
- TYPICAL HORIZONTAL LADDER RACK, WALL OR FRAME MOUNTED
- 9 TYPICAL ¾" PLYWOOD ON WALL AROUND ROOM, ORIENTED IN VERTICAL, 6" OFF FLOOR.
- VERTICAL LADDER RACK FOR CABLE SUPPORT, FIBER AND VOICE TYPICAL LADDER RACK AROUND PERIMETER OF ROOM MOUNTED ON WALL BRACKETS AND OVER TOP OF
- EQUIPMENT FRAMES, SECURE TO WALL AND FRAMES WITH FACTORY ATTACHMENT HARDWARE. (12) TYPICAL FLAME STOPPER SLEEVES

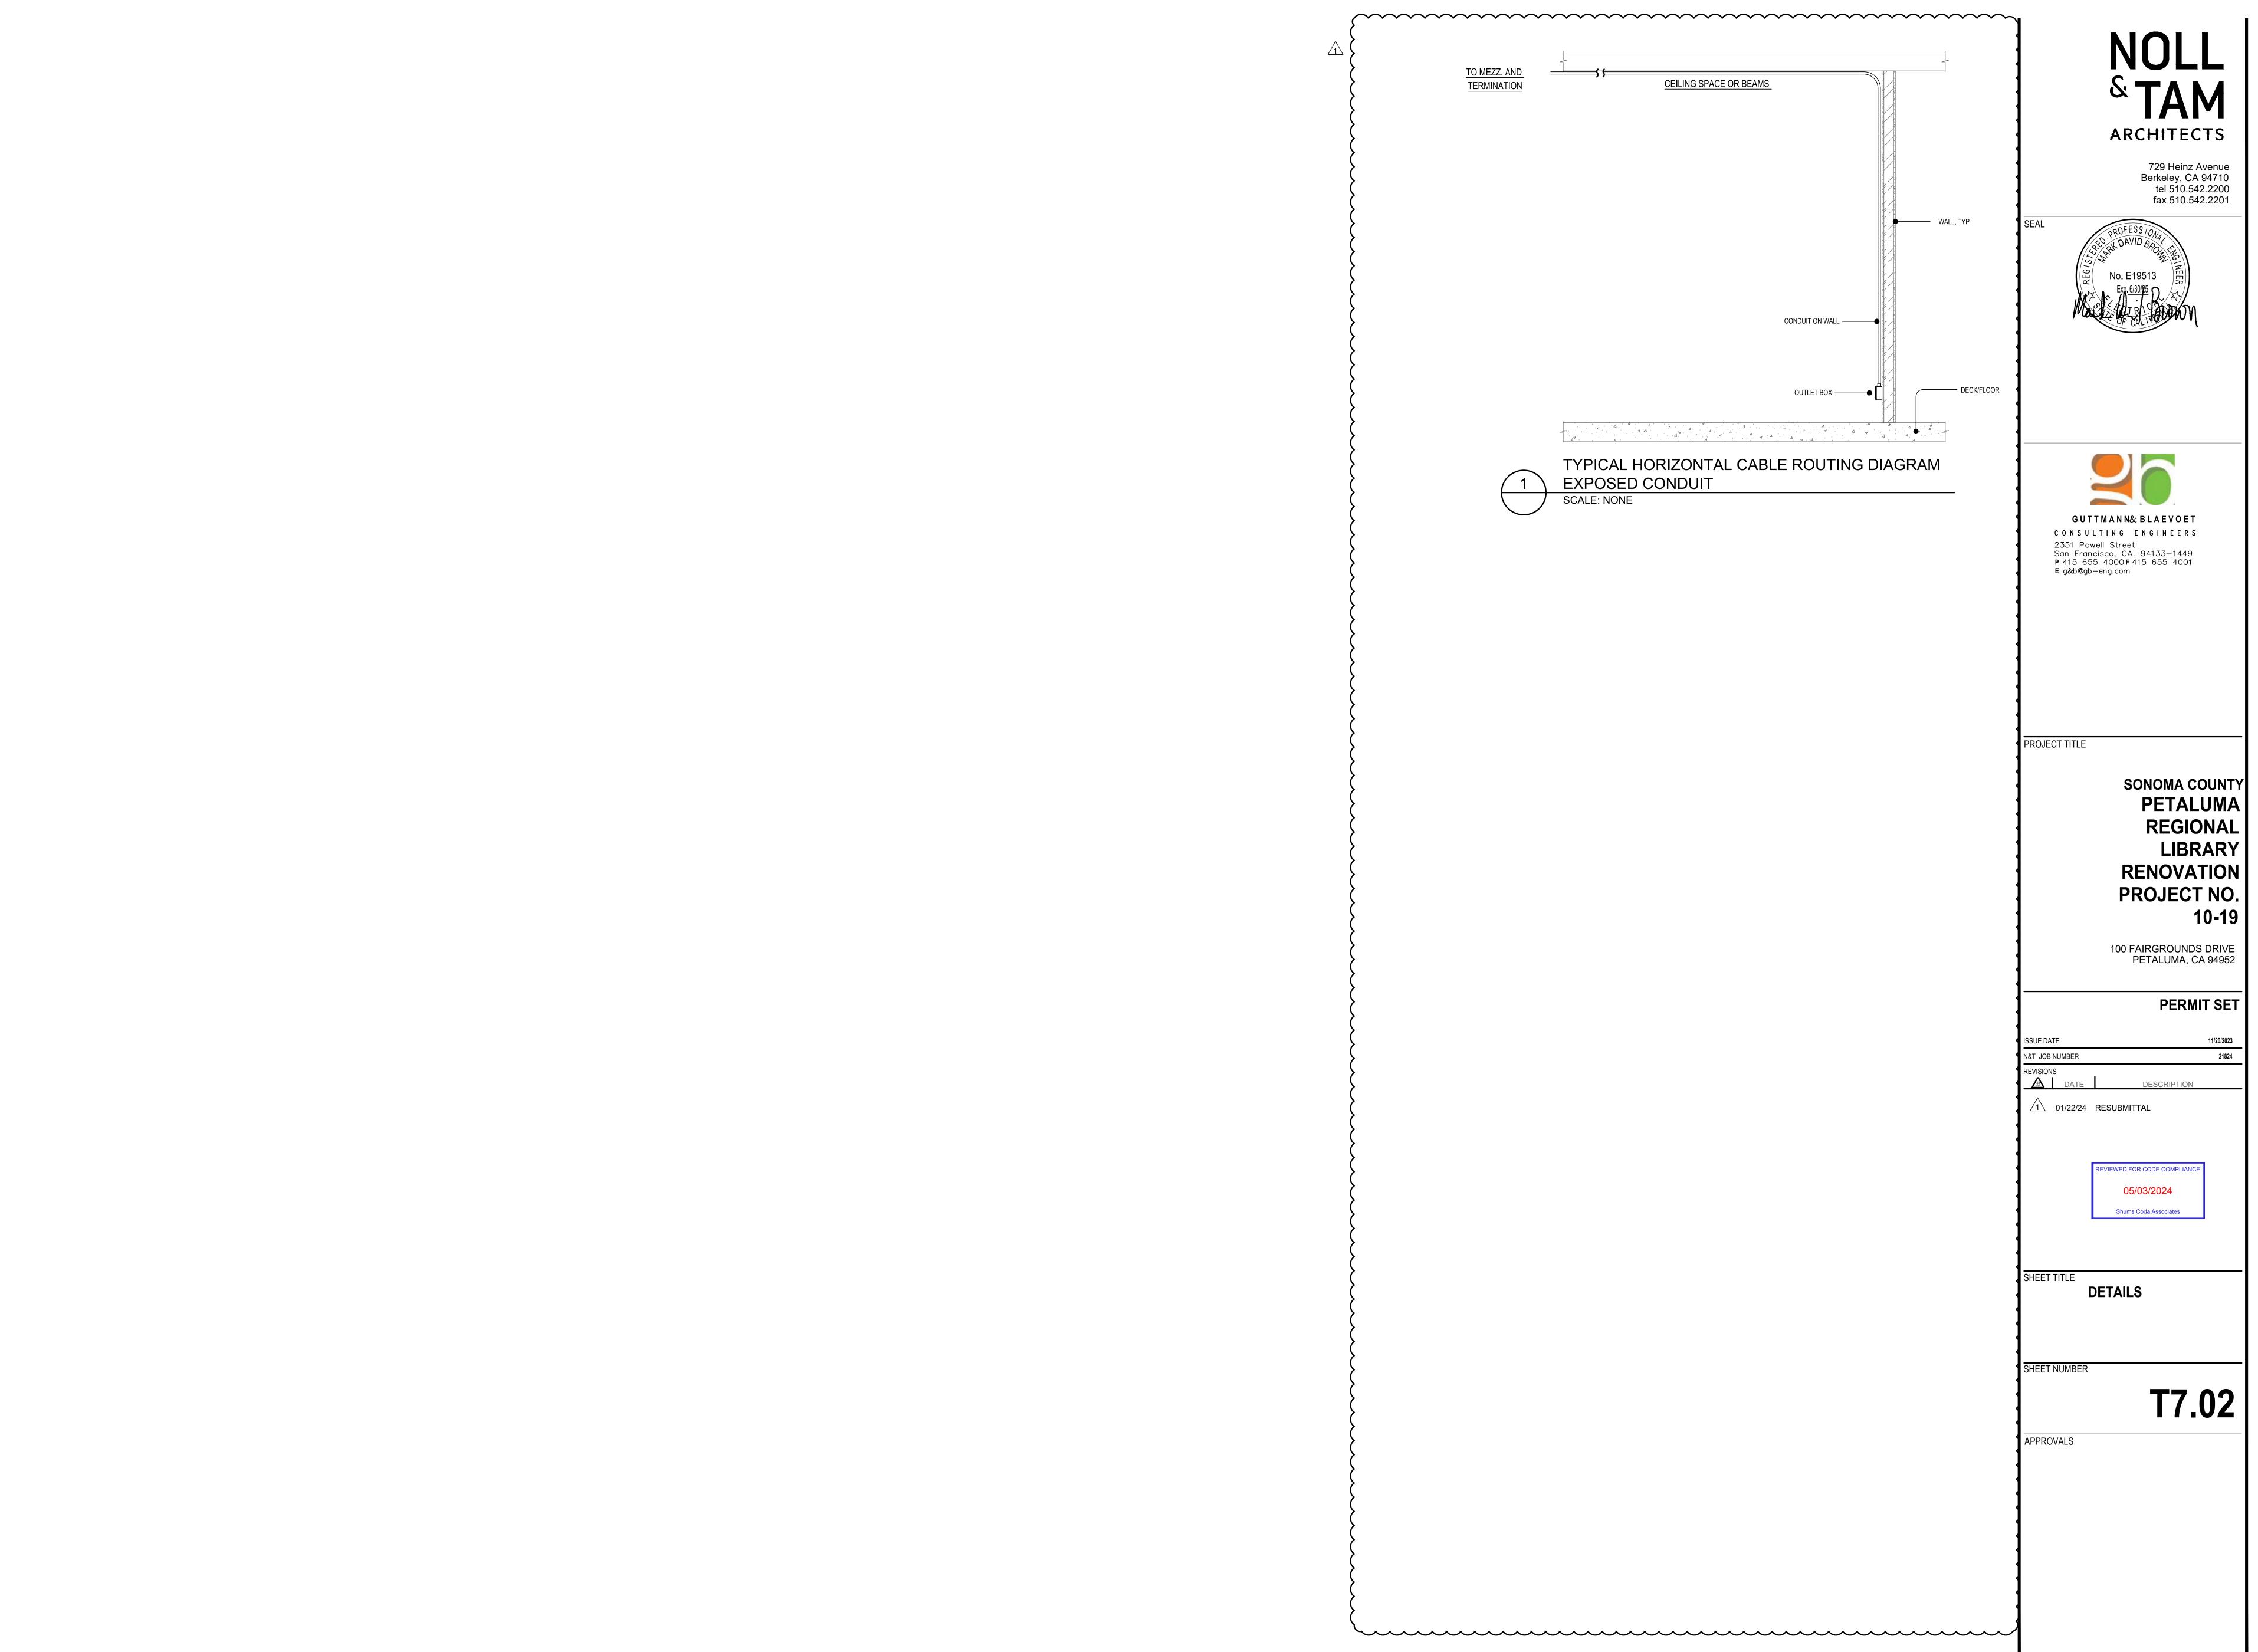

ARCHITECTS

SONOMA COUNTY **PETALUMA REGIONAL LIBRARY RENOVATION** PROJECT NO.

**PERMIT SET** 

#### FIRE PROTECTION SYMBOL LIST

NOTE: This is a standard symbol list and not all items listed may be used.

GATE VALVE

MAXIMUM

NIPPLE AND CAP

NOT IN CONTRACT

NOT TO SCALE

OPEN BAR JOIST

OUTSIDE DIAMETER

PRESSURE SWITCH

**ROOF MANIFOLD** 

OUTSIDE SCREW & YOKE

POST INDICATOR VALVE

PRESSURE REDUCING VALVE


STANDARD SPRAY PENDENT

HORIZONTAL SIDE WALL

#### <u>Abbreviations</u> ABANDON IN PLACE **EXISTING** (F) (N) RELOCATE/RELOCATED LOCATION (X) DEMOLITION AFF ABOVE FINISHED FLOOR AUTOMATIC SPRINKLER BOB **BOTTOM OF BEAM** BOD BOTTOM OF DECK BOP **BOTTOM OF PIPE** BOR BOTTOM OF RISER **BUTTERFLY VALVE** CENTER LINE CV DOUBLE DETECTOR CHECK VALVE ASSEMBLY DN DROP NIPPLE EXTENDED COVERAGE **ELEVATION FAHRENHEIT** FIRE DEPARTMENT CONNECTION FINISHED FLOOR FFL FLOOR FLANGE FIRE HOSE CABINET FHS FIRE HOSE STATION FS FLOW SWITCH

SSU	STANDARD SPRAY UPRIGHT	
ТОВ	TOP OF BEAM	
TOP	TOP OF PIPE	
TOR	TOP OF RISER	
TOS	TOP OF STEEL	
TS	TAMPER SWITCH	
TYP	TYPICAL	
UNO	UNLESS NOTED OTHERWISE	
<u>Contr</u>	<u>ol</u>	
$\bigcap$	BELL/GONG	
	CONTROL PANEL	
F	FLOW DETECTION SWITCH	
M	MONITOR SWITCH	
0	PRESSURE GAUGE	
Ţ	TAMPER DETECTOR	
$\widehat{\uparrow}$	WATER MOTOR ALARM	
Gene	<u>ral</u>	

	Ŷ	WATER MOTOR ALARM
	General	
	$\langle x \rangle$	KEYED NOTE
<u></u>	A	SECTION NUMBER AND SHEET LOCATION
	Miscelland	<u>eous</u>
	\ \	2-WAY SWAY BRACE
	-	4-WAY SWAY BRACE

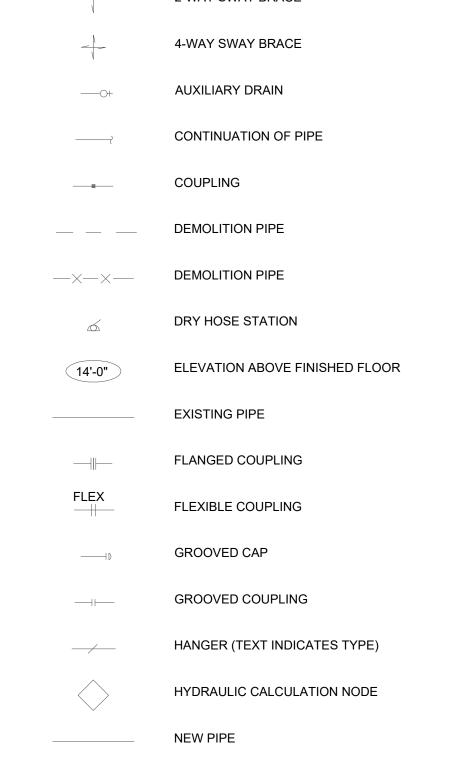


PIPE DROP


POINT OF CONNECTION

———— PIPE RISE

	SCREWED CAP
<b>─</b>	SCREWED PLUG
	UNION
<u> 6</u>	WET HOSE STATION
Carialda	r Uaada
Sprinkle	<u>neaus</u>
•	2-PC PENDENT SPRINKLER
<b></b>	UPRIGHT SPRINKLER
•	RECESSED PENDENT SPRINKLER
<u>Valves</u>	
	ALARM CHECK VALVE, ELEVATION VIEW
	ALARM CHECK VALVE, PLAN VIEW
	ANGLE VALVE
	CHECK VALVE
	DELUGE VALVE
	DRY PIPE VALVE, PLAN VIEW
	INDICATING BUTTERFLY VALVE
$\bowtie$	NON-RISING STEM VALVE
	PREACTION VALVE
	VALVE WITH TAMPER SWITCH

Water S	Service
	DOUBLE CHECK BACKFLOW PREVENTER
4	FIRE DEPARTMENT CONNECTION
<b>%</b>	FREE STANDING F.D. CONNECTION
<u></u>	O.S.&Y. VALVE
	POST INDICATOR VALVE

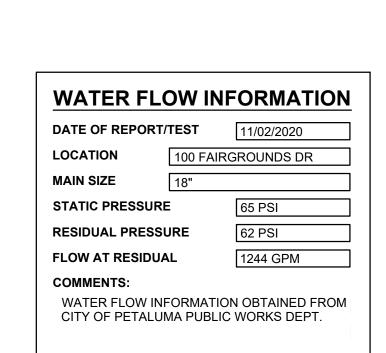

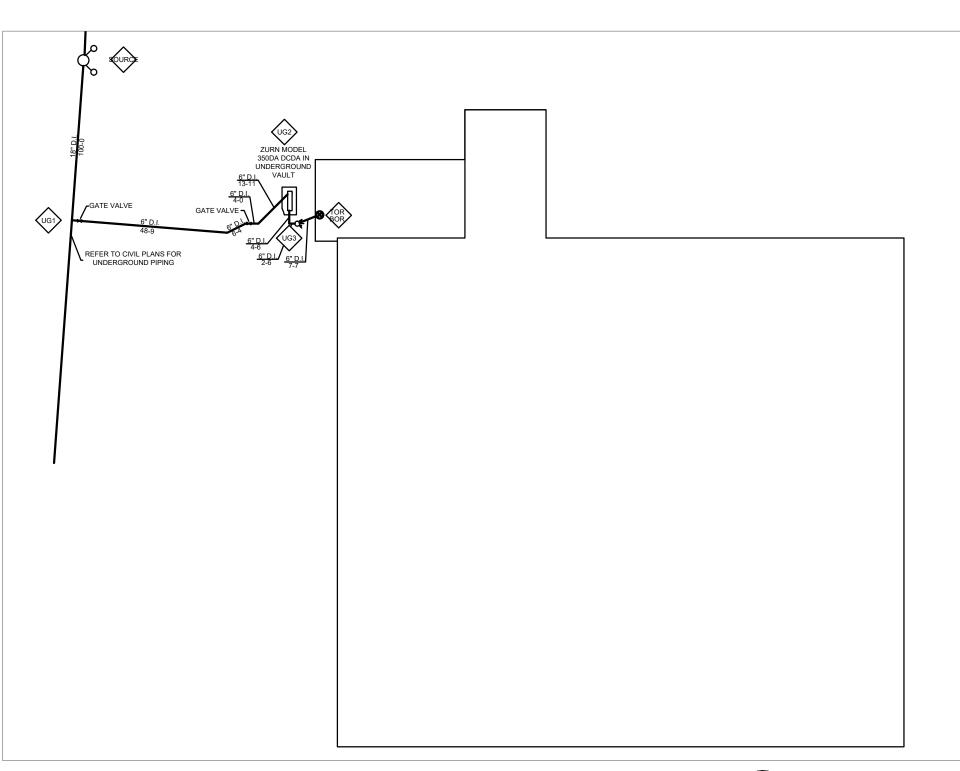





# **GENERAL FIRE PROTECTION NOTES**

- 1. SCOPE OF WORK IS TO EXTEND EXISTING WET PIPE SPRINKLER SYSTEM THROUGHOUT THE BUILDINGS. DRAWINGS SHOWN HERE ARE CONCEPTUAL AND NOT INTENDED TO SHOW SPRINKLER SYSTEM IN ITS ENTIRETY. CONTRACTOR TO REFER TO SPECIFICATIONS, PREPARE SHOP DRAWINGS, HYDRAULIC CALCULATIONS, BRACING CALCULATIONS, AND MATERIAL DATA SHEETS AND SUBMIT TO THE ARCHITECT AND AHJ FOR REVIEW AND APPROVAL. PLANS MUST BE APPROVED BY THE AHJ AND REVIEWED BY THE ARCHITECT BEFORE ANY PIPE IS HUNG.
- 2. CONTRACTOR TO SHOW LOCATIONS OF ALL HANGERS, RESTRAINTS, AND BRACING ON PLANS. ROUTE PIPE TIGHT TO STRUCTURE AND PROVIDE END OF BRANCH LINE RESTRAINTS AS NEEDED PER DETAIL 6 ON SHEET FP6.02. HANGER SPACING IS 8' ON CENTER THROUGHOUT OVERHEAD LEVEL BRANCH LINE PIPE UNLESS OTHERWISE NOTED.
- 3. DESIGN TO MEET REQUIREMENTS OF NFPA 13 (2022 EDITION), CBC (2022 EDITION).
- 4. NFPA 13, SECTION 10.10.2.1.1, UNDERGROUND MAINS AND LEAD-IN CONNECTIONS TO SYSTEM RISERS SHALL BE COMPLETELY FLUSHED BEFORE CONNECTION IS MADE TO OVERHEAD SPRINKLER
- 5. PROVIDE FLOW TEST DATA AND INDICATE THE LOCATIONS AND HEIGHT ELEVATIONS OF THE TEST AND RESIDUAL FLOW HYDRANTS. DATA MUST BE NO MORE THAN 6 MONTHS OLD AND PROVIDE INFORMATION ABOUT AVAILABLE WATER AT THE SITE. INFORMATION MAY COME FROM THE LOCAL WATER PURVEYOR, UTILITIES COMPANY, OR LOCAL FIRE DEPARTMENT.
- 6. FIRE PROTECTION CONTRACTOR SHALL AFFIX THEIR SEAL AND STAMP AND SIGN ALL SUBMITTAL
- 7. 2022 NFPA 13 SECTION 6.10.1: A COPY OF COMPLETED AND SIGNED "CONTRACTOR'S MATERIALS AND TEST CERTIFICATE FOR UNDERGROUND / ABOVE GROUND PIPING" SHALL BE INCLUDED IN SUBMITTAL.
- 8. 2022 NFPA 13 6.10.2.2.1: ALL PIPING AND ATTACHED APPURTENANCES SUBJECTED TO SYSTEM WORKING PRESSURE SHALL BE HYDROSTATICALLY TESTED AT 200 PSI, OR 50 PSI ABOVE WORKING PRESSURE, WHICHEVER IS GREATER, AND SHALL MAINTAIN WITHOUT LOSS FOR 2 HOURS.
- 9. 2022 NFPA 13 SECTION 16.2.7: PROVIDE SPARE SPRINKLER HEAD CABINET, SPRINKLER WRENCH, AND NO FEWER THAN 6 SPARE SPRINKLER HEADS MATCHING THE TYPES AND TEMPERATURE RATING IN EACH PROTECTED AREA FOR SYSTEMS LESS THAN 300 SPRINKLERS (12 SPARE
- 10. 2022 NFPA 13 SECTION 18.6.3: THE END SPRINKLER ON EACH LINE SHALL BE RESTRAINED AGAINST EXCESSIVE VERTICAL AND LATERAL MOVEMENT.

SPRINKLER HEADS FOR SYSTEMS 300 TO 1,000 SPRINKLERS).

SHEET INDEX

FP0.01 SYMBOL LIST AND GENERAL NOTES - FIRE PROTECTION

FP3.21 BUILDING SECTIONS - FIRE PROTECTION

FP3.22 BUILDING SECTIONS - FIRE PROTECTION

FP6.01 DETAILS - FIRE PROTECTION

FP6.02 DETAILS - FIRE PROTECTION


FP2.41 REFLECTED CEILING PLAN - FINISHED CEILINGS (LOWER) - FIRE PROTECTION

FP2.42 REFLECTED CEILING PLAN - OVERHEAD VAULTED CEILINGS - FIRE PROTECTION

- 11. 2022 NFPA 29.2.3.1: THE SPRINKLER FLOW SWITCH SHALL BE TESTED TO CONFIRM THAT WHEN THE INSPECTORS TEST VALVE IS ACTIVATED AN ALARM WILL SOUND NO MORE THAN 90 SECONDS AFTER INITIAL FLOW. (WITNESSED BY THE PROJECT INSPECTOR)
- 12. PER CBC, SECTION 904.4.3: CONNECTIONS TO PROTECTED PREMISES AND SUPERVISING STATION FIRE ALARM SYSTEMS SHALL BE TESTED TO VERIFY PROPER IDENTIFICATION AND TRANSMISSION OF ALARMS FROM AUTOMATIC FIRE EXTINGUISHING SYSTEM.
- 13. PER CBC 903.4.1: THE MAIN FIRE ALARM PANEL VALVE MONITORING AND WATER-FLOW ALARM AND TROUBLE SIGNALS SHALL BE DISTINCTLY DIFFERENT AND SHALL BE AUTOMATICALLY TRANSMITTED TO AN APPROVED CENTRAL STATION MONITORING COMPANY.
- 14. PER NFPA 13, SECTION 29.4: A PERMANENT HYDRAULIC CALCULATIONS DESIGN PLACARD SHALL BE ATTACHED TO EACH RISER.

SPRINKLER HEAD LEGEND										
SYMBOL	DESCRIPTION	MODEL NO.	K-FACTOR	ORIFICE SIZE	FINISH	ESCUTCHEON	SIN	NO. OF SPRKS	TEMP	NOTES
•	QR PENDENT	VK302 OR EQUAL	5.6	1/2	CHROME	2-PC	VK302	105	155F	175F@EXTERIOR
0	QR UPRIGHT ON SPRIG	VK300 OR EQUAL	5.6	1/2	BRASS	NONE	VK300	52	175F	
0	QR UPRIGHT	VK300 OR EQUAL	5.6	1/2	BRASS	NONE	VK300	182	155F	
4	QR SIDEWALL	VK305 OR EQUAL	5.6	1/2	WHITE	2-PC	VK305	4	205F	

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PROJECT TITLE

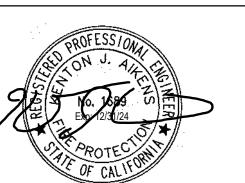**SONOMA COUNTY PETALUMA** REGIONAL **LIBRARY** RENOVATION PROJECT NO.

100 FAIRGROUNDS DRIVE PETALUMA, CA 94952


PERMIT SET

N&T JOB NUMBER DESCRIPTION

SYMBOL LIST AND **GENERAL NOTES** - FIRE PROTECTION

SHEET NUMBER

FP0.01

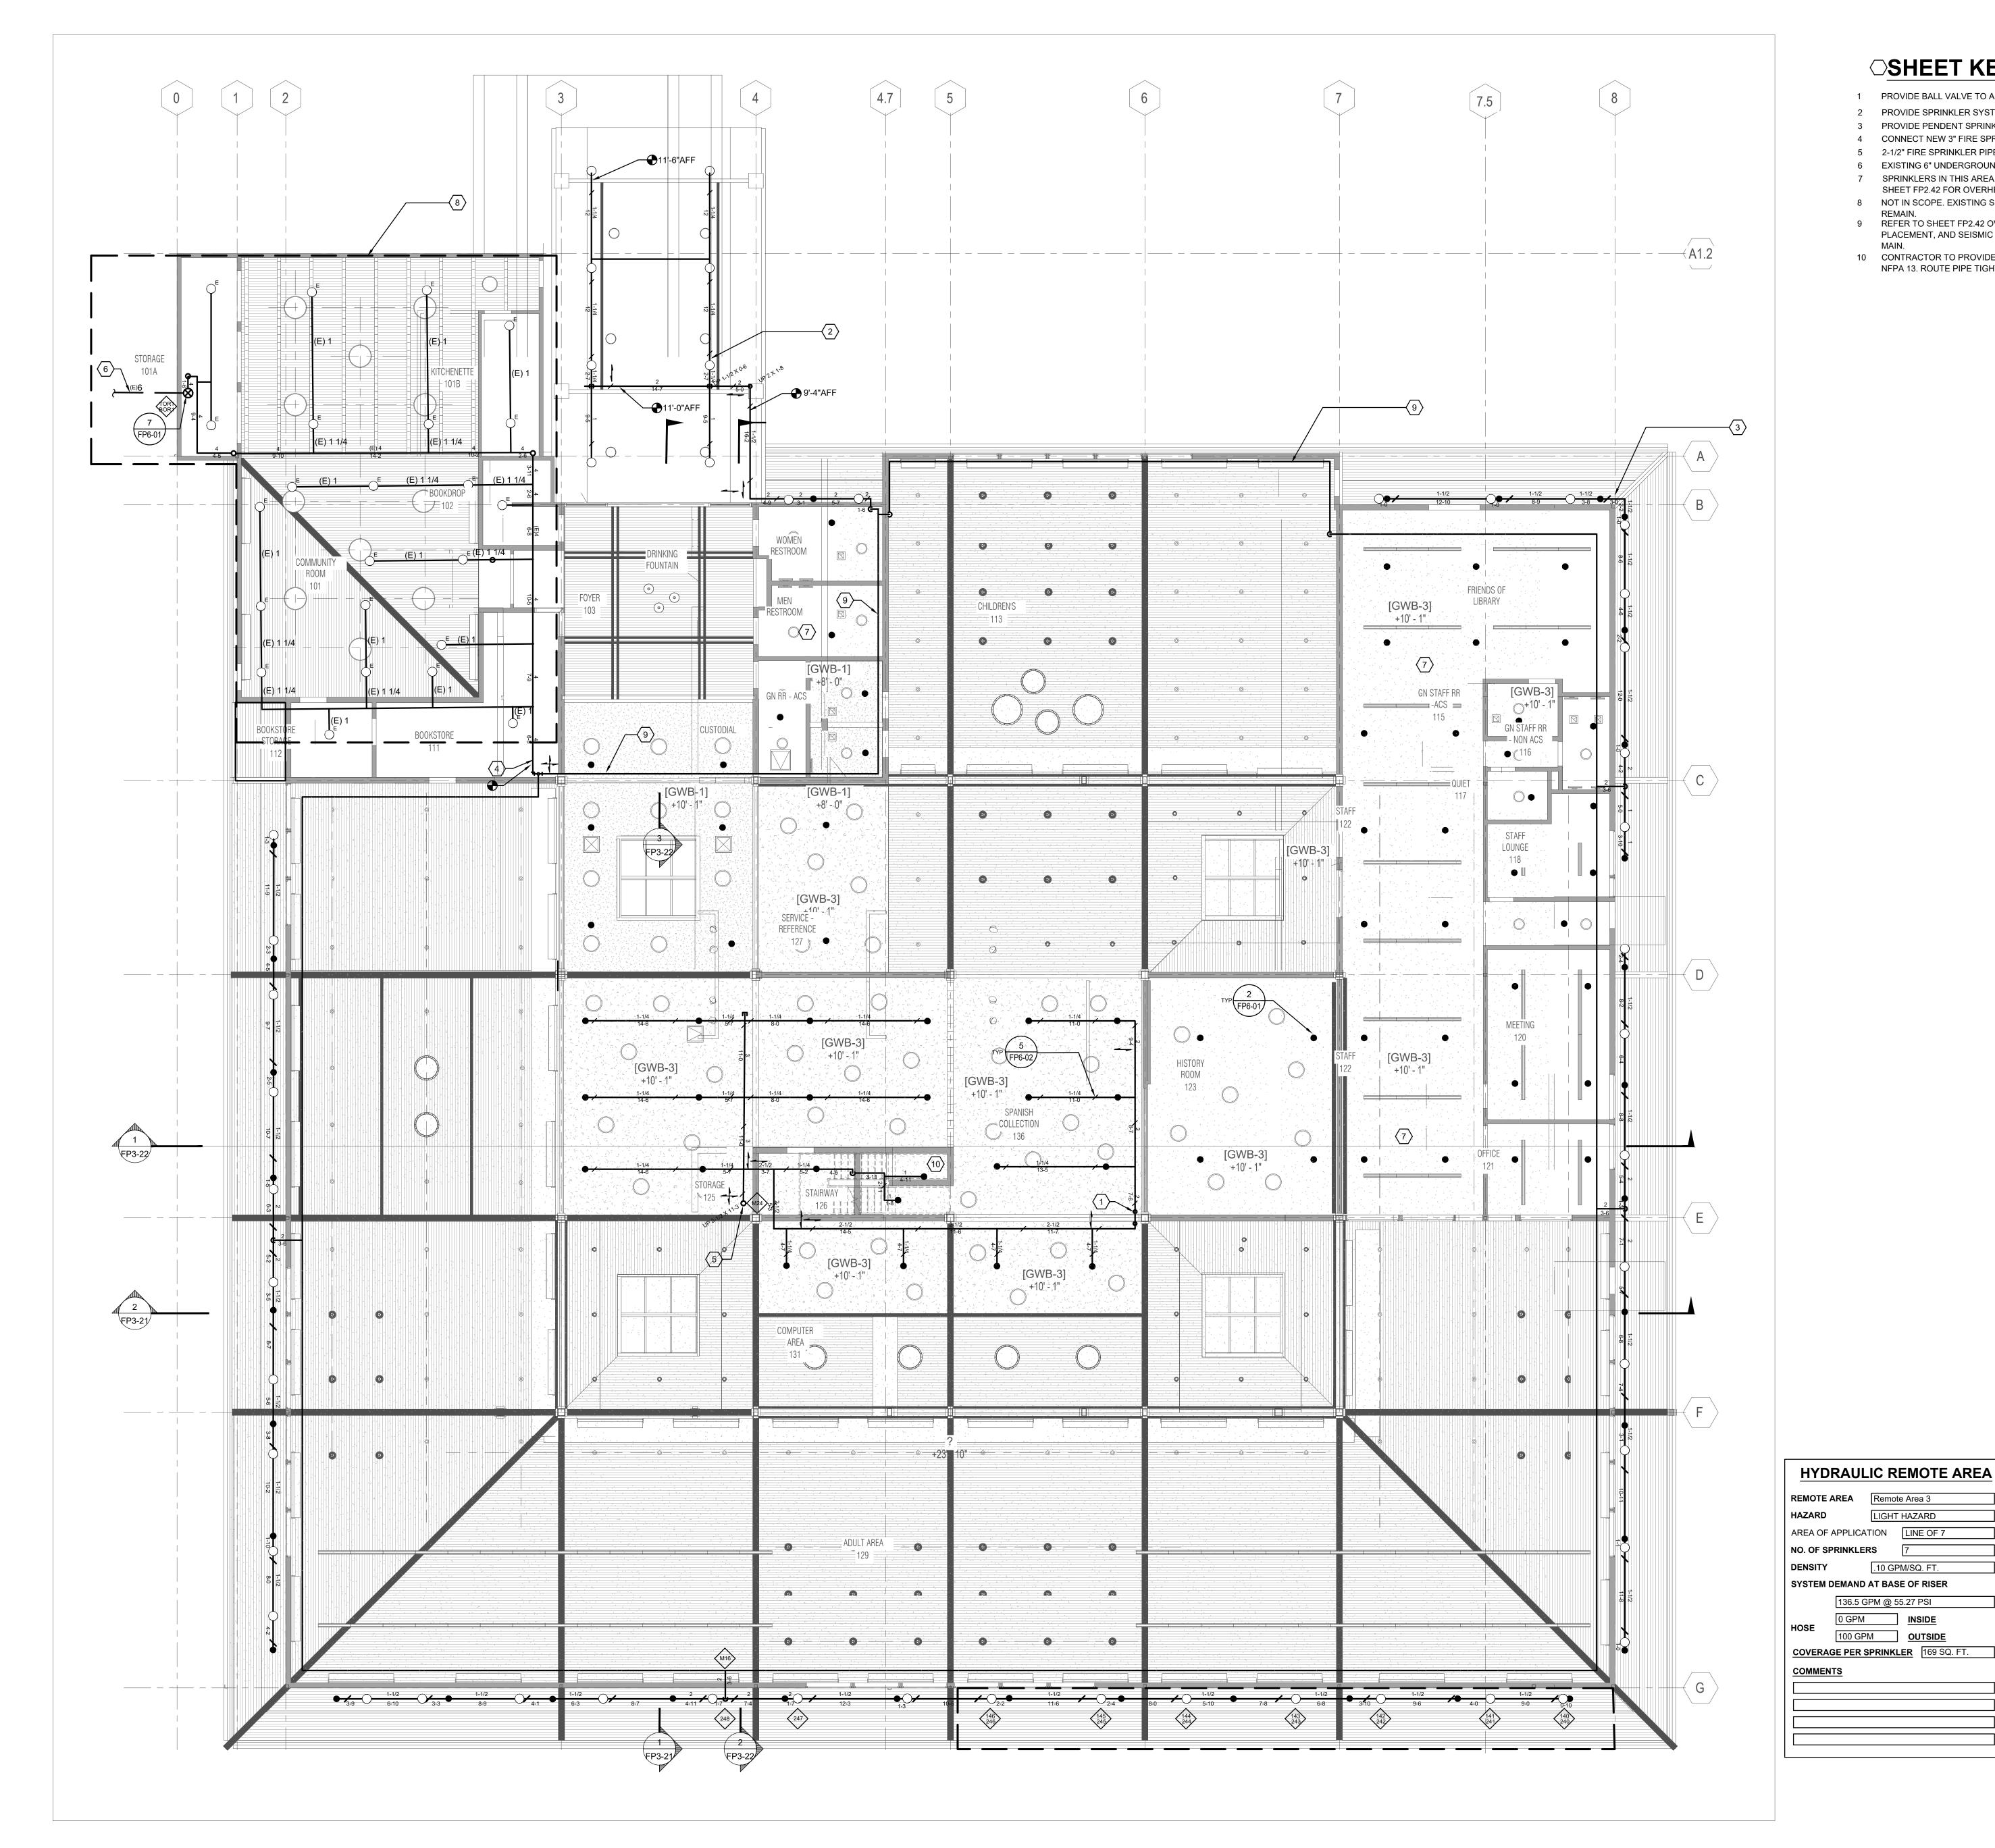

# **SHEET KEYNOTES**

- 1 PROVIDE BALL VALVE TO ALLOW PIPE TO DRAIN.
- 2 PROVIDE SPRINKLER SYSTEM PROTECTION WITHIN ENTRY CANOPY. 3 PROVIDE PENDENT SPRINKLERS OFF OF MAIN UNDER EXTERIOR OVERHANG. 4 CONNECT NEW 3" FIRE SPRINKLER MAIN TO EXISTING 4" FIRE SPRINKLER PIPE. 5 2-1/2" FIRE SPRINKLER PIPE UP TO FEED OVERHEAD LEVEL MEZZANINE SPRINKLERS. 6 EXISTING 6" UNDERGROUND FIRE SERVICE LINE FROM CITY MAIN. REFER TO CIVIL.
- SHEET FP2.42 FOR OVERHEAD CEILING PLAN. 8 NOT IN SCOPE. EXISTING SPRINKLERS AND PIPING IN ADDITION ARE EXISTING TO

7 SPRINKLERS IN THIS AREA ARE FED FROM BRANCH LINES ABOVE. REFER TO

- 9 REFER TO SHEET FP2.42 OVERHEAD PLAN FOR PIPE DIMENSIONS, HANGER PLACEMENT, AND SEISMIC BRACING PLACEMENT ON NEW LOOPED 3" SPRINKLER
- 10 CONTRACTOR TO PROVIDE SPRINKLER COVERAGE IN COMBUSTIBLE STAIR PER NFPA 13. ROUTE PIPE TIGHT TO UNDERSIDE OF STAIR.

ARCHITECTS

729 Heinz Avenue Berkeley, CA 94710 tel 510.542.2200 fax 510.542.2201



INTERFACE ENGINEERING PROJECT 2020-0484

CONTACT JON SCHLITZ 135 Main Street, Suite 400 San Francisco, CA 94105 TEL 415.489.7240 www.interfaceengineering.com

PROJECT TITLE

**SONOMA COUNTY PETALUMA** REGIONAL **LIBRARY** RENOVATION PROJECT NO.

100 FAIRGROUNDS DRIVE PETALUMA, CA 94952

**PERMIT SET** 

N&T JOB NUMBER # DATE DESCRIPTION

SHEET TITLE

REFLECTED CEILING PLAN - FINISHED CEILINGS (LOWER) - FIRE PROTECTION

SHEET NUMBER


FP2.41

APPROVALS

LIGHT HAZARD

.10 GPM/SQ. FT.

SCALE: 1/8"=1'-0"

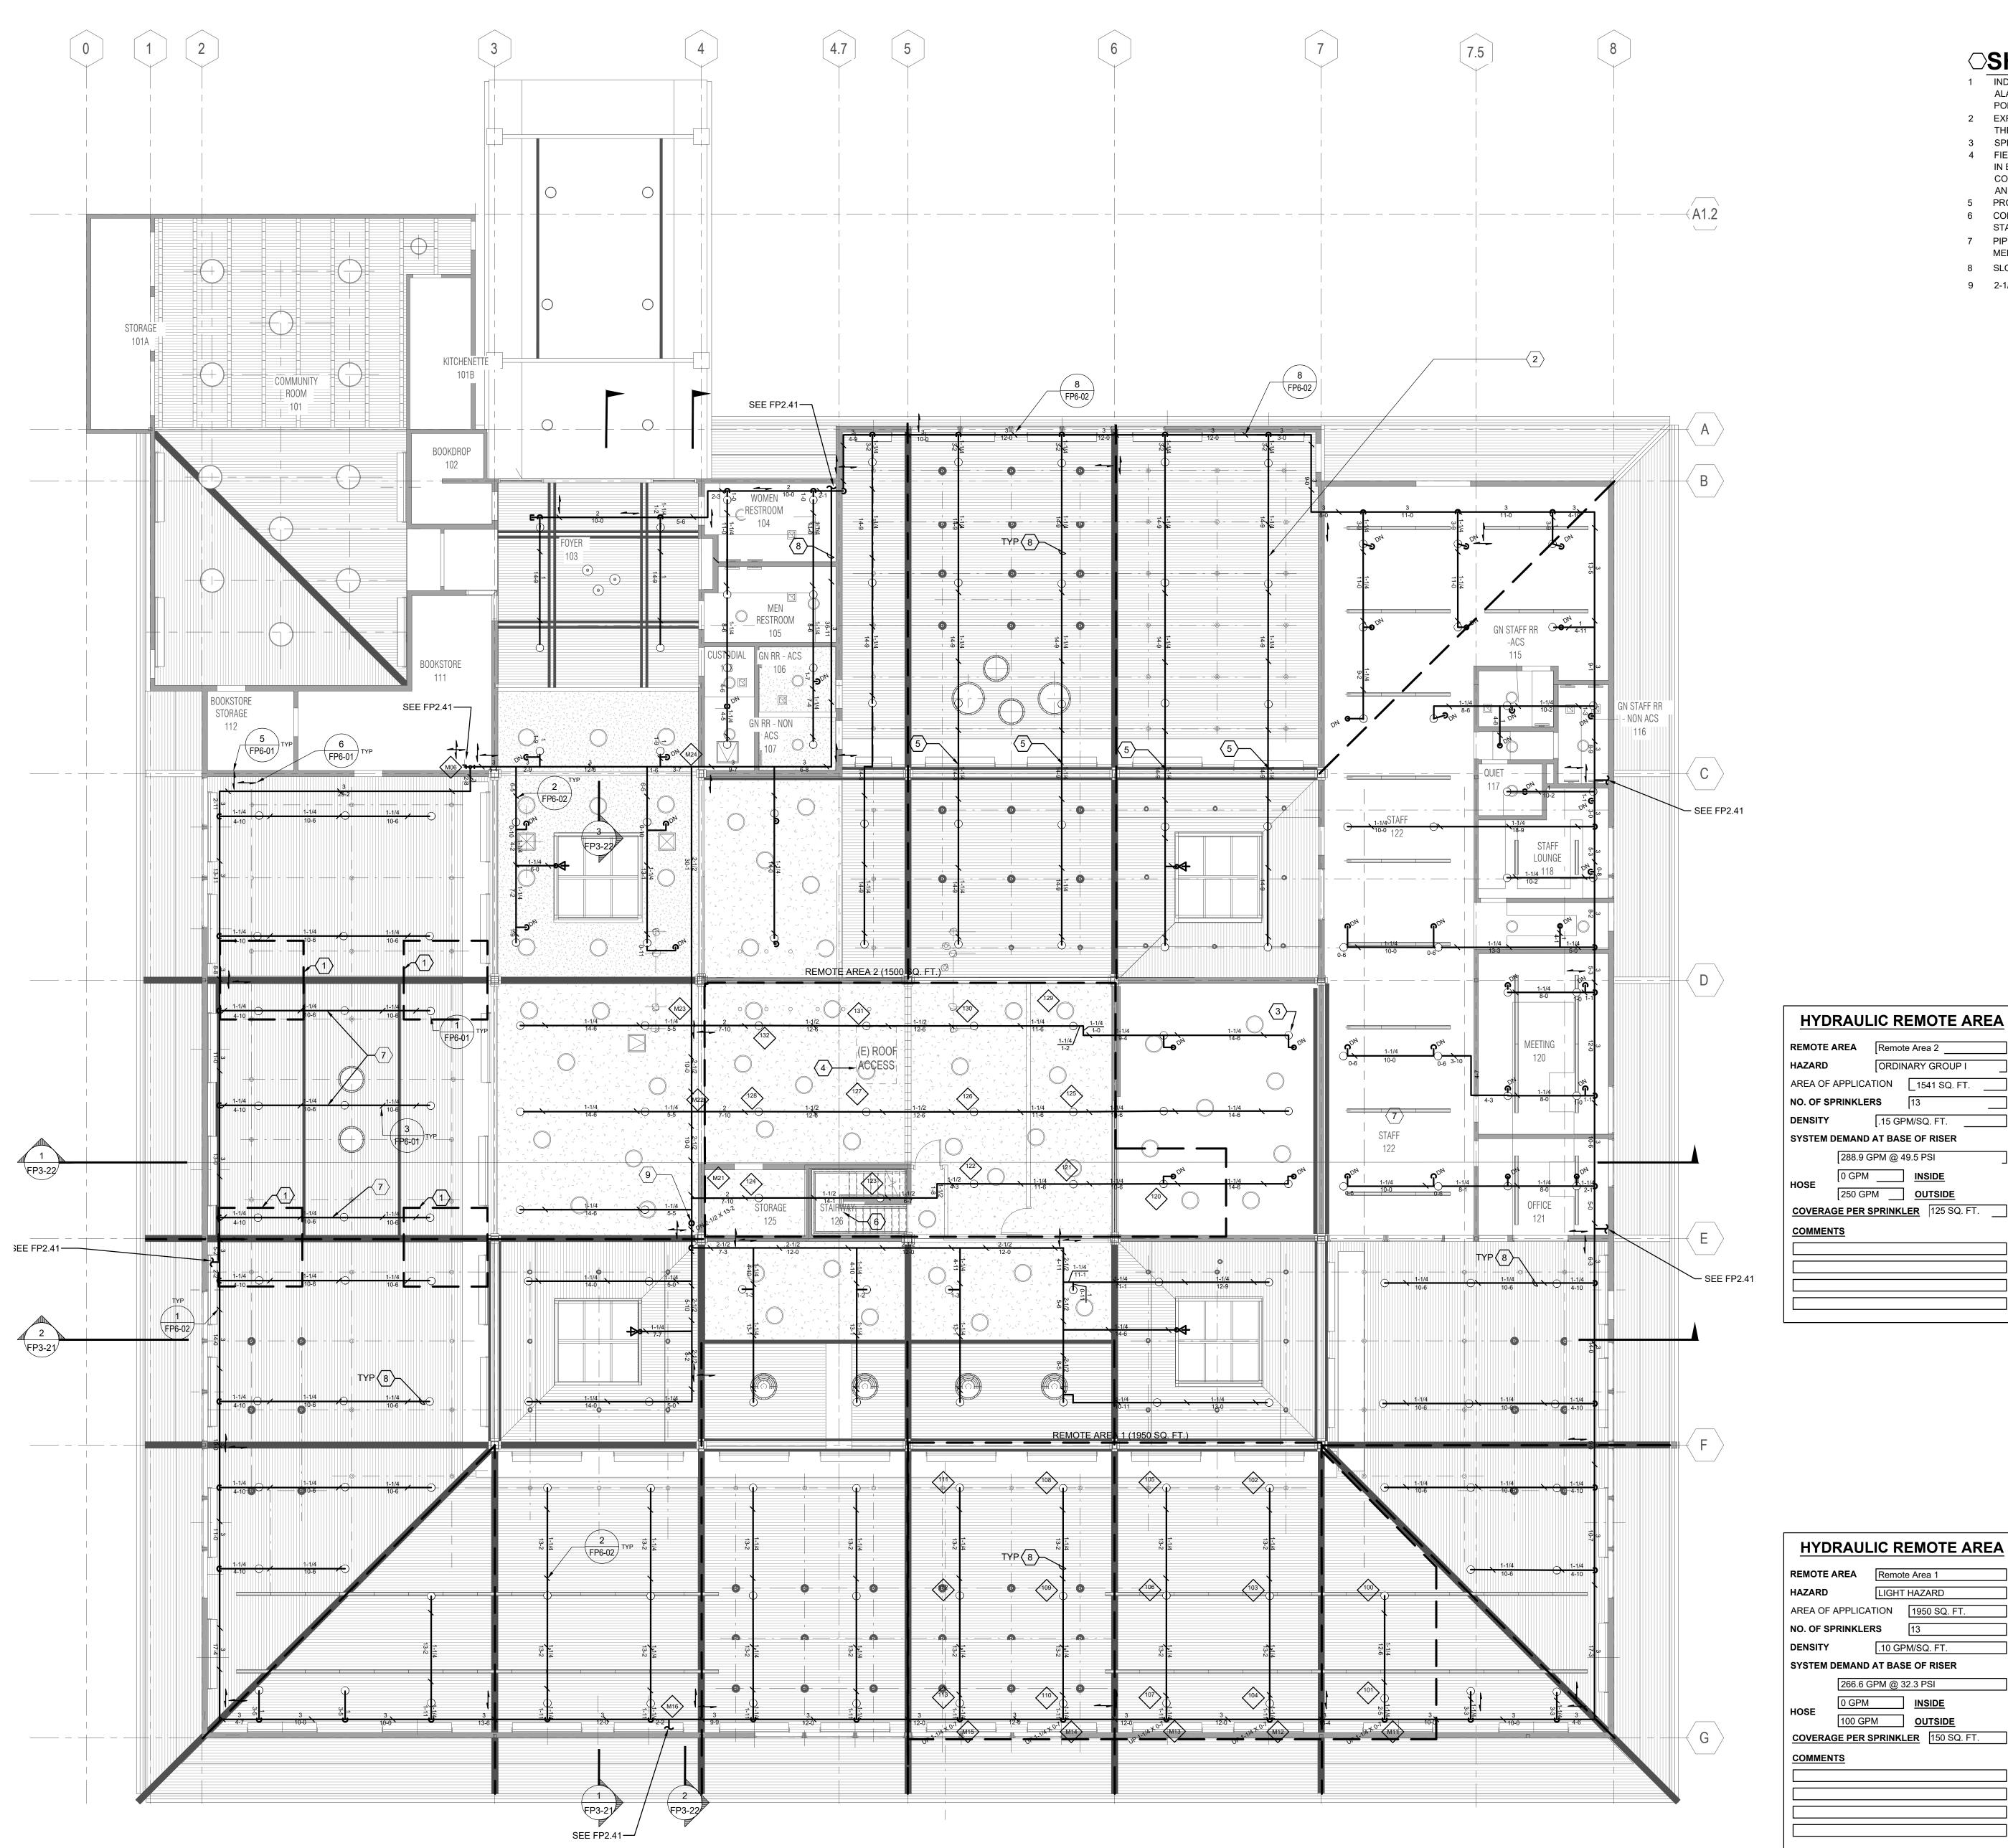

- 1 INDIVIDUAL READING PODS HAVE AN AUTOMATIC ROOF THAT OPENS ON ACTIVATION OF FIRE ALARM SYSTEM. NO SPRINKLERS REQUIRED IN PODS. OVERHEAD SYSTEM WILL PROTECT
- PODS FROM ABOVE. 2 EXPOSED UPRIGHT SPRINKLERS IN AREAS OF THE BUILDING OPEN TO
- THE STRUCTURE ABOVE.

SPRINKLERS IN COMBUSTIBLE CONCEALED SPACE ABOVE CEILING.

- 4 FIELD VERIFY EXISTING CEILING CONDITIONS. PROVIDE AN ALLOWANCE IN BID FOR EXTRA PIPE AND FITTINGS THAT ARE NEEDED FOR FIELD COORDINATION WITH EXISTING HVAC AND ELECTRICAL IN THE ATTIC
- AND MEZZANINE SPACES. 5 PROVIDE SWING JOINT TO ALLOW PIPE TO MAKE TURN TO FLAT AREA.
- 6 CONTRACTOR TO PROVIDE SPRINKLER COVERAGE IN COMBUSTIBLE STAIR PER NFPA 13.
- 7 PIPE HANGERS TO BE ATTACHED TO NEW STRUCTURAL FRAMING MEMBERS IN THIS AREA. REFER TO STRUCTURAL PLANS.
- 8 SLOPE PARALLEL TO SLOPE OF CEILING.
- 9 2-1/2" FIRE SPRINKLER PIPE FEED FROM OVERHEAD PIPING SYSTEM.

**SHEET KEYNOTES** 

ARCHITECTS

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fax 510.542.2201





PROJECT 2020-0484 CONTACT JON SCHLITZ 135 Main Street, Suite 400 San Francisco, CA 94105 TEL 415.489.7240

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100 FAIRGROUNDS DRIVE PETALUMA, CA 94952

**PERMIT SET** 

N&T JOB NUMBER REVISIONS # DATE DESCRIPTION


SHEET TITLE


REFLECTED CEILING PLAN - OVERHEAD VAULTED CEILINGS - FIRE PROTECTION

SHEET NUMBER

FP2.42

APPROVALS

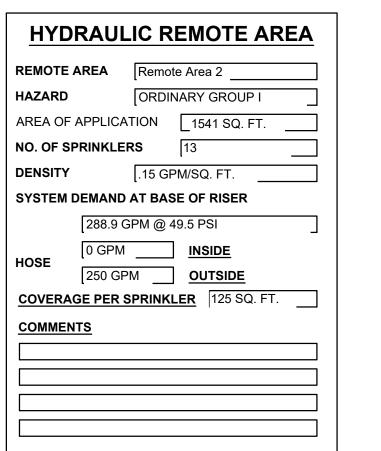


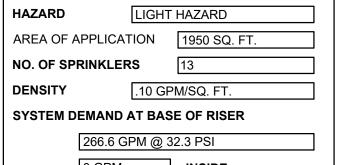

100 GPM OUTSIDE COVERAGE PER SPRINKLER 150 SQ. FT.

REFLECTIVE CEILING PLAN - FIRE PROTECTION

SCALE: 1/8"=1'-0" SCALE: 1/8"=1'-0"

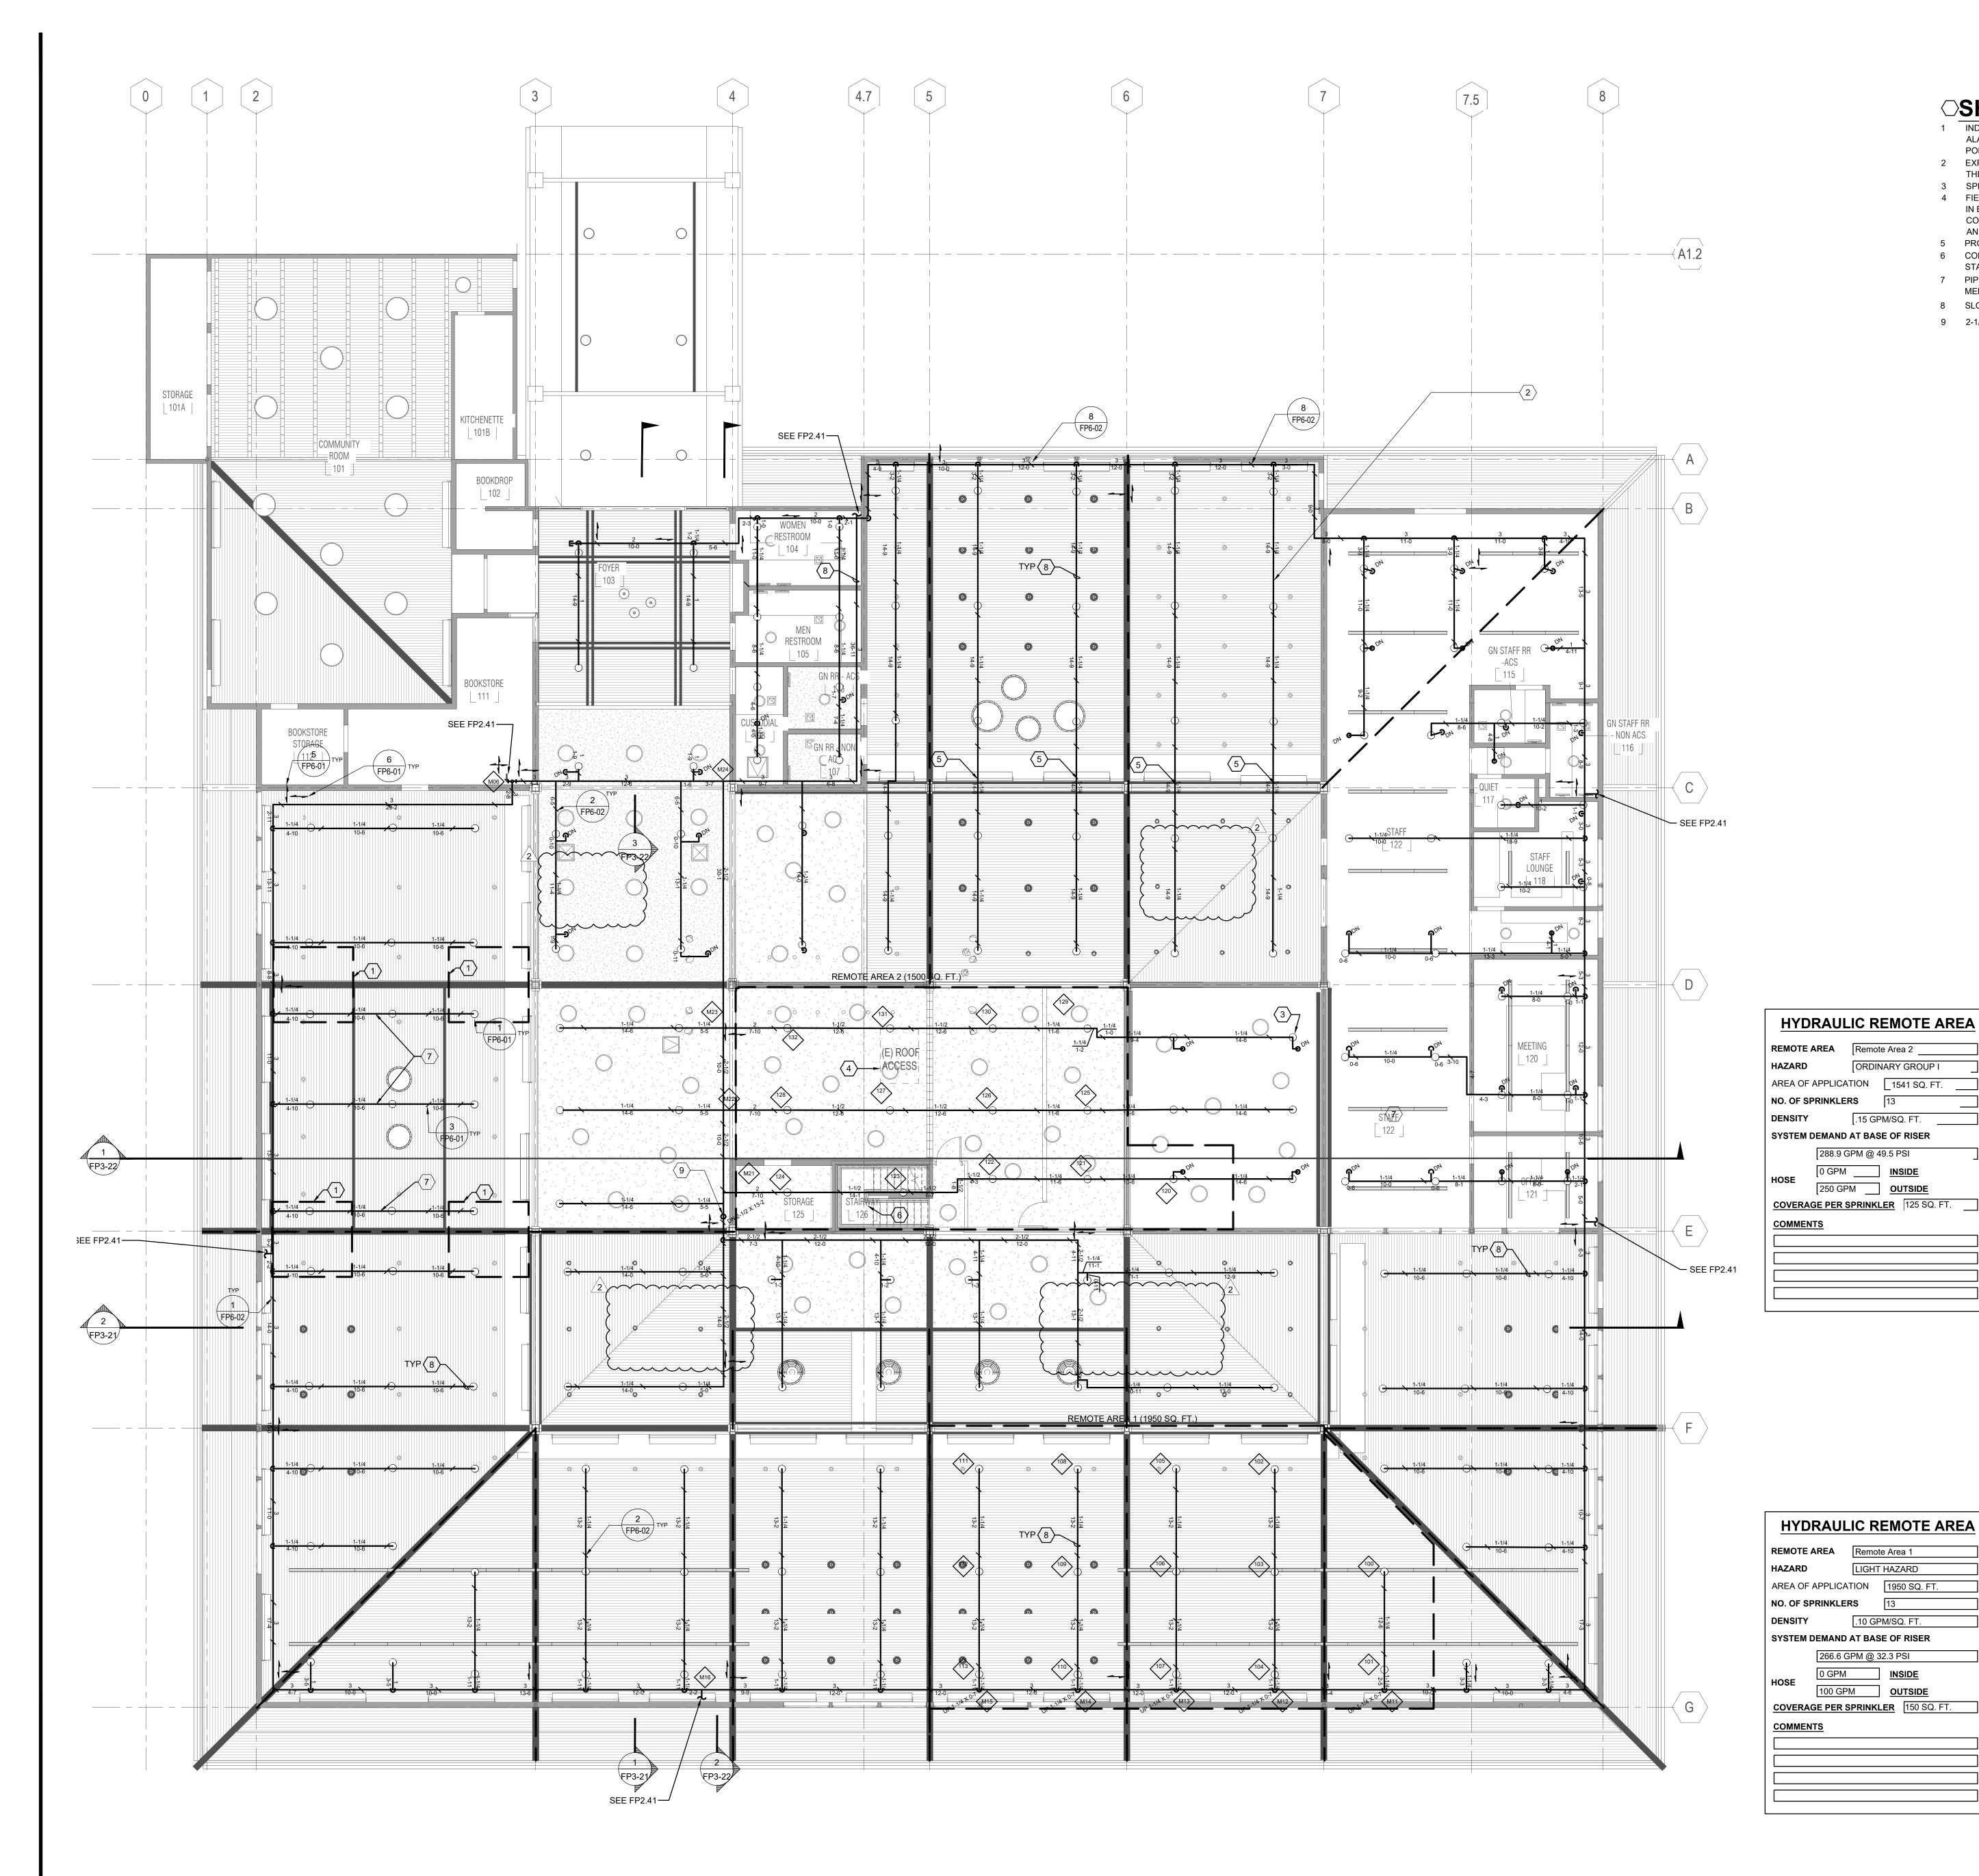


# **SHEET KEYNOTES**

- 1 INDIVIDUAL READING PODS HAVE AN AUTOMATIC ROOF THAT OPENS ON ACTIVATION OF FIRE ALARM SYSTEM. NO SPRINKLERS REQUIRED IN PODS. OVERHEAD SYSTEM WILL PROTECT
- PODS FROM ABOVE. 2 EXPOSED UPRIGHT SPRINKLERS IN AREAS OF THE BUILDING OPEN TO
- THE STRUCTURE ABOVE.
- SPRINKLERS IN COMBUSTIBLE CONCEALED SPACE ABOVE CEILING. 4 FIELD VERIFY EXISTING CEILING CONDITIONS. PROVIDE AN ALLOWANCE IN BID FOR EXTRA PIPE AND FITTINGS THAT ARE NEEDED FOR FIELD COORDINATION WITH EXISTING HVAC AND ELECTRICAL IN THE ATTIC
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**PERMIT SET** 

N&T JOB NUMBER

REVISIONS

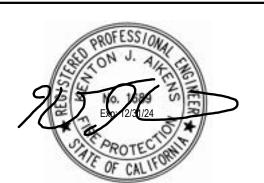DATE DESCRIPTION

2 4/25/2024 RESUBMITTAL 2 DESCRIPTION

REFLECTED CEILING PLAN - OVERHEAD VAULTED CEILINGS **DEDUCT ALTERNATE #1** - FIRE PROTECTION

SHEET NUMBER


FP2.42A

APPROVALS

REFLECTIVE CEILING PLAN - FIRE PROTECTION

SCALE: 1/8"=1'-0" SCALE: 1/8"=1'-0"



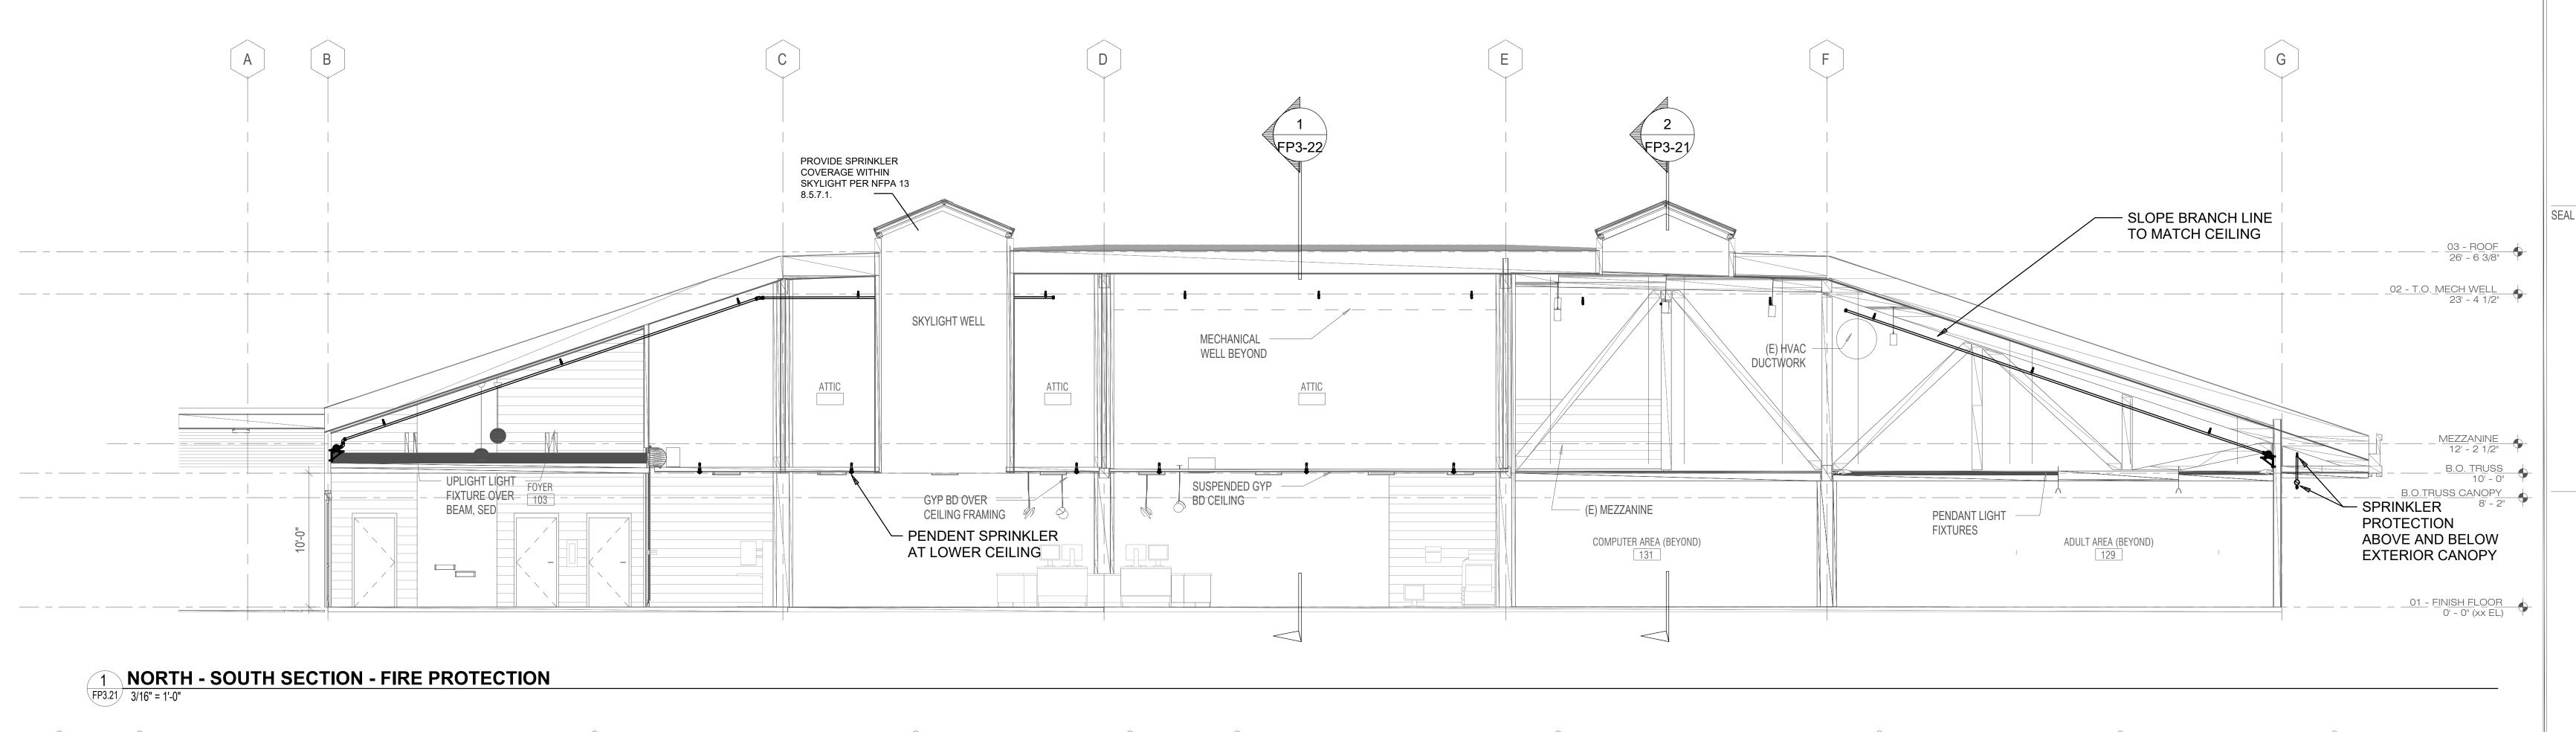



PROJECT TITLE

SONOMA COUNTY **PETALUMA REGIONAL LIBRARY RENOVATION** PROJECT NO. 10-19

ARCHITECTS

729 Heinz Avenue Berkeley, CA 94710 tel 510.542.2200 fax 510.542.2201

100 FAIRGROUNDS DRIVE PETALUMA, CA 94952

**PERMIT SET** 


11/27/2023 ISSUE DATE N&T JOB NUMBER REVISIONS # DATE DESCRIPTION

SHEET TITLE

BUILDING SECTIONS
- FIRE PROTECTION


SHEET NUMBER

FP3.21

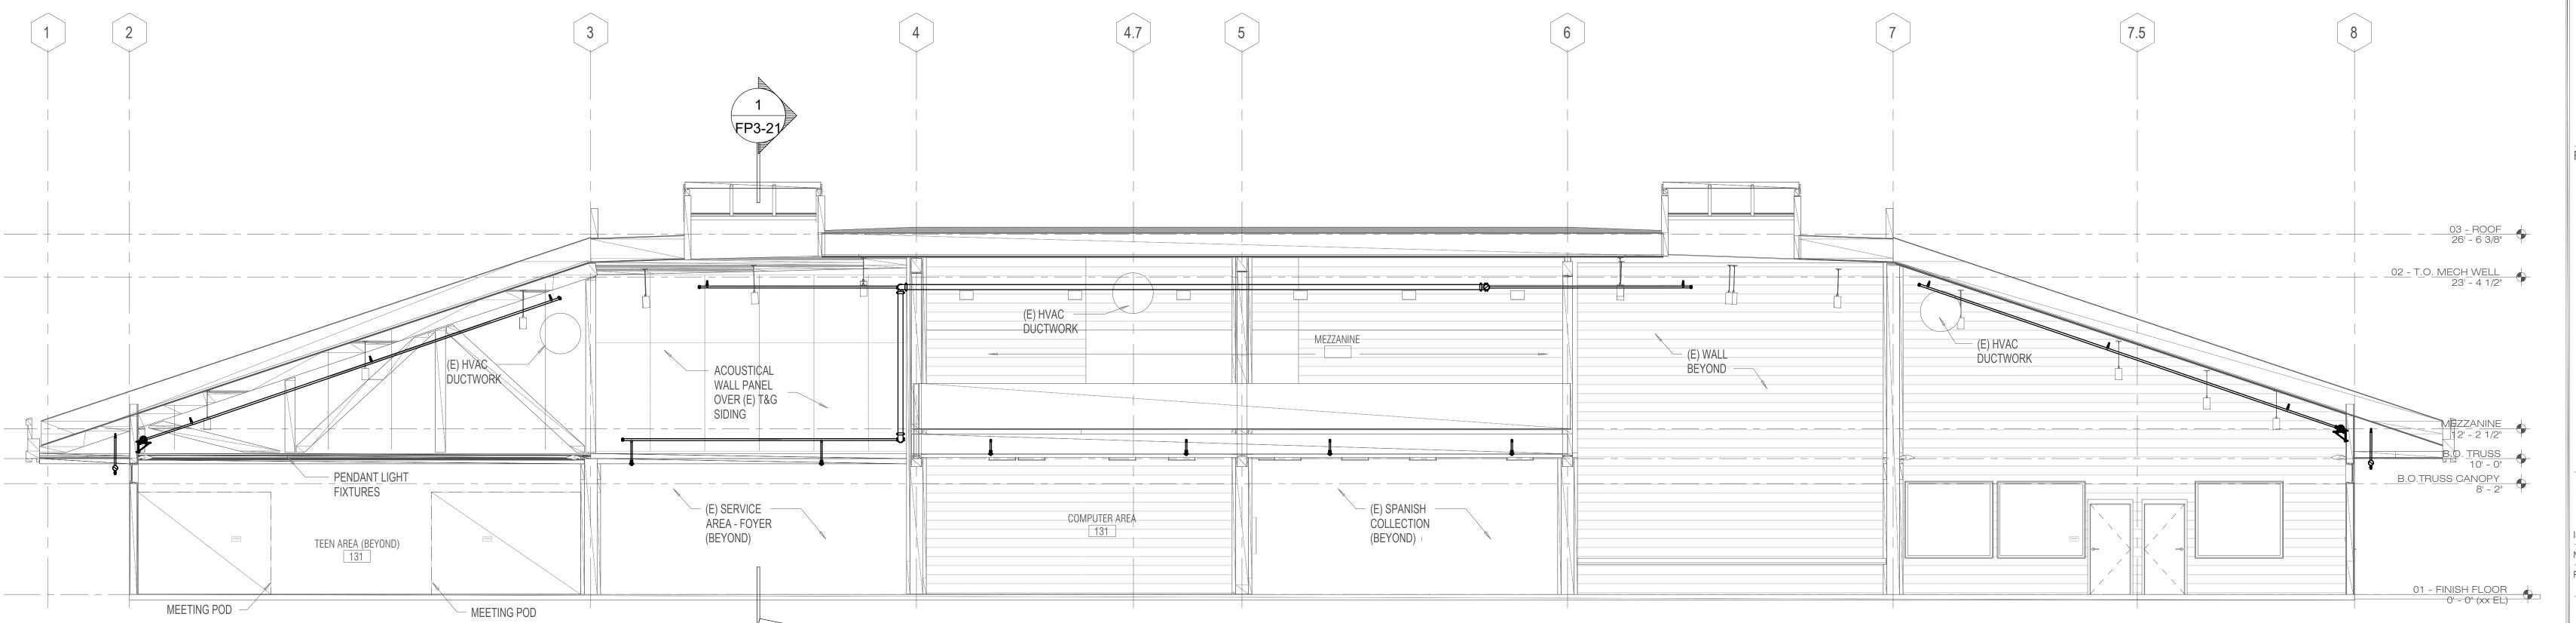


2 EAST-WEST SECTION - FIRE PROTECTION

FP3.21 3/16" = 1'-0"

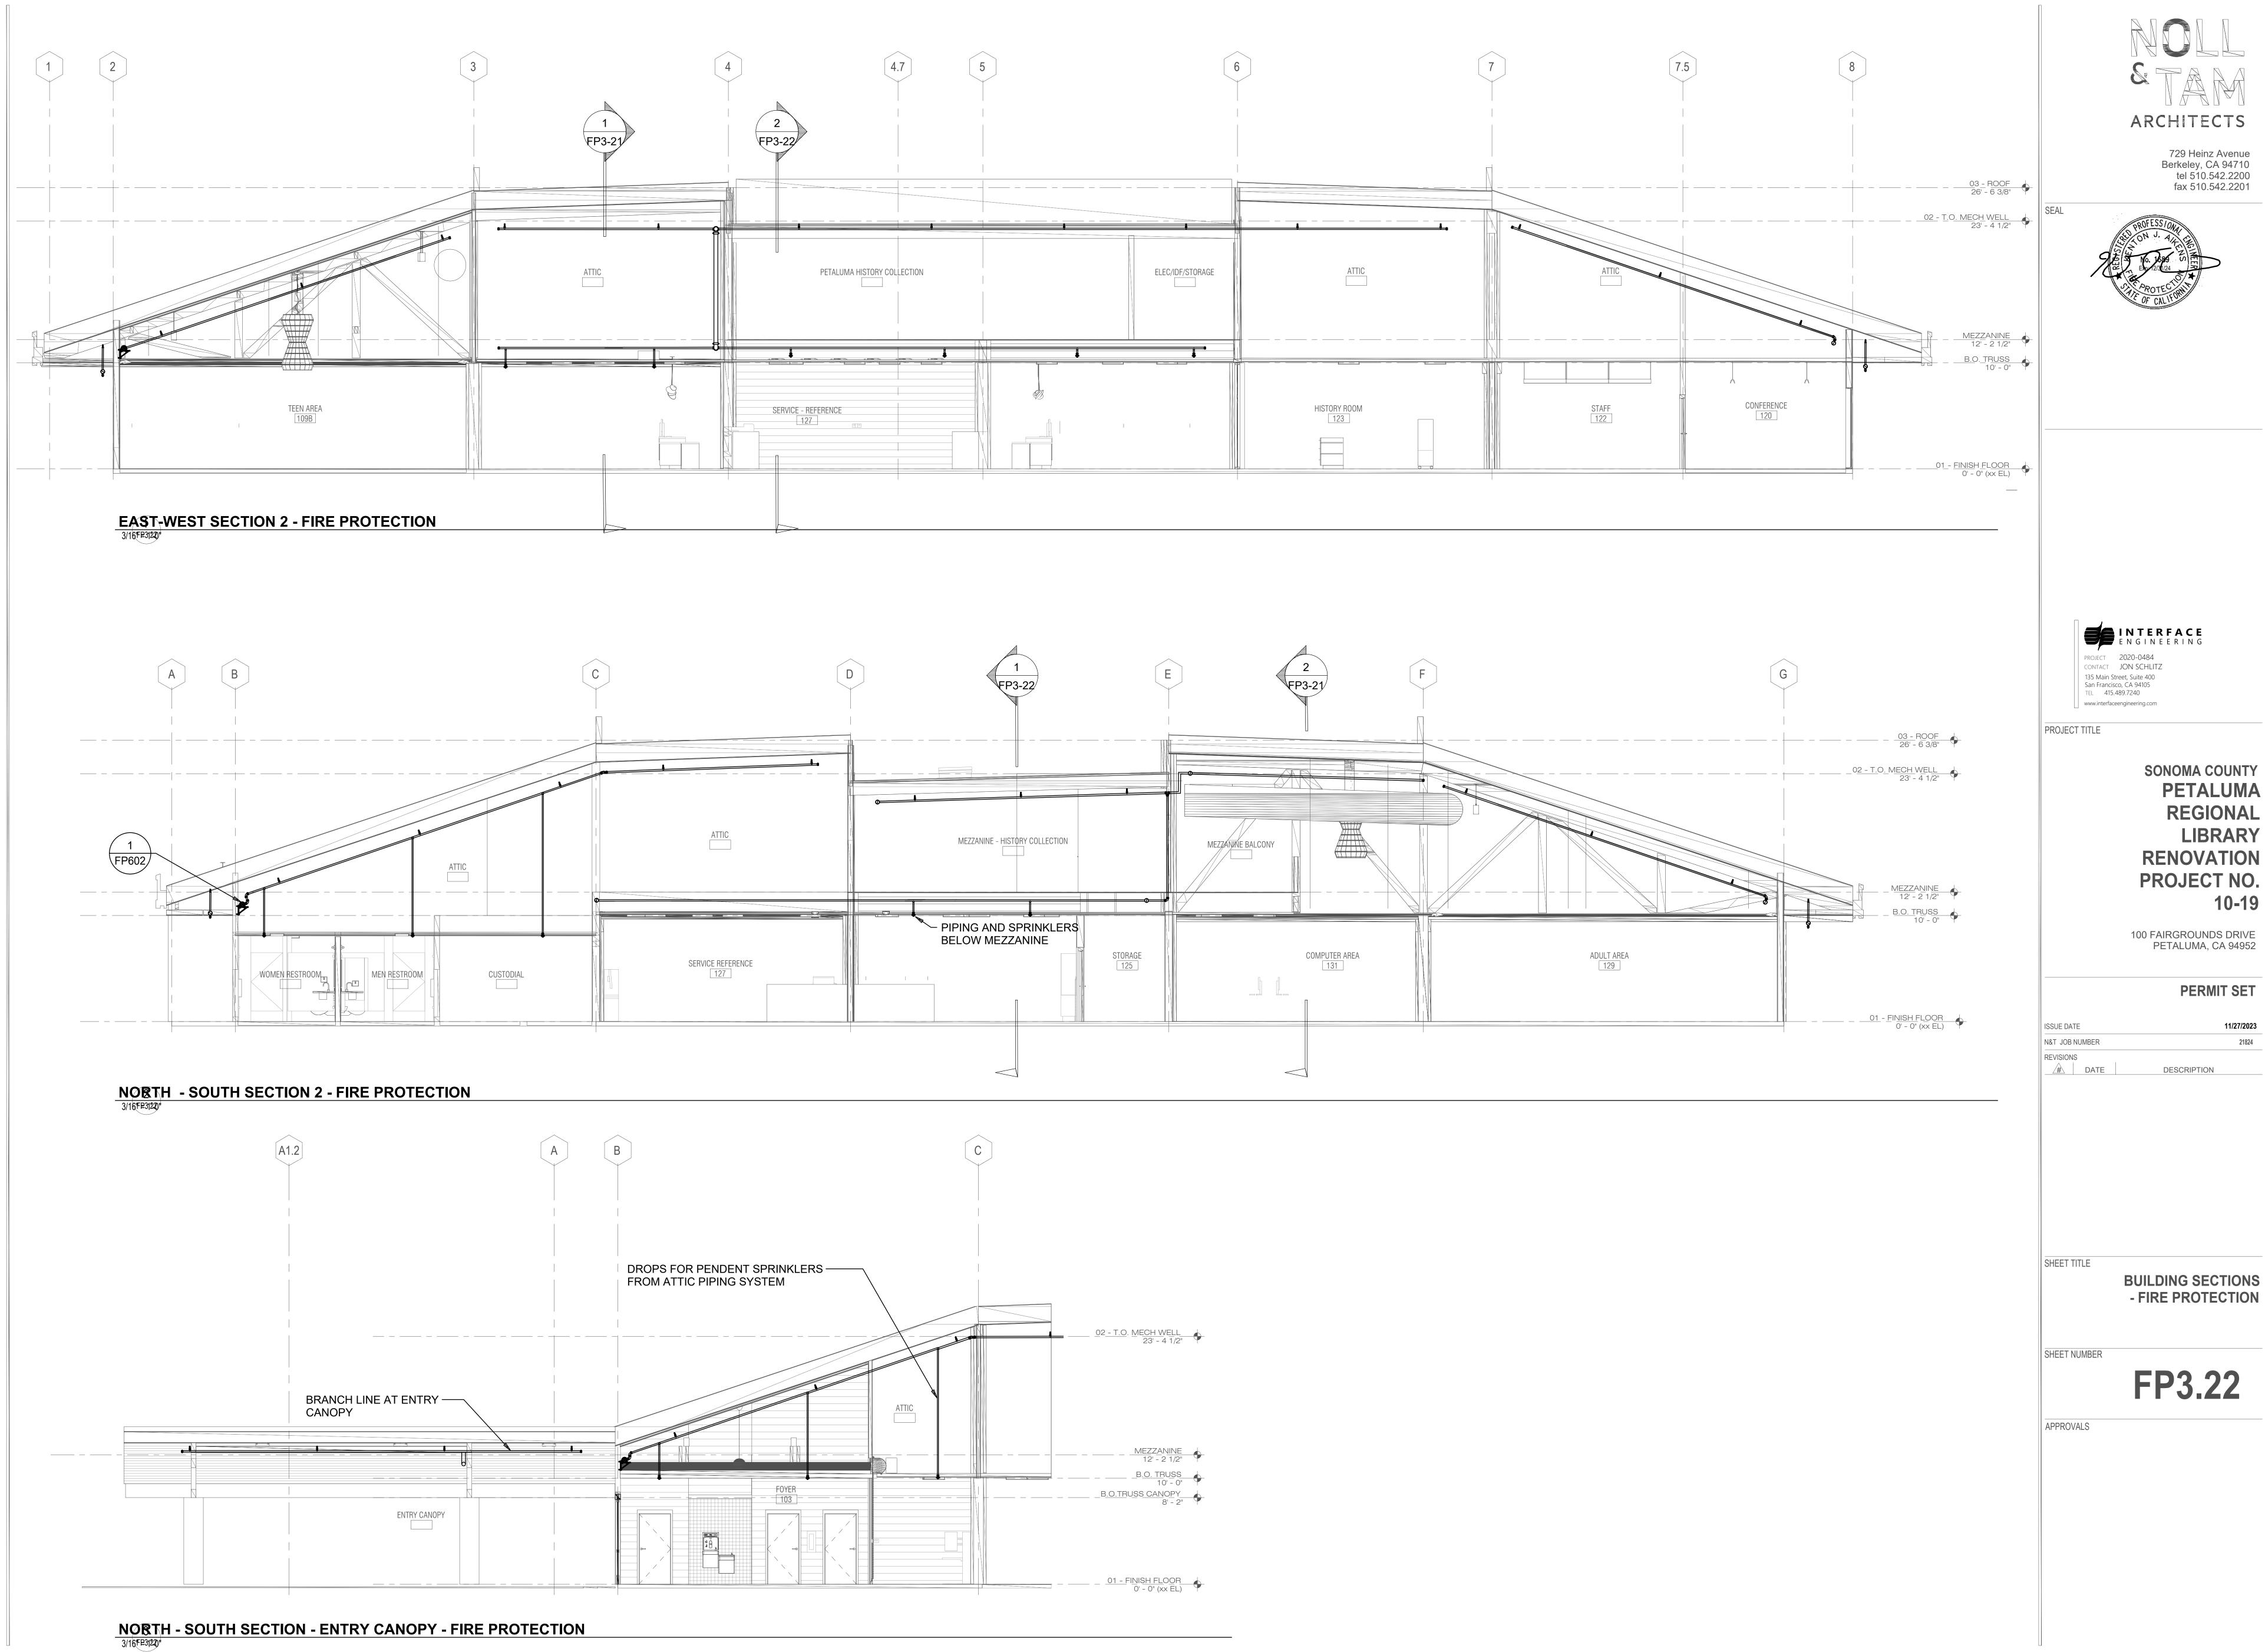


SONOMA COUNTY **PETALUMA REGIONAL LIBRARY RENOVATION** PROJECT NO. 10-19

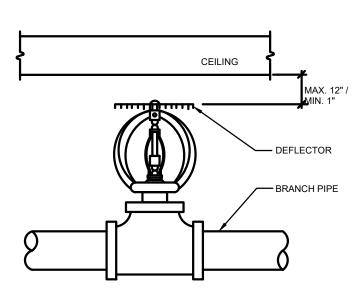


# **UPRIGHT HEAD ON TEE**

NO SCALE

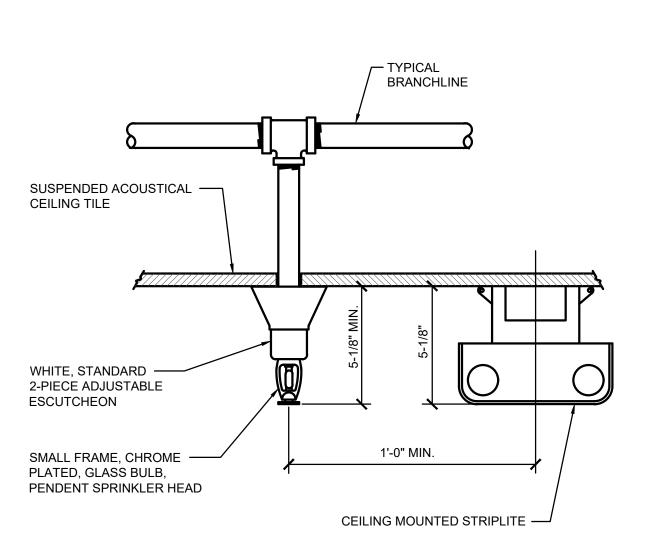


### 2 SPRINKLER WITH 2-PC ESCUTCHEON

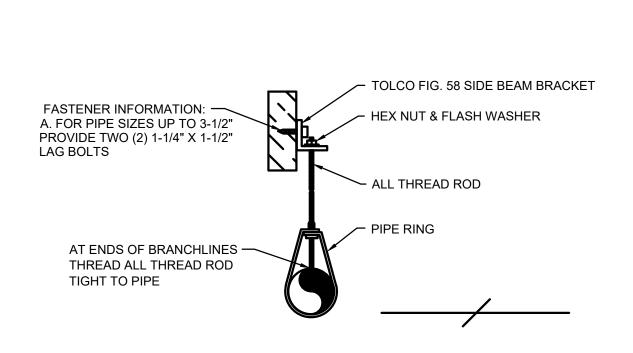


# SIDE BEAM BRACKET HANGER AT BEAM

NO SCALE

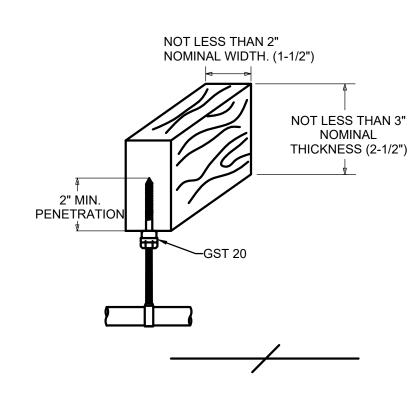


# "SAMMY" AT HEAVY TIMBER OR GLB

NO SCALE

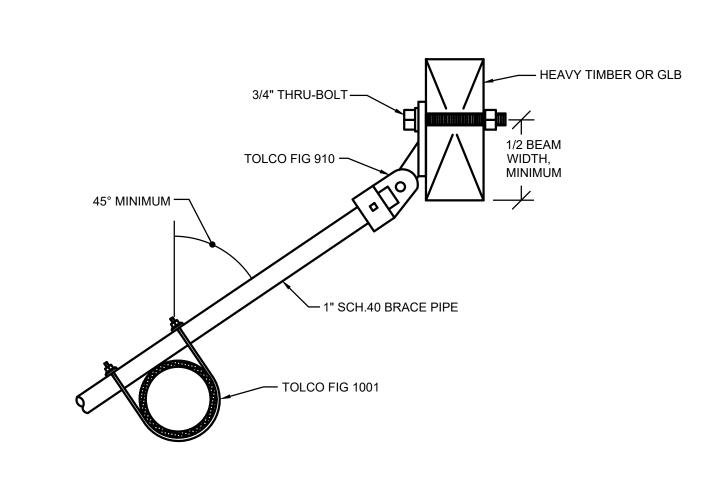


# SEISMIC DETAIL - LATERAL BRACE

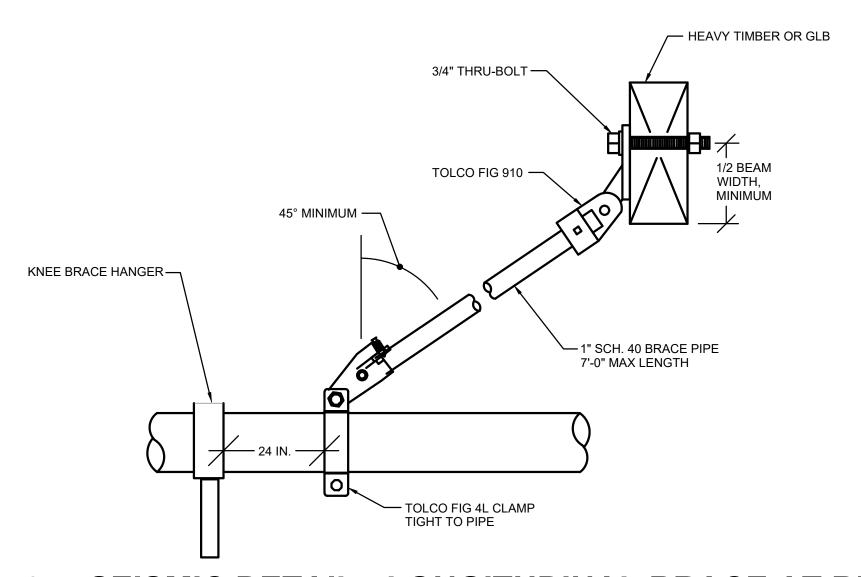

# SEISMIC DETAIL - LONGITUDINAL BRACE AT BEAM

NO SCALE

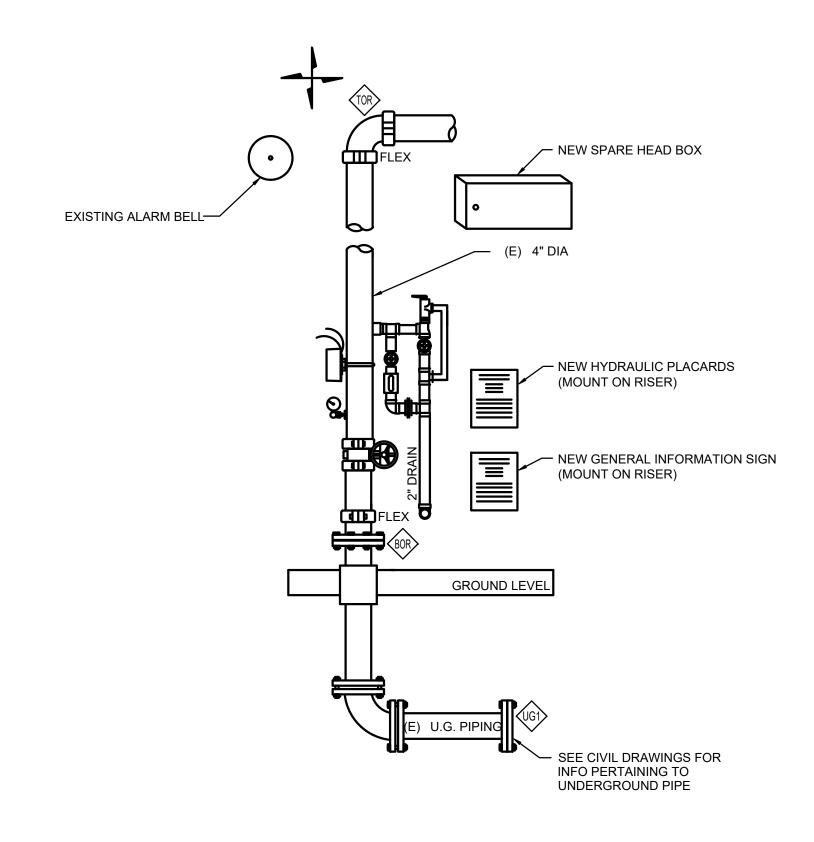

# **EXISTING WET SPRINKLER RISER**



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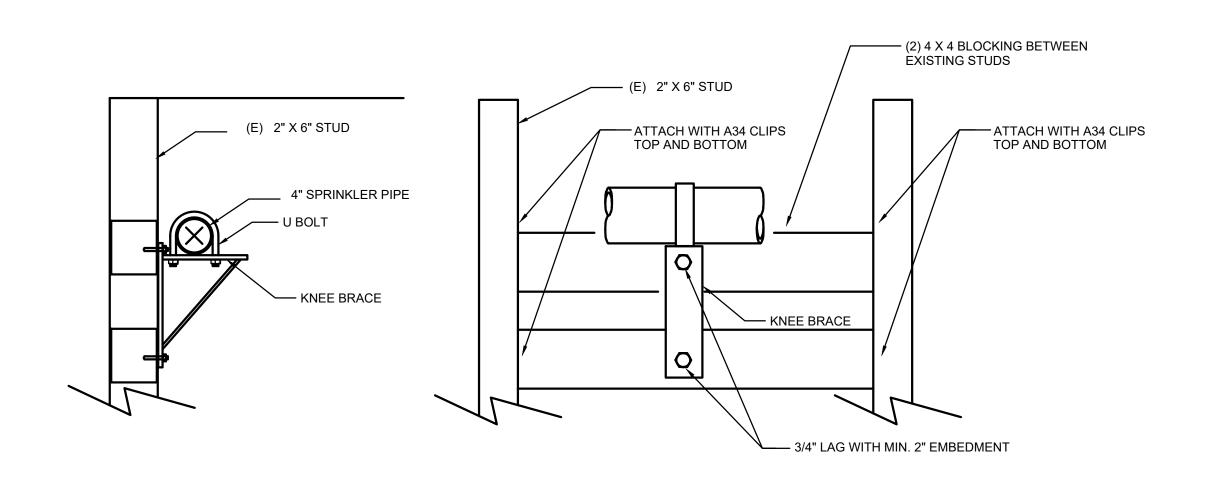
N&T JOB NUMBER DESCRIPTION

SHEET TITLE


**DETAILS - FIRE PROTECTION** 

SHEET NUMBER


FP6.01




1 KNEE BRACE AT WALL
NO SCALE

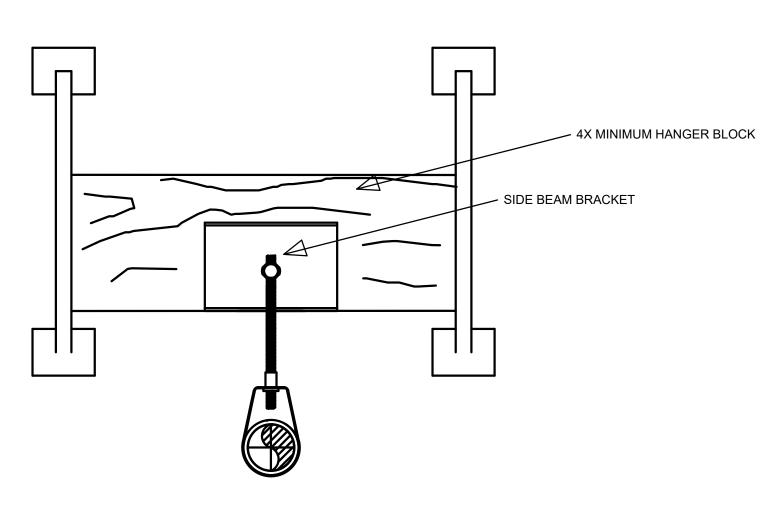


4 TJI JOIST SIDE BEAM BRACKET HANGER
NO SCALE

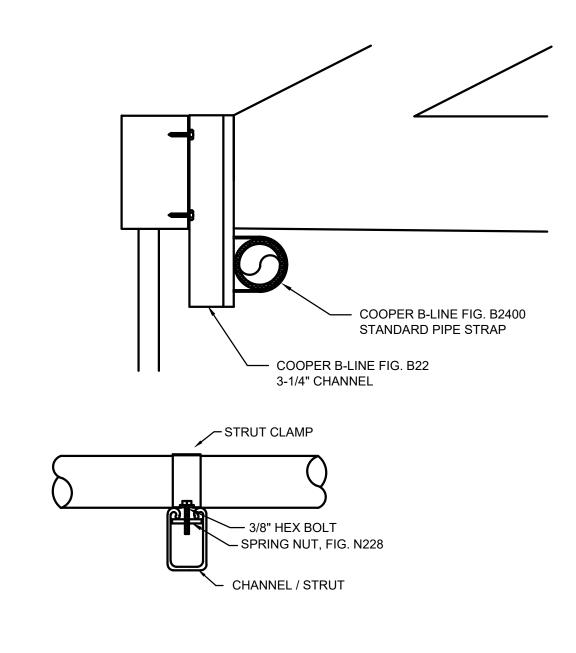

8 CHILDRENS LIBRARY HANGER AT WALL

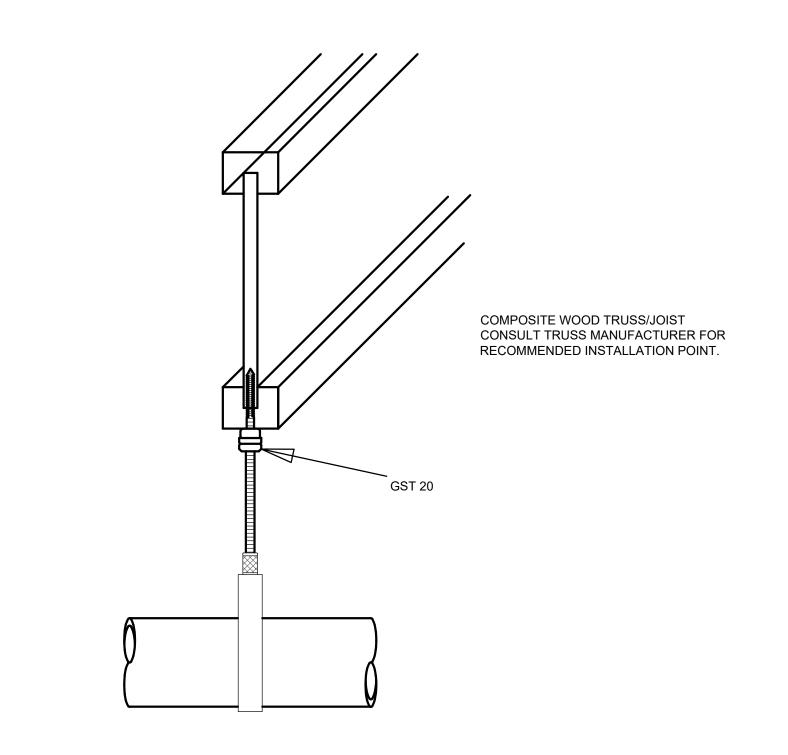

2 TJI JOIST HANGER IN ATTIC
NO SCALE

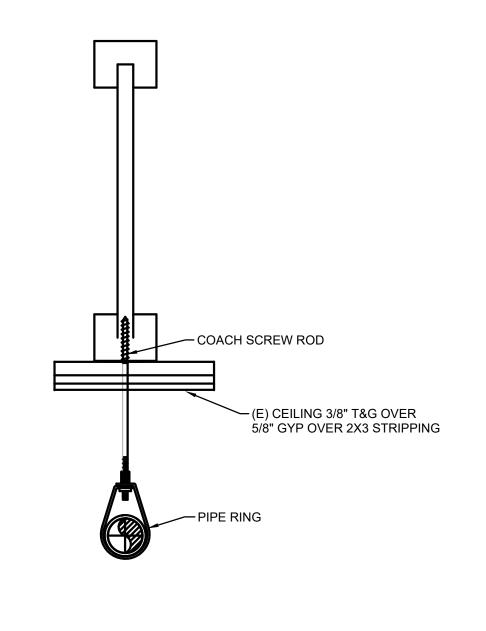

5 COACH SCREW ROD BELOW T&G CEILINGS



3 BRANCH LINE RESTRAINT AT ATTIC SPACES



